

ENLARGED VIEW

PREPARED BY



CITY OF ROCHESTER, NEW YORK

DEPARTMENT OF ENVIRONMENTAL SERVICES



50% PROGRESS PLANS

PORT OF ROCHESTER MARINA DEVELOPMENT PROJECT

THE CONTRACTOR IS TO USE THE CITY OF ROCHESTER STANDARD DETAILS, EXCEPT FOR THOSE DELINEATED WITHIN THE CONTRACT PLANS. THE DETAILS DELINEATED WITHIN THE CONTRACT PLANS SUPERSEDE THE STANDARD DETAIL.

3. THE CONTRACTOR IS TO OBTAIN WORK RELEASES FROM THE RESPECTIVE PROPERTY OWNER WHERE WORK IS TO BE PERFORMED OUTSIDE OF THE PUBLIC RIGHT-OF-WAY, ON PRIVATELY OWNED PROPERTY. A COPY OF THE WORK RELEASE IS TO BE FILED WITH THE PROJECT MANAGET.

4 THE LOCATIONS OF EXISTING LITHLITIES SHOWN IN THE PLANS ARE APPROXIMATE ONLY THE LUCATIONS OF EXISTING DITLITES SHOWN IN THE PLANS AHE APPHOXIMATE ONLY. NOR ARE THEY GURARATIZED TO BE ACCURATE OF COMPLETE, ALL UITLITES WHER PLOTTED FROM HELD SURFACE SURVEY DATA AND IN CONJUNCTION WITH RECORD MAPPING SUPPLIED BY THE RESPECTIVE UTILITY COMPANY. IT IS THE RESPONSIBILITY OF THE CONTRACTOR TO VERFY THE LOCATION OF ALL UITLITIES LOCATED WITHIN THE WORK AREA. TO THE CONTRACTORS'S ANISFACTION, THE CONTRACTOR IS TO REQUEST A UITLITY STAKE OUT A MINIMUM OF 2 WORKING DAYS IN ADVANCE OF COMMERCING ANY WORK, BY CALLING THE UNDERGROUND FACILITIES PROTECTIVE ORGANIZATION (UFPO). AT 1-800-962-7962.

5 ALL BIGHT-DE-WAY MONUMENTS AND PROPERTY CORNERS ARE TO BE SAFEGUARDED AND ALL HIGHT-DI-WAY MONUMENTS AND PROPERTY COTRIENS ARE TO BE SAFEGUARDED AND PRESERVED. ALL RIGHT-OF-WAY MONUMENTS OR PROPERTY CORNERS THAT ARE DISTUR BY THE CONTRACTOR DURING CONSTRUCTION ARE TO BE REPLACED BY A MYS LICENSED SURVEYOR, AT THE CONTRACTORS' EXPENSE.

6. SAW CUTS MADE IN THE ROADWAY ARE TO BE FULL DEPTH, WITH ALL OTHER SAW CUTS BRING A MINIMUM OF 2 INCHES IN DEPTH. FILL DEPTH PAVEMENT SAW CUTS WILL BE PAID FOR IN THE RESPECTIVE WORK RELIZED TIEM. ALL SAW CUTS ARE TO BE SALED WITH AN ASPHALT FILLER PER INYSDOT MATERIAL DESIGNATION 702-0700 OR 702-3401, THE COST OF WHICH IS TO BE INCLUDED IN THE UNIT PRICE BID FOR THE RESPECTIVE WORK RELATED ITEM.

7. THE CONTRACTOR IS TO PROVIDE PROTECTION FOR ALL OF THE EXISTING TREES WITHIN THE PROJECT LIMITS THROUGHOUT THE COURSE OF THE PROJECT, TO MIMIMIZE AS MUCH AS POSSIBLE ANY DAMAGE OCCURING TO THE TREES AS A REQUIT OF THE CONTRACTORS' CONSTRUCTION ACTIVITIES. THEE PROTECTION IS TO BE IN PLACE BEFORE ANY WORK IS STARTED, AND IS TO BE IN THE FORM OF ORANGE CONSTRUCTION SAFETY FENCING OR WOOD RAILS PLACED AROUND EACH TREE PER SECTION SOTT AND THE DETAIL DRAWINGS.

ALL SIDEWALK RAMPS ARE TO BE OF THE TYPE AS NOTED, AND LOCATED AS SHOWN IN THE PLANS, HEADER CURB FOR THE SIDEWALK RAMP IS TO BE 5 FEET LONG, WITH THE TRANSITION CURBS BEING FROM 3 TO 7 FEET IN LENGTH.

9 WHERE NEW SIDEWALK IS TO BE CONSTRUCTED ADJACENT TO OTHER PAVED AREAS, A MINIMUM OF 2 FEET OF THE ADJACENT PAVED AREA IS TO BE REPLACED IN KIND.

10. RETWEEN THE CURR AND SIDEWALK, REMOVE ALL, EXISTING ASPHALT, BRICK BETWEEN THE CURB AND SIDEWALK, REMOVE ALL ENTITION ASTPHALT, BRICK, CONCRETE, AND SLATE MATERIALS IN LOCATIONS AS DESIGNATED ON THE DRAWINGS. EXCAVATE TO A DEPTH THAT IS SUFFICIENT TO REMOVE THE EXISTING MATERIAL, BACKFILL THE EXCAVATED AREA WITH SELECT BACKFILL MATERIAL EXCAVATED FROM THE SITE, 4 INCHES OF TOPSOIL AND HYDROSEED, PER SECTION R610, AND HYSDOT

THE CONTRACTOR IS TO TAKE APPROPRIATE MEASURES TO PREVENT DIRT, DEBRIS AND CONSTRUCTION MATERIALS FROM ENTERING THE SEWER MAIN, LATERALS, CATCH BASINS, MANHOLES AND OTHER APPURTENANCES DURING CONSTRUCTION.

12. REPLACEMENT FRAMES AND COVERS FOR SEWER MANHOLES WILL BE FURNISHED BY MONROE COUNTY PURE WATERS. THE CONTRACTOR IS TO MAKE ARRANGEMENTS TO OBTAIN THE REPLACEMENT FRAMES AND COVERS FROM MONROE COLINTY PLIRE WATERS STOCKROOM BY CALLING 1-716-760-7610, EXTENSION 7061. THE STOCKROOM REQUIRES A MINIMUM OF 2 WORKING DAYS ADVANCE NOTICE TO MAKE ARRANGEMENTS TO OBTAIN THE REPLACEMENT FRAMES AND COVERS.

13. WHERE AN EXISTING CATCH BASIN IS TO BE REMOVED, ALL PORTIONS OF THE WALLS AND FOUNDATION ARE TO BE REMOVED, AND THE EXISTING LATERAL AND UNDERDRAIN PIPES PLUGGED WITH CONCRETE, THE COST OF WHICH IS TO BE INCLUDED IN THE UNIT PRICE BID FOR ITEM ROGO.04. SEE DETAIL DRAWING FOR BACKFILL AND PAVEMENT RESTORATION OF THE PRICE OF

14. THE MAXIMUM DISTANCE BETWEEN DISINFECTION/SAMPLING TAPS ON NEW WATER MAIN PIPE IS 1,000 FEET.

15. APPROPRIATE MEASURES ARE TO BE TAKEN TO PREVENT DIRT, DEBRIS, AND GROUND WATER FROM CONTAMINATING THE WATER MAIN. THE GROUND WATER LEVEL IS NEVER TO BE LESS THAN 12 INCHES BROWN THE PIPE INVERT, AND WHENEVER AN OPEN PIPE END IS UNATTENDED, IT IS TO BE COVERED IN A WATER TIGHT MANNER.

UNATTENDED, IT IS TO BE COVERED IN A WATER TIGHT MANNER,

16. THE WATER MANIS TO BE DISINFECTED EQUAL. TO AWWA STANDARD FOR DISINFECTION, WATER MAINS DESIGNATION COST (LATEST REVISION), FOLLOWING DISINFECTION, THE WATER MAIN IS TO BE FLUSHED UNTIL THE CHLORINE CONCENTRATION IN THE WATER LEAVING THE MAIN IS NO HIGHER THAN THAT GENERALLY PREVAILING IN THE WATER LEAVING THE MAIN IS NO HIGHER THAN THAT GENERALLY PREVAILING IN THE SYSTEM. THE SAMPLING POINTS, THE MONDRO COUNTY DEPRATISENT OF HEALTH MUST RECEIVE AT LEAST 48 HOUR ADVANCE NOTIFICATION RECEIVES TIME SAMPLING SERVICES, SAMPLING SERVICES, SAMPLING WILL NOT BE PERFORMED PRIOR TO RECEIVE THOM A 1YES LICONSED OR REGISTERED DESIGN PROFESSIONAL (ENGINEER, ARCHITECT OR LAND SURVEYOR WITH A SPECIAL EXEMPTION UNDER SECTION ZOBRIC OF THE EDUCATION LAW) CERTIFYING THAT THE WATER SUPPLY IMPROVEMENTS. TESTING AND DISINFECTION WERE COMPLETED IN ACCORDANCE WITH THE DEPARTMENT AND AND DISINFECTION WERE COMPLETED IN ACCORDANCE WITH THE DEPARTMENT AND AND THE DEPARTMENT SPECIAL COUNTS. ALL WATER MAIN HITHINGS NOT RECEMBED AND THE TOWN OF THE COUNTS ALL WATER MAIN HITHINGS NOT RECEMBED FROM THE AND THAT THE WASTER SHAPE OF THE SWARD DISINFECTED.

30 MINUTES PRIOR TO MATALLATION. THE WATER MAIN WITHINGS NOT RECEMBED HIS ETWICE IN SERVICE UNIT. SECOND TO THE WATER THAN THE SWARD DISINFECTED.

17 MINIMUM VERTICAL SEPARATION BETWEEN WATER MAINS AND SEWER PIPE LINES IS TO BE MINIMUM VERTICAL SEPARATION BETWEEN WATER MAINS AND SEWER PIPE LINES IS TO BE BE INCHES MEASURED FROM THE OUTSIDE OF THE PIPES AT THE POINT OF CROSSING. ONE FULL STANDARD LAYING LENGTH OF WATER MAIN IS TO BE CENTERED UNDER OR OVER THE SEWER AS OTHAT BOTH JOINTS WILL BE AS FAR FROM THE SEWER AS POSSIBLE. IN ADDITION, WHEN THE WATER MAIN PASSES UNDER A SEWER, ADEQUATE STRUCTURAL SUPPORT (COMPACTED SELECT FILL) IS TO BE PROVIDED FOR THE SEWER TO PREVENT EXCESSIVE DETECTION OF JOINTS AND SETTLING OF THE SEWER ON THE WATER MAIN, MINIMUM HORIZONTAL SEPARATION BETWEEN PARALLEL WATER MAINS AND SEWER PIPES (INCLUDING MANHOLES AND VAULTS) IS TO BE 10 FEET MEASURED FROM THE OUTSIDE OF THE PIPES, MANHOLES OR VAULTS).

18. WHEN INSTALLING FIRE HYDRANTS, SHOULD GROUND WATER BE ENCOUNTERED WITHIN 7 FET OF THE FINISHED GRADE. FIRE HYDRANT WEEP HOLES (DRAINS) ARE TO BE PLUGGED

19. THE WATER MAIN IS TO BE PRESSURE/LEAKAGE TESTED IN ACCORDANCE WITH THE MINIMUM REQUIREMENTS OF THE AWWA STANDARD C600 (LATEST REVISION) OR IN ACCORDANCE WITH MORE STRINGENT REQUIREMENTS IMPOSED BY THE SUPPLIER OF WATER.

20. FOR ALL ABANDONED WATER MAIN PIPE AND HYDRANT BRANCHES, THE CONTRACTOR IS TO PLUG ALL CUT AND OPEN PIPE ENDS WITH 12 INCHES CONCRETE, THE COST OF WHICH IS TO BE INCLUDED IN THE UNIT PRICE BID FOR TREWS NUMBER SECTIONS R907, R908 AND CURB STOPS IN THE SHUT POSITION, INCLUDING WATER VALVES AND CURB STOPS IN THE SHUT POSITION, INCLUDING WATER VALVES ON HYDRANT BRANCHES, AND REMOVE ALL ABANDONED WATER VALVES AND CURB STOPS IN THE SHUT POSITION, INCLUDING WATER VALVES ON HYDRANT BRANCHES, AND REMOVE ALL ABANDONED WATER VALVES ON THE VALVES OF THE PROPERTY OF THE PRO

21. THE CONTRACTOR IS TO USE CAUTION WHEN WORKING IN THE VICINITY OF EXISTING WATER MAINS WHICH ARE TO REMAIN IN SERVICE. NO VIBRATORY EQUIPMENT IS TO BE USED WITHIN 5 FEET (HORIZONTALLY) OF THE EXISTING WATER MAIN.

22. CONSTRUCT ALL SEWERS, LATERALS, CATCH BASINS, MANHOLES, AND ASSOCIATED APPURTENANCES IN CONFORMANCE WITH THE REQUIREMENTS OF THE ROCHESTER PURE WATERS DISTRICT.

23. ALL OLD/REMOVED 19" X 19" CATCH BASIN GRATES ARE THE PROPERTY OF THE ROCHESTER PUBE WATERS DISTRICT. RETURN GRATES TO MONROE COUNTY PURE WATERS ROCHESTER OPERATIONS CENTER, 444 EAST HENRIETTA ROAD, ROCHESTER, NEW YORK, MONDAY THROUGH FRIDAY BETWEEN 8:00 AM AND 3:00 PM AT 1NO COST 10 THE OWNER.

EXISTING FEATURES LEGEND

	CONTOUR (I,O' INTERVAL)	T	TELEPHONE MANHOLE
	CONTOUR (0.25' INTERVAL)	TV	TELEVISION HANDHOLE
Ø MUP	METAL UTILITY POLE	CI	CITY HANDHOLE
Ø WUP	WOOD UTIUTY POLE	[CO]	COUNTY HANDHOLE
¥ FLP	FIBERGLASS LIGHT POLE	E	ELECTRIC HANDHOLE
₩ MLP	METAL LIGHT POLE	£	HANDICAPPED RAMP
()	SHRUBROW	*	GROUND LIGHT
\bigcirc	SHRUB	•	BOLLARD POST
° 2"	DECIDUOUS TREE & SIZE	FFE*254.20′	FINISHED FLOOR ELEVATION
2	CONIFEROUS TREE & SIZE	0	CHAIN HANDRAIL
	RECTANGULAR CATCH BASIN		METAL GUARD RAIL
∕Ô\HYD.	HYDRAWT	0	CHAIN LINK FENCE
₩ ○	WATER VALVE	/ //	WOODEN FENCE
GV ○	GAS VALVE	oo	METAL FENCE
\rightarrow	MONITORING WELL	RCS	RCS MONUMENT
(DRAINAGE MANHOLE	• PK	PK NAIL
(3)	SEWER MANHOLE	ODH	DRILL HOLE/CIRCLE
E	ELECTRIC MANHOLE		

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SITE PLAN - BOATER SERVICES BLDG	C4.01
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PHASE II MARINA AND SLIP LAYOUT PLAN	ME1.04
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PLANTING DETAILS	LP3.06

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PROJECT/CLIENT

PORT OF ROCHESTER MARINA DEVELOPMENT **PROJECT**

ROCHESTER, NY



REVISION

50% DESIGN

GENERAL NOTES AND LEGEND

SCALE: DESIGNED BY: DRAWN BY: REVIEWED BY



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INDEX PLAN

DATE:	MARCH 18, 2011
SCALE:	NTS
DESIGNED BY:	
DRAWN BY:	
REVIEWED BY:	
DDO IFCT NUMBER	210000

G2.01

SEVERAL DRAWING SHEET TYPES IN THIS PLAN SET HAVE MULTIPLE SEQUENCE NUMBERS. THIS INDEX PLAN DESIGNATES THE COMMON SEQUENCE NUMBERS USED AMONG THE VARIOUS DRAWING SHEET TYPES.

THE HIGHWAY PLANS USE UNIQUE SEQUENCE NUMBERS WHICH FOLLOW THE ALIGNMENT OF THE PROPOSED STREET NETWORK.



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STAGING AREA PLAN

DATE:	MARCH 18, 2011
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EXISTING CONDITIONS PLAN

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EXISTING CONDITIONS PLAN

DATE:	MARCH 18, 2011
SCALE:	1" = 30'
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REVIEWED BY:	
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- SALVAGE ALL LIGHTING FIXTURES FOR REINSTALLATION ON-SITE
 SALVAGE ALL VALVES AND HYDRANT UNITS, PROVIDE TO CITY WATER BUREAU AT A LOCATION TBD
- SALVAGE AND CLEAN GRANITE CURBING. REINSTALL ON-SITE AT SPECIFIED LOCATIONS, PROVIDE BALANCE TO COR AT LOCATION TBD

 SALVAGE VORTECHNICS UNIT WITHIN EMBARKING / DISEMBARKING AREA, PROVIDE TO MCPW AT
- SALVAGE MANHOLE COVERS AND CATCH BASIN GRATES, PROVIDE TO MCPW AT LOCATION TBD
 SALVAGE ALL DECORATIVE FENCING AND GATES, PROVIDE TO COR AT LOCATION TBD

- SALVAGE ALL STREETSCAPE AMENITIES, E.G. BENCHES, TRASH RECEPTACLES, DECORATIVE BOLLARDS, ETC, PROVIDE TO COR AT LOCATION TBD
- SALVAGE ALL TICKET AND INSPECTION BOOTHS IN EMBARKING / DISEMBARKING AREA, PROVIDE TO COR AT LOCATION TBD

 • TRANSPLANT ALL TREES 6-12 INCHES DBH AT LOCATIONS IN ONTARIO BEACH PARK TBD

GENERAL DEMOLITION IN AREAS IMPACTED BY CONSTRUCTION

 DEMO AND REMOVE ALL HARDSCAPE AND LANDSCAPE TREATMENTS NOT IDENTIFIED FOR SALVAGE, E.G. ASPHALT, CONCRETE, PLANTINGS, ETC

DEMOLITION AND ABANDONMENT OF PUBLIC UTILITIES (WATER / SANITARY/ STORM)

- DEMO AND REMOVE ALL SANITARY SEWER, DRAINAGE PIPING AND WATERMAIN WITHIN THE LIMITS OF THE MARINA EXCAVATION.
- REMOVE ALL MANHOLES AND CATCH BASINS WITHIN THE LIMITS OF THE MARINA EXCAVATION.
- BEYOND THE LIMITS OF MARINA EXCAVATION, REMOVE AND BACKFILL ALL DEFUNCT MANHOLES AND CATCH BASINS, AND ABANDON ALL DEFUNCT UTILITY PIPING IN-PLACE BY FILLING COMPLETELY WITH

PRIVATE UTILITY ABANDONMENTS ALONG RIVER ST, HINCHER ST, CORRIGAN ST, AND THE DROPOFF LOOP

- CONFIRM THE ABANDONMENT OF THE FOLLOWING UTILITIES PRIOR TO COMMENCING DEMOLITION ACTIVITIES

- > GAS RG&E
 > ELECTRIC RG&E
 > FIBEROPTICS CITY OF ROCHESTER AND MONROE COUNTY

- CABLE TIME WARNER
 TELECOM FRONTIER, OTHERS ???? PRIVATE UTILITIES TO REMOVE ALL WIRING, FIBEROPTIC LINES, TELECOM LINES, ETC FROM CONDUITS IMPACTED BY PROJECT TO THEIR SOURCE OR TO THE NEAREST JUNCTION POINT TO FACILITIES TO
- REMOVE ALL MANHOLES JUNCTION BOXES, PULL BOXES, CONDUITS RELATED TO ELECTRICAL.
- FIBEROPTIC, TELECOM SYSTEMS, AND GAS MAIN PIPING WITHIN THE LIMITS OF MARINA EXCAVATION


 BEYOND THE LIMITS OF MARINA EXCAVATION, REMOVE AND BACKFILL ALL DEFUNCT MANHOLES
- JUNCTION BOXES, PULL BOXES, AND ABANDON ALL DEFUNCT UTILITY PIPING AND CONDUITS IN-PLACE BY FILLING COMPLETELY WITH FLOWABLE FILL

SITE UTILITIES (OUTSIDE ROADWAY)

- REMOVE ALL WIRING, RIBEROPTIC LINES, TELECOM LINES, ETC FROM CONDUITS IMPACTED BY MARINA EXCAVATION TO THEIR SOURCE OR TO THE NEAREST JUNCTION POINT TO FACILITIES TO REMAIN
- REMOVE ALL POLES, MANHOLES, JUNCTION BOXES, PULL BOXES, CONDUITS RELATED TO ELECTRICAL,
 FIBEROPITC, TELECOM SYSTEMS WITHIN THE LIMITS OF MARINA EXCAVATION.
 BEYOND THE LIMITS OF MARINA EXCAVATION, REMOVE AND BACKFILL ALL DEFUNCT MANHOLES
- JUNCTION BOXES, PULL BOXES, AND ABANDON ALL DEFUNCT UTILITY CONDUITS IN-PLACE BY FILLING COMPLETELY WITH FLOWABLE FILL

DEMOLITION EMBARKING / DISEMBARKING AREAS

- DEMO AND REMOVE ALL CONCRETE BOLLARDS AND ATTACHED EQUIPMENT
- DEMO AND REMOVE ALL CONCRETE BARRIERS AND PADS
- DEMO AND REMOVE PREUMATIC TUBING TO LIMITS OF EXCAVATION, BEYOND THE LIMITS ABANDON ALL DEFUNCT TUBING IN-PLACE BY FILLING COMPLETELY WITH FLOWABLE FILL
- DEMO AND REMOVE OVERHEAD CANOPY AND SUPPORTING STRUCTURE AND FOUNDATIONS AT DISEMBARKING BOOTHS ONLY. (CANOPY ADJACENT TO VEHICLE INSPECTION GARAGE TO REMAIN

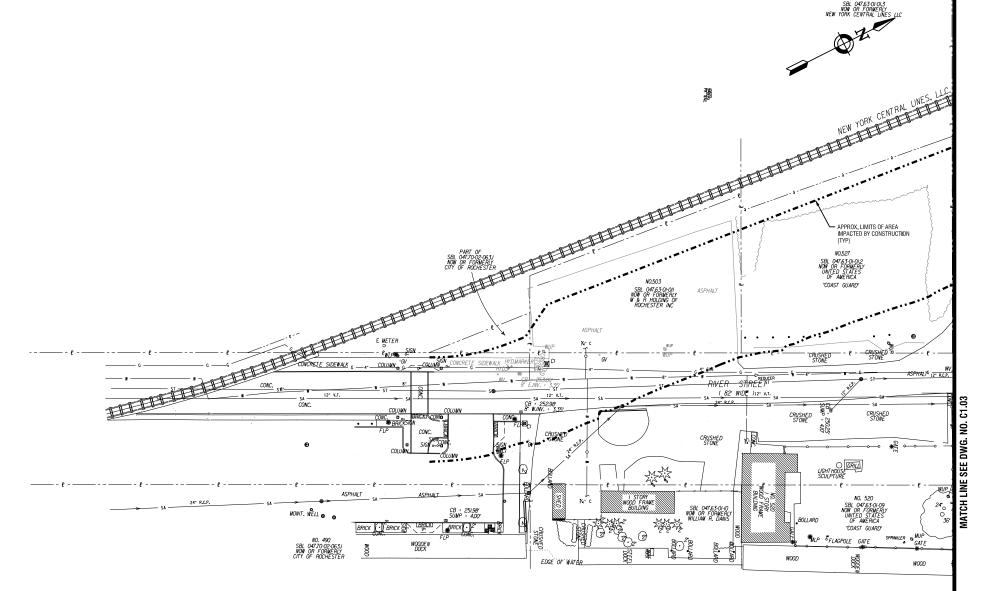

GENESEE RIVER



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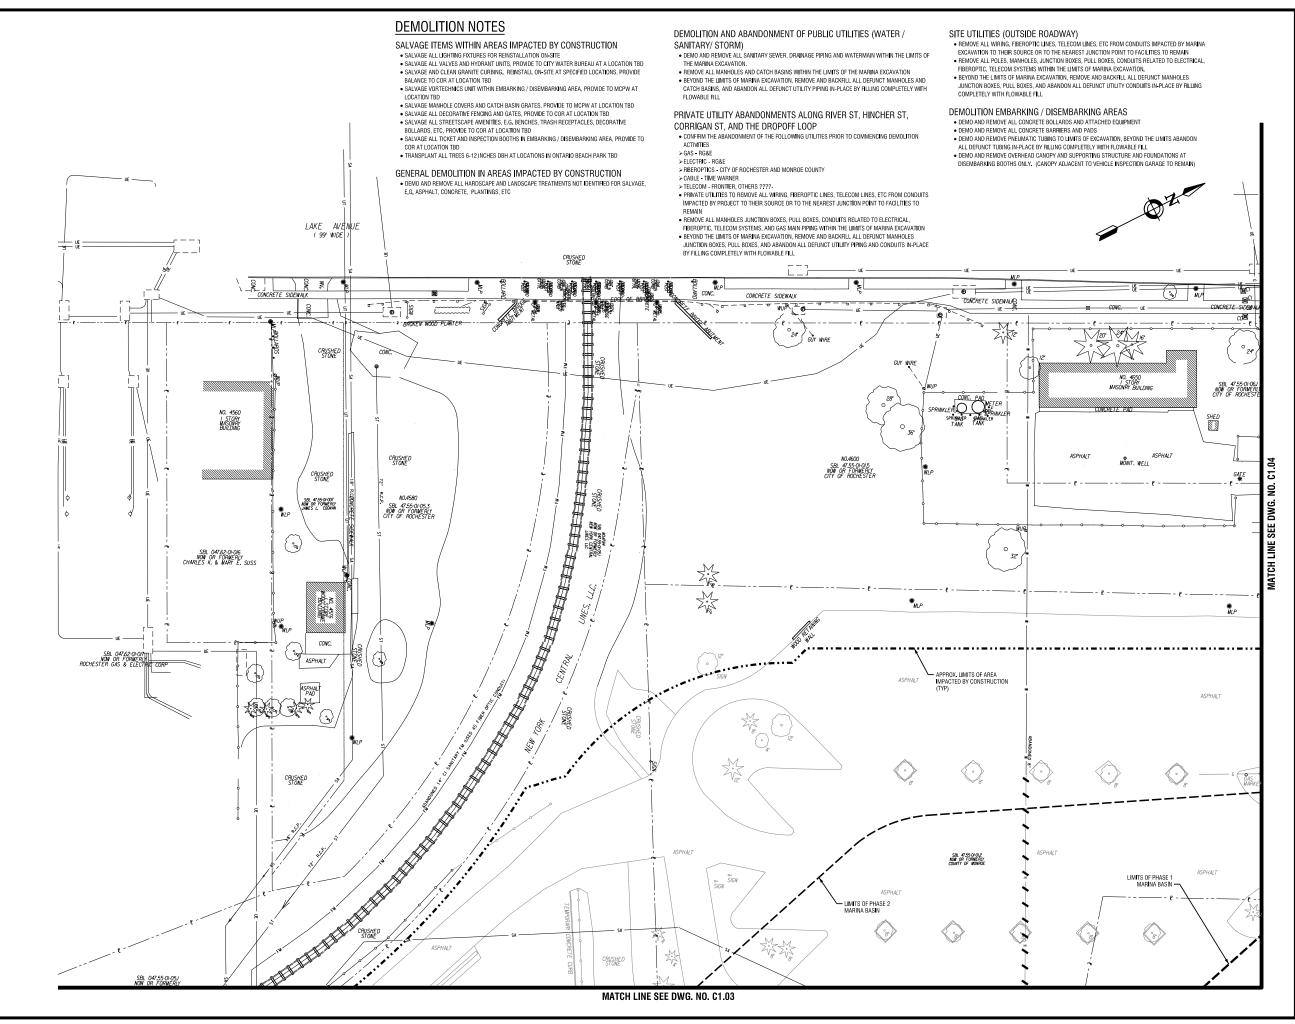


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50% DESIGN

DEMOLITION PLAN

DATE:	MARCH 18, 2011
SCALE:	1" = 30'
DESIGNED BY:	
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Edgewater

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City of Rochester

idation of New York Education. Lew Article 145 Sec. 7209, for any person, acting under the direction of all benead architect, professional engineer, or far to, but air at herm in any way. It as them beauting this seal of an architect, to, but surveyor is faitness the acting actinic configuration for this surveyor to the term that seal and robotion full-end by followed by that suppaire and who althought and septic directions for all antients.

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DRAWING HILL

DEMOLITION PLAN

DATE: MARCH 18, 2011

SCALE: 1" = 30"

DESIGNED BY:

DRAWN BY:

REVIEWED BY:

DRAWERS: 214960

C1.02

 REMOVE ALL POLES, MANHOLES, JUNCTION BOXES, PULL BOXES, CONDUITS RELATED TO ELECTRICAL, FIBEROPTIC, TELECOM SYSTEMS WITHIN THE LIMITS OF MARINA EXCAVATION.

JUNCTION BOXES, PULL BOXES, AND ABANDON ALL DEFUNCT UTILITY CONDUITS IN-PLACE BY FILLING COMPLETELY WITH FLOWABLE FILL

BEYOND THE LIMITS OF MARINA EXCAVATION. REMOVE AND BACKFILL ALL DEFUNCT MANHOLES.

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BEYOND THE LIMITS OF MARINA EXCAVATION, REMOVE AND BACKFILL ALL DEFUNCT MANHOLES AND
CATCH BASINS, AND ABANDON ALL DEFUNCT UTILITY PIPING IN-PLACE BY FILLING COMPLETELY WITH

REMOVE ALL MANHOLES AND CATCH BASINS WITHIN THE LIMITS OF THE MARINA EXCAVATION

Edgewater resources

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PORT OF ROCHESTER MARINA DEVELOPMENT **PROJECT**

ROCHESTER, NY



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- BOLLARDS ETC. PROVIDE TO COR AT LOCATION TRD.
- SALVAGE ALL TICKET AND INSPECTION BOOTHS IN EMBARKING / DISEMBARKING AREA, PROVIDE TO COR AT LOCATION TBD
- TRANSPLANT ALL TREES 6-12 INCHES DBH AT LOCATIONS IN ONTARIO BEACH PARK TBD

GENERAL DEMOLITION IN AREAS IMPACTED BY CONSTRUCTION DEMO AND REMOVE ALL HARDSCAPE AND LANDSCAPE TREATMENTS NOT IDENTIFIED FOR SALVAGE, E.G. ASPHALT, CONCRETE, PLANTINGS, ETC

DEMOLITION AND ABANDONMENT OF PUBLIC UTILITIES (WATER / SANITARY/ STORM)

- DEMO AND REMOVE ALL SANITARY SEWER, DRAINAGE PIPING AND WATERMAIN WITHIN THE LIMITS OF THE MARINA EXCAVATION.
- REMOVE ALL MANHOLES AND CATCH BASINS WITHIN THE LIMITS OF THE MARINA EXCAVATION
 BEYOND THE LIMITS OF MARINA EXCAVATION, REMOVE AND BACKFILL ALL DEFUNCT MANHOLES AND CATCH BASINS, AND ABANDON ALL DEFUNCT UTILITY PIPING IN-PLACE BY FILLING COMPLETELY WITH

- > TELECOM FRONTIER OTHERS 2222-
- PRIVATE UTILITIES TO REMOVE ALL WIRING, FIBEROPTIC LINES, TELECOM LINES, ETC FROM CONDUITS IMPACTED BY PROJECT TO THEIR SOURCE OR TO THE NEAREST JUNCTION POINT TO FACILITIES TO
- REMOVE ALL MANHOLES JUNCTION BOXES, PULL BOXES, CONDUITS RELATED TO ELECTRICAL FIBEROPTIC, TELECOM SYSTEMS, AND GAS MAIN PIPING WITHIN THE LIMITS OF MARINA EXCAVATION
- BEYOND THE LIMITS OF MARINA EXCAVATION, REMOVE AND BACKFILL ALL DEFUNCT MANHOLES
 JUNCTION BOXES, PULL BOXES, AND ABANDON ALL DEFUNCT UTILITY PIPING AND CONDUITS IN-PLACE BY FILLING COMPLETELY WITH FLOWABLE FILL

- SITE UTILITIES (OUTSIDE ROADWAY)

 REMOVE ALL WIRING, FIBEROPTIC LINES, TELECOM LINES, ETC FROM CONDUITS IMPACTED BY MARINA
- EXCAVATION TO THEIR SOURCE OR TO THE NEAREST JUNCTION POINT TO FACILITIES TO REMAIN
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UTILITY PROFILES SANITARY SEWER

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UTILITY PROFILES SANITARY SEWER BOATER SERVICES

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PROFILE VIEW - SOUTH

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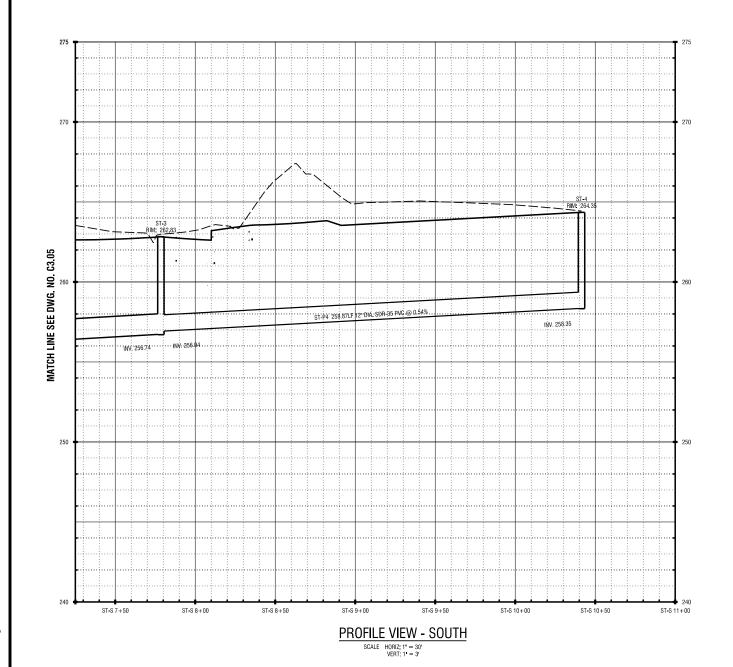



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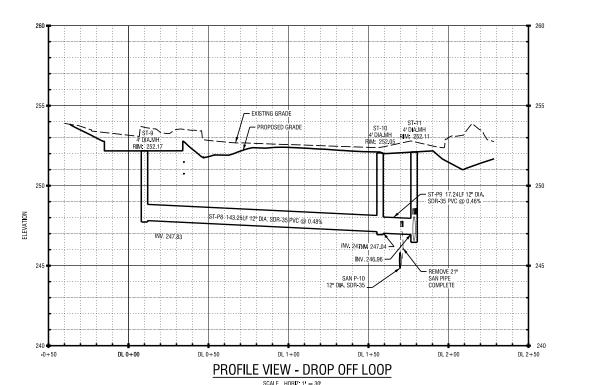
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UTILITY PROFILES SOUTH STORM SEWER

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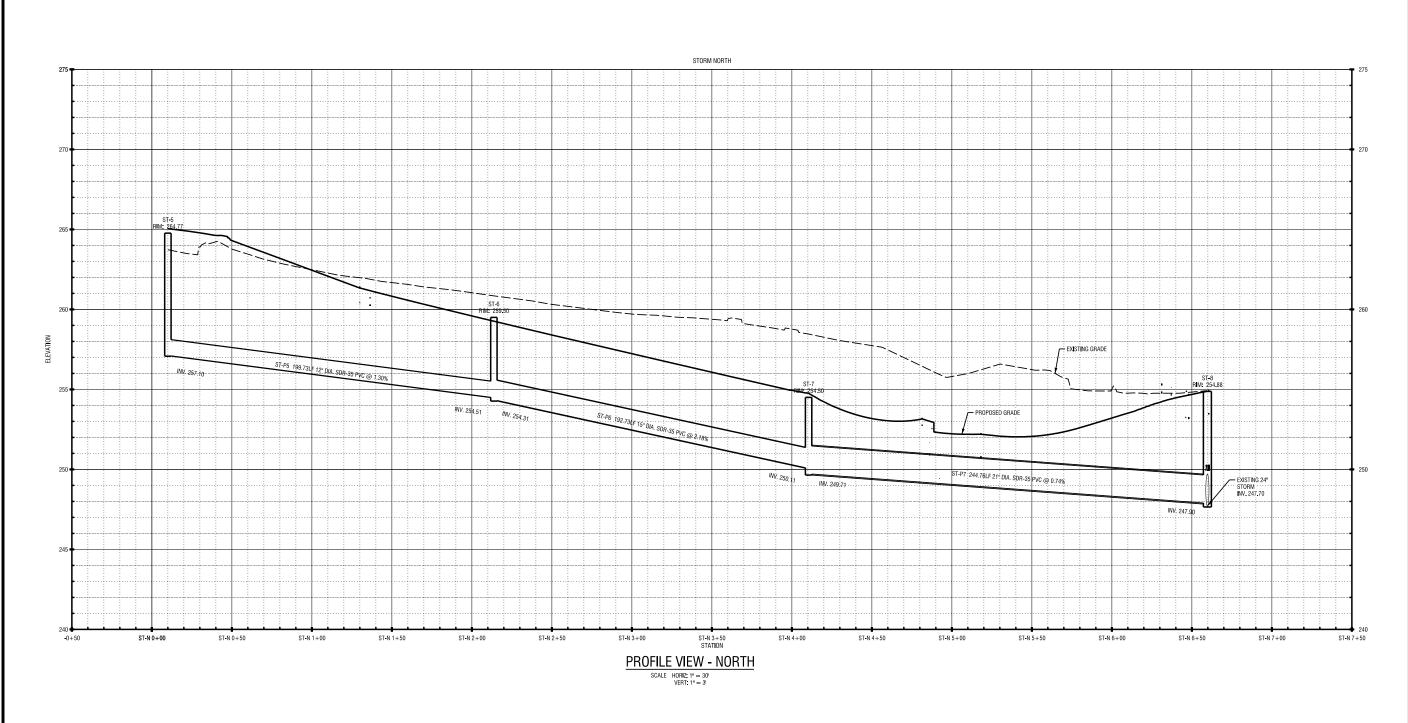


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UTILITY PROFILES SOUTH STORM SEWER **CIRCULATION PIPE** & DROP OFF LOOP

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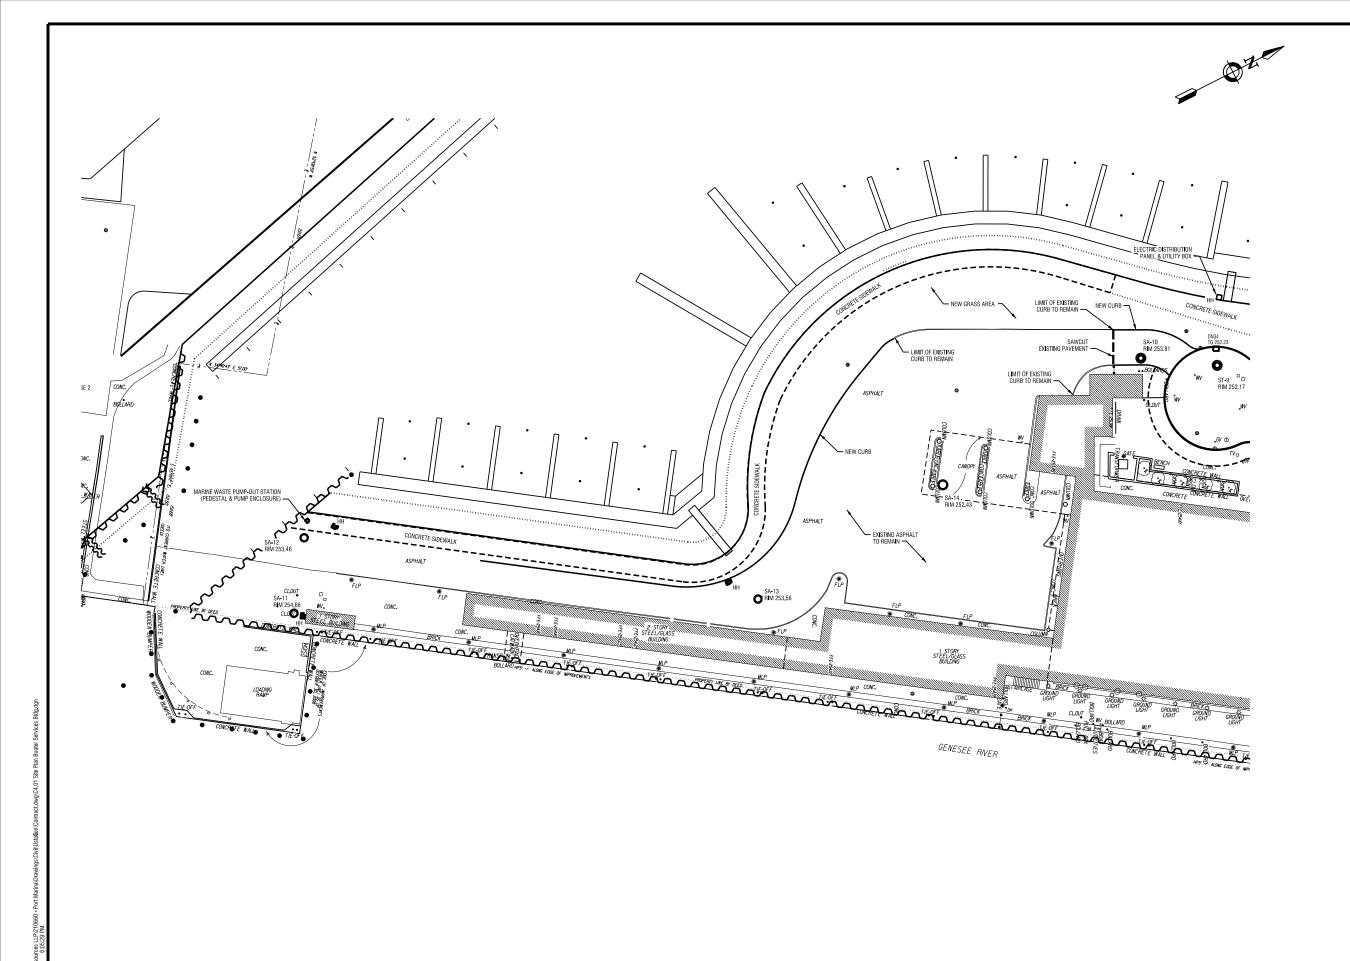


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UTILITY PROFILES NORTH STORM SEWER
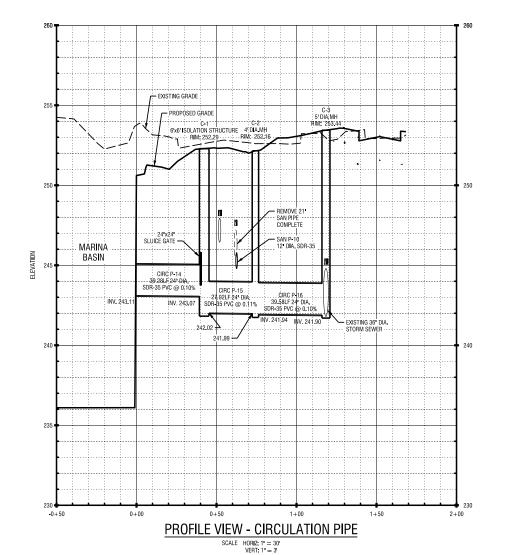
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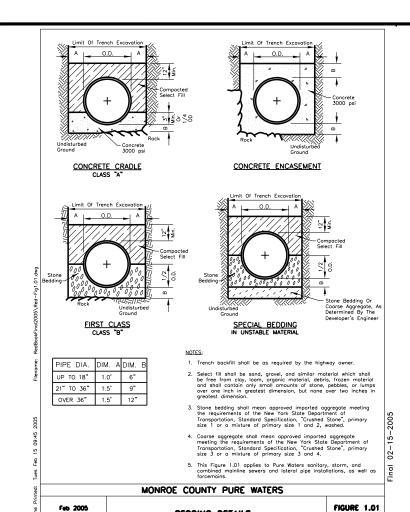
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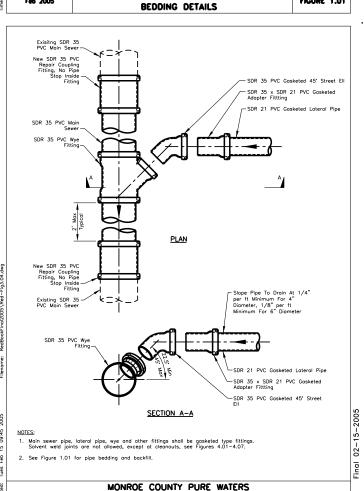
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SITE PLAN - BOATER SERVICES BLDG.

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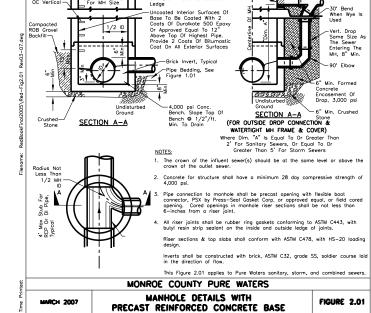


NEW LATERAL WYE CONNECTION

TO EXISTING PVC SEWER

Feb 2005

FIGURE 3.04



2 Course Min. Brick, ASTM C32, Grade SS, Or Concrete Adjusting Rings With 2 Coats Of Durolkote 500 Epoxy On Interior Surface


Four 4' 4' 4' 5' 5' 5' 5' 5' 5' 5' 5'


SEWER


LETTERING

8" Min Thick Reinf. Top Slab With 24" Dia. Opening

ON COVER

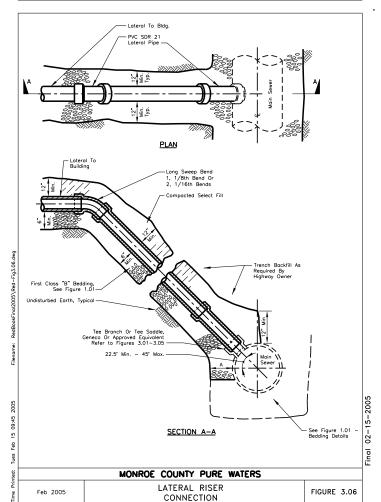

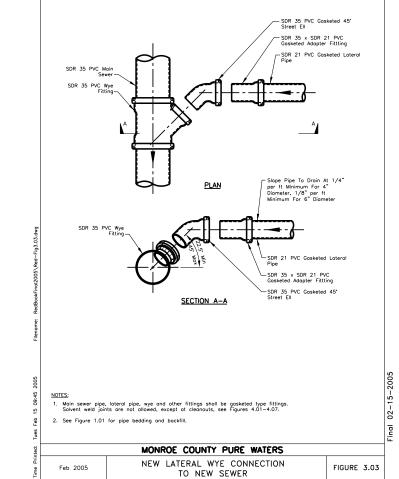

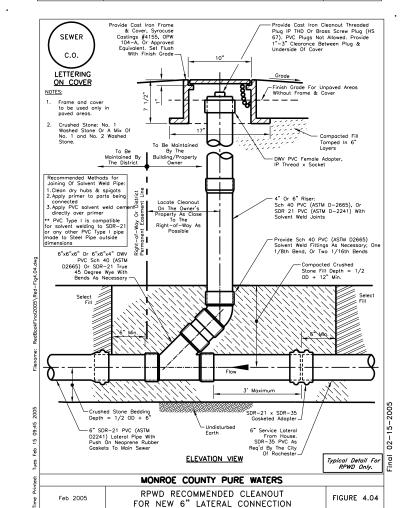



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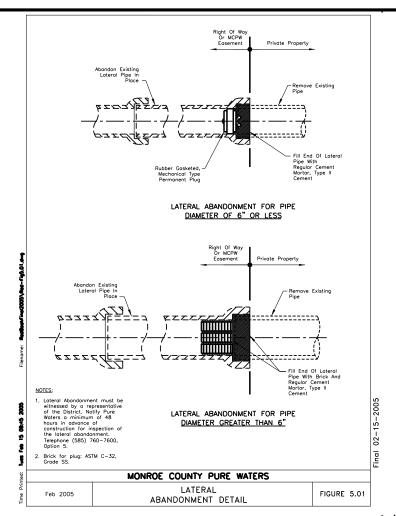
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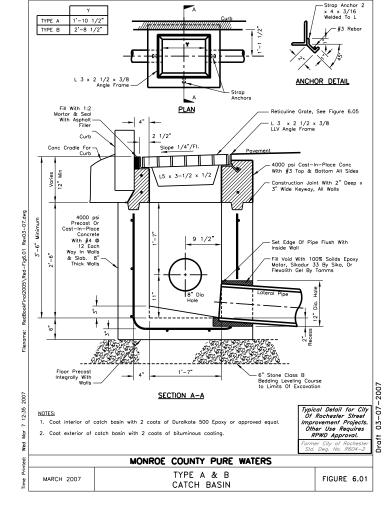
CONSTRUCTION **DETAILS STORM & SANITARY**


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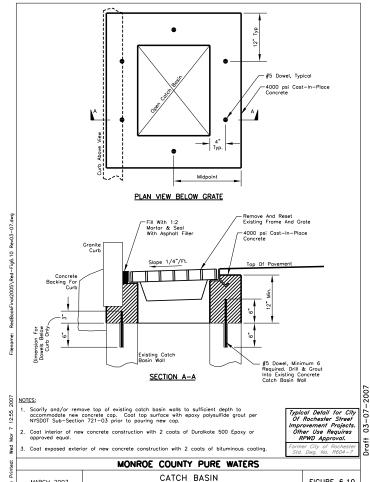
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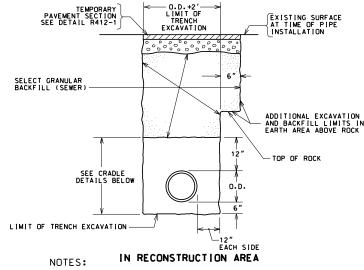




FRAME AND COVER ADJUSTMENT


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FIGURE 6.10

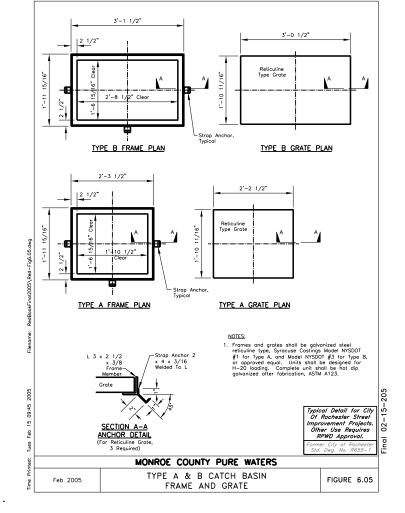

- 1. LIMITS SHOWN ARE MAXIMUM ALLOWED AND MINIMUM REQUIRED FOR EXCAVATION AND BACKFILL.
- UPPER LIMIT FOR TRENCH EXCAVATION IS TOP OF EXISTING SURFACE, AT TIME OF TRENCH EXCAVATION.
- 3. TEMPORARY PAYEMENT SHALL BE REQUIRED FOR TRENCHES IN PAYED AREAS OPEN TO TRAFFIC.
- UPPER LIMIT FOR SELECT GRANULAR BACKFILL (SEWER) IS BOTTOM OF TEMPORARY PAVEMENT (IF USED). OR TOP OF SURFACE AS NOTED ON THE PLANS.
- 5. TEMPORARY OR PERMANENT BLOCKS OR ANY OTHER TYPE OF PIPE SUPPORT IS NOT TO BE USED DURING PIPE INSTALLATION.
- UPPER LIMIT FOR ROCK EXCAVATION IS TOP SURFACE OF ROCK.

SEWER TRENCH DETAIL

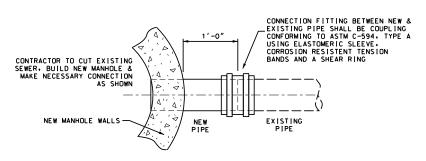

CONNECTION OF EXISTING SEWER TO NEW MANHOLE



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ROCHESTER, NY



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CONSTRUCTION DETAILS STORM & SANITARY

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SECTION A-A

STORM SEWER ISOLATION STRUCTURE

GENERAL UTILITY NOTES:

EXISTING CONDITIONS ARE TAKEN FROM FIELD OBSERVATIONS AND PRIOR CONSTRUCTION DOCUMENTS WHEN AVAILABLE AND ARE NOT GUARANTEED. CONTRACTOR SHALL FILED VERIFY ALL EXISTING CONDITIONS PRIOR TO BIO. NO ALLOWANCE WILL BE MADE FOR ADDITIONAL COSTS DUE TO CONTRACTORS FAILURE TO VERIFY EXISTING CONDITIONS AND DIMENSIONS.

WHEN EXISTING CONSTRUCTION WHICH IS TO REMAIN IS DAMAGED DURING THE COURSE OF CONSTRUCTION AS A RESULT OF CONTRACTORS WORK. IT SHALL BE REPAIRED AND/OR REPLACED WITH SIMILAR OR LIKE MATERIALS AS MUCH AS POSSIBLE, SUBJECT TO OWNERS

PRIOR TO THE START OF CONSTRUCTION, THE CONTRACTOR SHALL TO NOTIFY DIG SAFELY NEW YORK AT 1-800-962-7962 TO REQUEST UTILITY STAKEOUT OF ALL PUBLIC UTILITIES,

MONROE COUNTY PURE WATERS MCPW - ROCHESTER PURE WATERS **DISTRICT SEWER NOTES:**

THIS PLAN REQUIRES APPROVAL AND ISSUANCE OF A PLUMBING PERMIT FROM THE CITY OF ROCHESTER PLUMBING DEPARTMENT.

PRIOR TO CONSTRUCTION, A SEWER CONNECTION PERMIT MUST BE OBTAINED FROM THE MONROE COUNTY PURE WATERS (MCPW) PERMIT OFFICE AT 444 EAST HENRIETTA ROAD, BUILDING 15, ROCHESTER. NEW YORK 14620-4643, PHONE # 753-7600 (OPT. 5).

THE ROCHESTER PURE WATERS DISTRICT (RPWD) MUST RECEIVE THE FOLLOWING PRIOR TO GWING NOTICE TO PROCEED WITH SEWER CONSTRUCTION:

SEWER CONNECTION PERMIT(S) CAN ONLY BE ISSUED TO A PLUMBER LICENSED IN THE CITY OF ROCHESTER AND WHO IS FULLY INSURED AND BONDED IN THE ROCHESTER PURE WATERS DISTRICT (RPMD). PAYMENT (CHECK OR MONEY ORDER TO "RPMD") OF ALL APPLICABLE PERMIT FEES MUST BE FAIR PRIOR TO PERMIT FEES THE PERMIT FEES THE PRIOR TO PERMIT FEES THE PERMIT F

THE RPWD SHALL BE NOTIFIED FORTY-EIGHT HOURS IN ADVANCE OF A CONNECTION OR TAP. (753-7600 (OPT. 5)). THE RPWD SHALL MAKE ALL FOUR AND SIX INCH DIAMETER TAPS TO THE RPWD SEWERS.

SANTARY/STORM/COMBINATION SEWER LATERAL(S) AND APPURTENANCES SHALL BE CONSTRUCTED IN CONFORMANCE WITH THE REQUIREMENTS OF THE ROCHESTER PURE WATERS DISTRICT.

CLEANOUTS SHALL BE INSTALLED ON ALL 4" AND 6" DIAMETER SEWER LATERALS AT THE RIGHT-OF-WAY (ROW) LINE, OR THE SEWER EASEMENT LINE WHERE APPLICABLE. (THE SEWER EASEMENT, MICHO-OF-WAY AWDOOR PROPERTY LINE MUST BE STAKED OUT PRIOR TO INSTALLATION OF LOT LINE CLEANOUTS TO ENSURE PROPER LOCATION OF THE CLEANOUTS. (REFER TO CLEANOUT BETTAIN FOR PROPER INSTALLATION).

IF AN EXISTING LATERAL IS TO BE UTILIZED, THE PLUMBER/CONTRACTOR MUST ENSURE THAT THE LATERAL IS IN GOOD CONDITION AND IS FREE OF DEBRIS (DIRT, MUD, STONE, ROOTS, ETC.) VIA A VIDEO TAPED INSPECTION PERFORMED BY THE PLUMBER/CONTRACTOR OR HIS/HER/THER AGENT. PRIOR TO CONNECTION, THE VIDEO TAPED INSPECTION OF THE EXISTING LATERAL MUST BE PRESENTED TO THE DISTRICT FOR REVIEW AND APPROVAL TO UTILIZE AN EXISTING LATERAL MUST BE PRESENTED TO THE DISTRICT FOR REVIEW AND APPROVAL TO UTILIZE AN EXISTING LATERAL MUST BE THE STATEMENT OF THE BULLDER OR THEIR AGENT TO CLEAN AND/OR REPLACE THE PIPE/LATERAL AS NEEDED.

ANY NEW PORTION OF A SEWER LATERAL INSTALLED WITHIN THE PUBLIC RIGHT-OF-WAY AND SEWER EASEMENT MUST BE SDR-21 PVC.

FLOOR DRAINS IF CONSTRUCTED, SHALL BE CONNECTED TO THE SANITARY/COMBINATION SEWER, FLOOR DRAINS DO NOT INCLUDE FOUNDATION/FOOTER DRAINS, NOTE: ALL DISCHARGES TO THE SANITARY/COMBINATION SEWER MUST COMPLY WITH THE EFFLUENT LIMITS OF THE LOCAL AND/OR MONROE COUNTY SEWER USE LAW.

ANY PORTION OF A SEWER/LATERAL WITH LESS THAN FOUR-FEET (4°) OF COVER WILL REQUIRE CONCRETE ENCASEMENT. SEWERS/LATERALS WITH LESS THAN THREE-FEET (3°) OF COVER ARE NOT ALLOWED.

SANITARY AND STORM SEWER NOTES:

- LATERAL MATERIALS SHALL BE:
 a. 4", 6" AND 8" PVC WITH INTEGRAL WALL AND BELL AND SPIGOT RUBBER-RING
 JOINTS AS MANUHACTURED BY J-M PIPE, OR APPROVED EQUIVALENT, WITH A
 MINIMUM WALL THICKNESS OF SDR-21.
 b. CAST IRON
- SEWER MATERIALS SHALL BE:
 A. WITHIN RIGHT OF WAYS = PVC WITH INTEGRAL WALL AND BELL AND SPIGOT
 RUBBER-RING JOINTS AS MANUFACTURED BY J-M PIPE, OR APPROVED EQUIVALENT,
 WITH A MINIMUM WALL THICKNESS OF SOR-21.
- THE A MINIMUM WALL ITHONICS OF SUR-21.

 PRIVATE = PVC WITH INTEGRAL WALL AND BELL AND SPIGOT RUBBER-RING JOINTS AS MANUFACTURED BY J-M PIPE, OR APPROVED EQUIVALENT, WITH A MINIMUM WALL THICKNESS OF SDR-35
- ANY LATERALS ENCOUNTERED DURING EXCAVATIONS, WHICH ARE NOT DEPICTED ON THE CONSTRUCTION DOCUMENTS, SHALL BE REPORTED TO THE CONSTRUCTION MANAGER AND LABELLA ASSOCIATES.
- 4. THE CONTRACTOR SHALL VERIFY EXISTING LATERALS PRIOR TO START OF UTILITY INSTALLATIONS AND IMMEDIATELY REPORT ANY DISCREPANCIES TO THE CONSTRUCTION MANAGER AND LABELLA ASSOCIATES IN WRITING, CONTRACTOR SHALL VERIFY MATERIALS, SIZES, INVERTS, AND CONDITION OF EACH PROPOSED CONNECTION.



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Relationships, Resources, Results.

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CONSTRUCTION **DETAILS STORM & SANITARY**

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PRO IECT NI IMBER:	210660

- REQUIRED FOR EXCAVATION AND BACKFILL.
- 2. UPPER LIMIT FOR TRENCH EXCAVATION IS TOP OF EXISTING SURFACE AT TIME OF TRENCH EXCAVATION.
- 3. UPPER LIMIT FOR ROCK EXCAVATION IS TOP SURFACE OF ROCK.
- 4. UPPER LIMIT FOR SELECT GRANULAR BACKFILL (WATER) IS BOTTOM OF TEMPORARY PAVEMENT, IF USED, OTHERWISE TOP
- TEMPORARY OR PERMANENT BLOCKS OR ANY OTHER TYPE OF PIPE SUPPORT IS NOT TO BE USED DURING PIPE INSTALLATION.
- MINIMUM DEPTH OF COVER FOR WATER PIPE FROM TOP OF PROPOSED GRADE IS 4.50 FEET FOR DOMESTIC WATER PIPE, AND 5 FEET FOR HOLLY WATER PIPE, UNLESS OTHERWISE NOTED ON PLANS OR AS DIRECTED BY PROJECT MANAGER.

45°

11-1/4°

12"

NOTES:

1. SPECIAL DESIGN IS REQUIRED FOR FITTINGS ON

THRUST BLOCK, SEE DETAIL S900-7.

CONCRETE 0.25 CY

0.50 CY

0.95 CY

1.30 CY

1.65 CY

2.35 CY

1.05 CY

2.00 CY

3.70 CY

(TYPICAL)

(TYPICAL)

CLASS K CONCRETE THRUST BLOCK

UPPER VERTICAL BEND

LOWER VERTICAL BEND

CITY OF ROCHESTER


WATER TRENCH

PAVEMENT

RECONSTRUCTION

SSUED 1-13-06 NON-STANDARD EVISED 11-22-10 DWG.NO.S900-1

1-13-06 NON-STANDARD REVISED 6-1-09 DWG.NO.S900-5

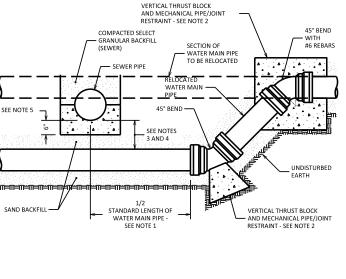


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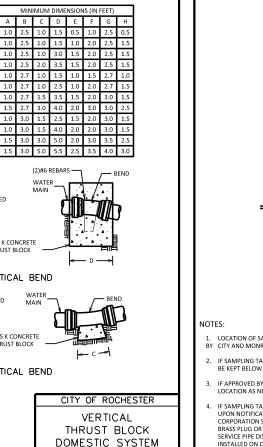
- ONE STANDARD FULL LENGTH OF WATER MAIN PIPE IS TO BE CENTERED ON SEWER PIPE SO THAT BOTH JOINTS OF WATER MAIN PIPE WILL BE AS FAR FROM SEWER PIPE AS POSSIBLE.
- . THRUST BLOCKS AND PIPE/JOINT RESTRAINTS ARE TO BE PROVIDED AT ALL BENDS, SEE DETAILS S900-5, S900-7, S900-8 AND S900-10.
- WHERE WATER MAIN PIPE PASSES UNDER SEWER PIPE THERE IS TO BE MINIMUM 18 INCHES OF VERTICAL SEPARATION BETWEEN WATER MAIN PIPE AND SEWER PIPE.
- WHERE VERTICAL SEPARATION IS LESS THAN 18 INCHES, WATER MAIN PIPE JOINTS LOCATED WITHIN 18 FEET OF BOTH SIDES OF SEWER PIPE MUST BE ENCASED WITHIN CONTROLLED DENSITY FILL MATERIAL, OR SEWER PIPE CONSTRUCTED WITH WATER MAIN STANDARD PIPE AND TESTED TO 150 PSI.
- WHERE WATER MAIN PIPE PASSES UNDER SEWER PIPE THERE IS TO BE MINIMUM OF 6 INCHES OF CLASS K CONCRETE OR CRUSHE STONE BEDDING MATERIAL FOR SEWER PIPE.


ll			PIPE			ND		Т
ΙI			SIZE	90°	45°	22-1/2°	11-1/4°	PL
ΙI			4" - 6"	4	2.5	1.5	1	
ΙI			8"	7	4	2	1	
			12"	14.5	8	4	2	10
		AT TEE	DISTURBED RTH (TYPICA	L		E (TYPICAL) BEND		} {
	NOT	ES:		A1 1L	L, CIVO	33 AND	FLOG	
	SPECIAL DESIGN IS REQUIRED FOR FITTINGS ON DOMESTIC WATER MAIN PIPE LARGER THAN 12 INCHES.							
	2.	THRUST BLOCK IS TO WIDTH OF THRUST I HEIGHT.						
	THRUST BLOCK IS TO BE INSTALLED AT ALL BENDS, PLUGS, TEES, AND TAPPING SLEEVE AND VALVE CONNECTIONS.							
	4.	FACTORY CAST OFFS BENDS.	SETS ARE TO	BE TREATED	O AS (2) 45 D	EGREE		YTI: H
	5.	H						


CITY OF ROCHESTER WATER MAIN CROSSING BELOW SEWER PIPE

1-13-06 NON-STANDARD BLOCK, SEE DETAIL S900-7. REVISED 11-22-10 DWG.NO.S900-3



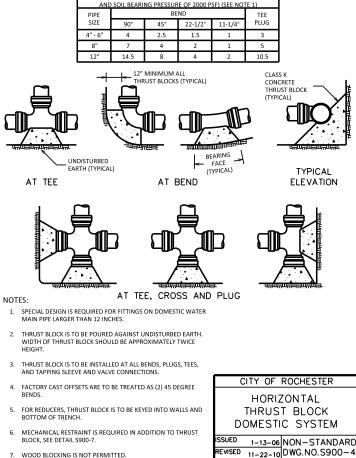

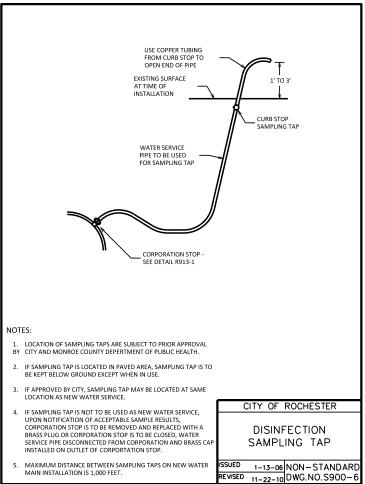

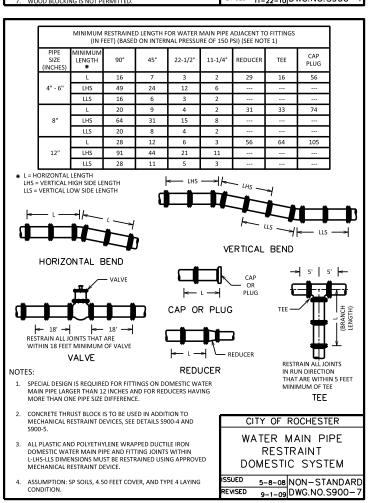



ST. JOSEPH. MI 49085

www.labellapc.com 300 STATE STREET ROCHESTER, NY 14614 Architecture Environmenta P: (585) 454-6110 F: (585) 454-3066 Planning

PROJECT/CLIENT

PORT OF ROCHESTER MARINA DEVELOPMENT **PROJECT**

ROCHESTER, NY




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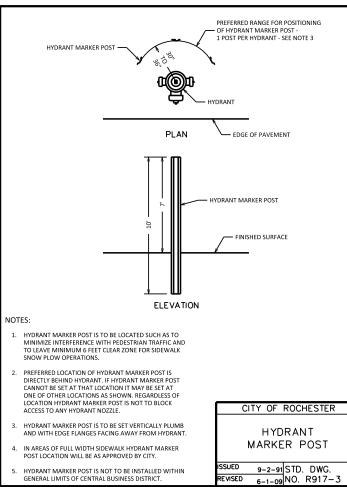
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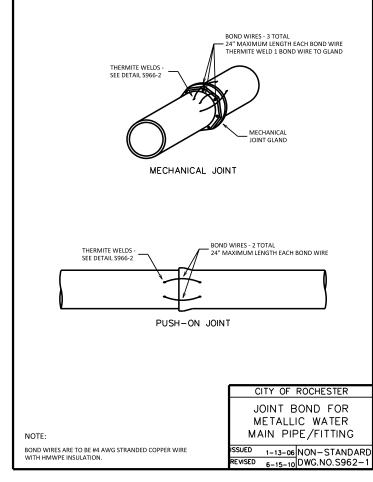
CONSTRUCTION **DETAILS WATER MAIN**


DATE:	MARCH 18, 2011
SCALE:	NTS
DESIGNED BY:	
DRAWN BY:	
REVIEWED BY:	









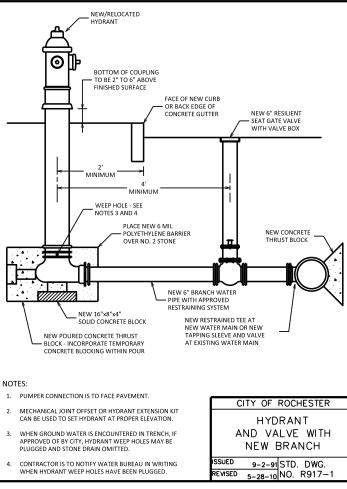

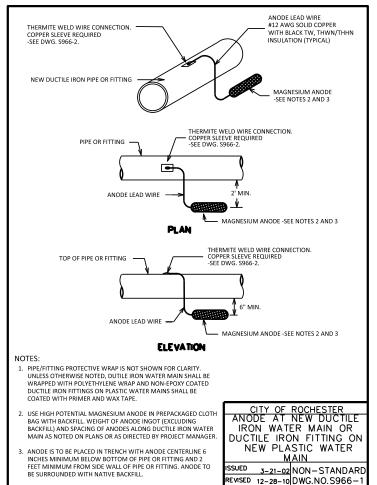

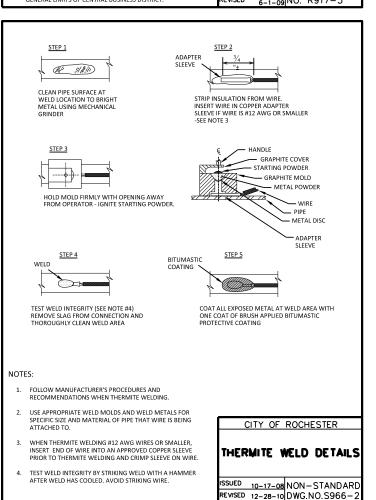

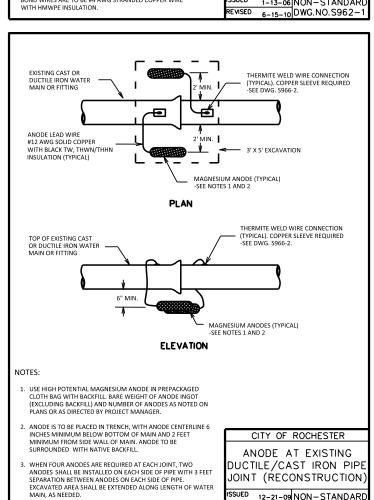

ISSUED 12-21-09 NON-STANDARD

REVISED 12-28-10 DWG.NO.S966-5



PORT OF ROCHESTER MARINA DEVELOPMENT **PROJECT**

ROCHESTER, NY



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CONSTRUCTION **DETAILS WATER MAIN**

DATE:	MARCH 18, 2011
SCALE:	NTS
DESIGNED BY:	
DRAWN BY:	
REVIEWED BY:	

NOTES

T-BOLT AND NUTS SHALL BE: FLOROCARBON COATED, BLUE, BY BIRMINGHAM FASTENER MANUFACTURING OR COR-BLUE BY NSS INDUSTRIES PER "CITY SPEC \$900"

22.5 DEGREE ELBOWS MJ X MJ SHALL BE: FULL BODY AWWA C110 OR COMPACT AWWA C153 SBR GASKETS EPOXY COATED OR DOUBLE THICKNESS CEMENT MORTAR LINING WITH ASPHALT COATING PER "CITY SPEC S901"

TYTON JOINT PIPE SHALL BE: CLASS 56 DOUBLE THICKNESS CEMENT LINES ASPHALT COATED SBR GASKETS, PER "CITY SPEC \$901"

RESTRAINT DEVICE ON ALL CONNECTIONS SHALL BE: MEGALUG SERIES 1100 OR UNIFLANGE 1400 WITH FUSION BODNED EPOXY COATING BODY AND GLANDS FLOROCARBON COATED HARDWARE PER "CITY SPEC S900"

GATE VALVE MJ X MJ SHALL BE: RESILIENT WEDGE AWWA C509 OPEN RIGHT STAINLESS STEEL BONNET BOLTS & NUTS GLANDS HARDWARE TO BE FLOROCARBON COATED PER "CITY SPEC S903"

PIPE SAND BEDDING IN ACCORDANCE WITH DETAIL \$900-2.

TRENCH BACKFILL ABOVE PIPE ENVELOPE SELECT GRANULAR FILL IN 8" COMPACTED LIFT "#1 CRUSHER RUN STONE".

WATER MAIN AND SERVICE NOTES:

THE WATER MAIN AND TEMPORARY BYPASS PIPE SHALL BE DISINFECTED EQUAL TO AWWA STANDARD FOR DISINFECTING WATER MAINS, DESIGNATION C651, BY USING THE CONTINUOUS EERO METHOR COLLOWING DISINFECTION, THE WATER MAIN AND BYPASS PIPE SHALL BE FLUSHED UNTIL THE CHLORINE CONCENTRATION IN THE WATER LEAVING THE MAIN IS NO HIGHER THAN THAT GENERALLY PREVAILING IN THE SYSTEM THE INTERIOR OF ALL WATER MAIN PIPE, VALVES, FITTINGS AND SERVICES FOUR (4) INCHES AND LARGER, INCLUDING NEW HYDRANT BRANCHES CONNECTED TO DISTING WATER MAINS, NOT RECEIVING PLAUFORCH OF THE WATER MAIN SHORT SHORT OF THE WATER MAIN AND SHORT SHORT OF THE WATER MAIN AND SHAND SHORT SHORT OF THE WATER MAIN AND SHAND SHORT SHORT

INLESS OTHERWISE NOTED OR SHOWN ON THE APPROVED PLANS. THE MIMMUM VERTICAL SEPARATION BETWEEN WATER MANS AND SEWER PIPE LINES SHALL BE IS ENDICHES MEASURED FROM THE OUTSIDE OF THE PIPES ATT THE POINT OF CROSSING, ONE FILL STANDARD LAWNIG LENGTH OF WATER MAIN SHALL BE CENTERED UNDER OR OVER THE SEWER SO THAT BOTH JOIN WILL BE AS PARE FROM THE SEWER AS POSSIBLE, IN ADDITION, WHEN THE WATER MAIN PASSES UNDER A SEWER, ADEQUATE STRUCTURAL SUPPORT (COMPACTED SELECTED PLIC) SHALL BE PROMPED FOR THE SEWER TO PREVENT EXCESSIVE OFFI ECTION OF JOINTS AND SETTLING OF THE SEWER ON THE WATER MAIN JUNIESS OTHERWISE NOTED OR SHOWN ON THE APPROVED PLANS. THE MINIMUM HORIZONTAL SEPARATION BETWEEN PARALLEL WATER MAINS AND SEWER PIPES (MICLUDING MANHOLES AND VAULTS) SHALL BE INJECTED WATER MAINS AND SEWER PIPES MICLUDING MANHOLES AND VAULTS) SHALL BE LIFET MEASURED FROM THE OUTSTOP OF THE PIPES MAIN LINES OF ON VAULTS) SHALL BE LIFET MEASURED FROM THE OUTSTOP OF THE PIPES MAIN CHISTORY ON VAULTS) SHALL BE

WHEN INSTALLING FIRE HYDRANTS, SHOULD GROUND WATER BE ENCOUNTERED WITHIN SEVEN (7) FEET OF FINISHED GRADE, FIRE HYDRANT WEEP HOLES (DRAINS) SHALL BE PLUGGED.

THE NEW WATER MAIN SHALL BE PRESSURE/LEAKAGE TESTED IN ACCORDANCE WITH THE MINIMUM REQUIREMENTS OF THE AWAYA STANDARD COOL (LATEST REVISION) OR IN ACCORDANCE WITH MORE STRINGENT REQUIREMENTS IMPOSED BY THE SUPPLIER OF WATER, FOR CITY OF ROCHESTER WATER MAINS, PRESSURE/LEAKAGE TESTING SHALL BE PERFORMED IN ACCORDANCE WITH SUBSECTION 3.05 OF CITY OF ROCHESTER WATER BUREAU SPECIFICATION SOOD - CENTRAL WATER PROVISIONS.

ALL NEW WATER MAINS SHALL BE INSTALLED WITH A MINIMUM COVER DEPTH FROM PROPOSED FINISHED GRADE OF 4.5 FEET FOR DOMESTIC MAINS AND 5.0 FEET FOR HOLLY MAINS.

THE ROCHESTER WATER BUREAU REQUIRES THAT A HYDRANT USE PERMIT BE OBTAINED BY THE COMTRACTOR PRIOR TO USING ANY HYDRANT AS A SOURCE OF WATER SUPPLY. THE PERMIT REQUIRES THE USE OF A WATER METER AND BACKFLOW PREVENTER. THE WATER BUREAU WILL SUPPLY A WATER METER AND BACKFLOW PREVENTER WITH THE PERMIT THE PERMIT THE INCLUDES A REFUNDABLE DEPOSIT FOR THE USE OF THE WATER METER AND BACKFLOW PREVENTER.

FOR EXISTING VALVES AND CURB STOPS THAT ARE LOCATED ON WATER MAINS AND WATER SERVICES WHICH ARE TO BE RETAINED, THE EXISTING VALVE AND CURB BOXES SHALL BE ADJUSTED TO GRADE OR REPLACED AS SHOWN ON THE PLANS OR DIRECTED BY THE PROJECT MANAGER.

FOR ALL ABANDONED WATER MAIN AND HYDRANT BRANCHES, THE CONTRACTOR SHALL PLUG ALL CUT AND OPEN ENDS WITH 12-INCHES OF CONCRETE. THE CONTRACTOR SHALL LEAVE ABANDONED MAIN LINE, HYDRANT BRANCH AND SERVICE VALVES IN THE CLOSED POSITION.

THE CONTRACTOR SHALL EXERCISE CAUTION WHEN WORKING NEAR WATER MAINS WHICH ARE TO BE RETAINED. NO VIBRATORY EQUIPMENT IS TO BE USED OVER OR ADJACENT TO EXISTING WATER MAINS.

APPROPRIATE MEASURES SHALL BE TAKEN TO PREVENT DIRT, DEBRIS, SUPFACE AND GROUND WATER FROM CONTAMINATING THE WATER MAN. THE WATER LEVEL IN THE EXCAVATION FOR OPEN PIPE ENDS SHALL NEVER BE LESS THAN 12 MOHES BELOW THE INVIERT OF THE WATER MAIN. WHENEVER AN OPEN PIPE END IS LEFT UNATTENDED, IT SHALL BE COVERED IN A WATER TIGHT MANNER.

ALL GATE VALVES REQUIRE MECHANICAL JOINT RESTRAINT WITHIN 18-FEET OF THE VALVE.

ALL NEW DUCTILE IRON WATER MAIN SHALL BE INSTALLED WITH POLYETHYLENE

ALL SERVICE TAPS ON PVC/PVCO WATER MAIN REQUIRE SERVICE SADDLES.

STAINLESS STEEL INSERTS ARE REQUIRED ON ALL POLYETHYLENE (PE) SERVICE FITTINGS.

TRACER WIRE IS REQUIRED ON ALL BURIED NON-METALLIC WATER MAINS AND WATER SERVICES.

Edgewater resources

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PROJECT/CLIENT

PORT OF ROCHESTER MARINA DEVELOPMENT PROJECT

ROCHESTER, NY



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ISSUED FOR

50% DESIGN

DRAWING IIII

CONSTRUCTION DETAILS WATER MAIN

DATE: MARCH 18, 2011

SCALE: NTS

DESIGNED BY:

DRAWN BY:

REVIEWED BY:

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