
PROJECT INFORMATION

PLEASE TYPE OR PRINT PROJECT ADDRESS(ES): 1850-1900 South Ave 1. APPLICANT: Tom O'Connor COMPANY NAME: Al Sigl Community of Agencies 2. CITY: Rochester ZIP CODE: 14620 ADDRESS: 1000 Elmwood Ave, STE 300 PHONE: 585-442-4102 x 8945 FAX: E-MAIL ADDRESS: toconnor@alsigl.org INTEREST IN PROPERTY: Owner |x Lessee Other PLAN PREPARER: John Stapleton, Marathon Engineering ADDRESS: 39 Cascade Drive CITY: Rochester ZIP CODE: 14614 PHONE: 585-458-7770 FAX: _____ E-MAIL ADDRESS: jstapleton@marathoneng.com PROPERTY OWNER (Required): (Must be an individual person): Tom O'Connor (Al Sigl) DETAILED PROJECT DESCRIPTION (PLEASE ATTACH SEPERATELY) Refer to Letter of Intent 5. A detailed project description shall include, but not be limited to, the following information: Project acreage; existing and proposed uses and their hours of operation; total square footage; square footage of individual project components; existing and proposed dwelling units and the number of bedrooms in each unit; height of existing and proposed structure(s) in feet and stories; and the number of existing and proposed parking spaces; façade renovations; and identifying how the site is accessed. LENGTH OF TIME TO COMPLETE PROJECT (Attach schedule if phased): 1 year APPLICANT: I certify that the information supplied on this application is complete and accurate, and that the project described, if approved, will be completed in accordance with the conditions and terms of that approval. explose (marrow Eng) DATE: 7-31-18 **SIGNATURE:**

OWNER (if other than above): I have read and familiarized myself with the contents of this application and do hereby consent to its submission and processing.

SIGNATURE: DATE:____

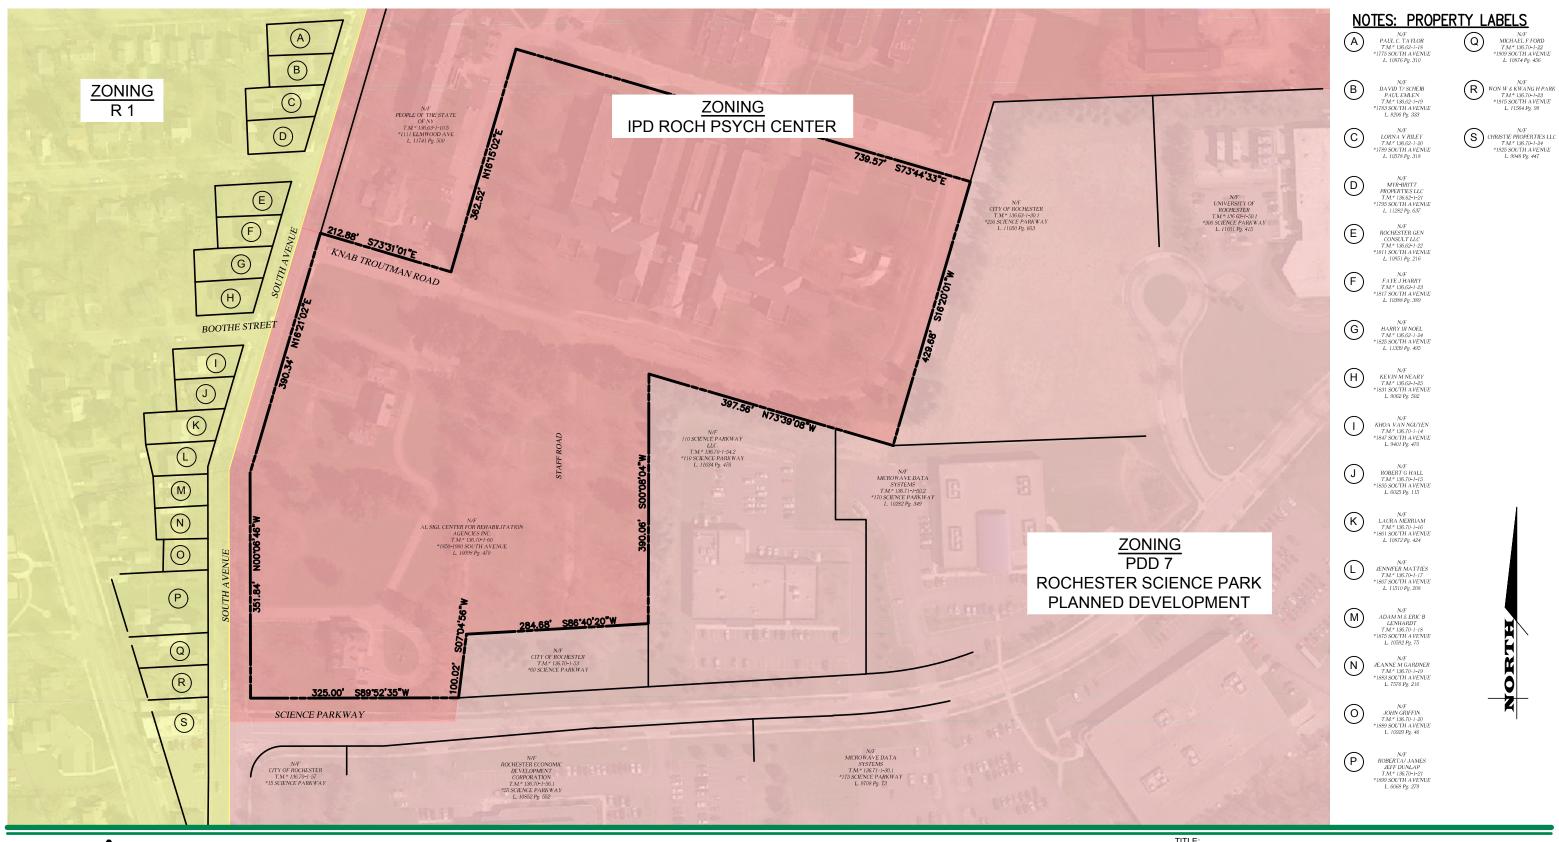

MARATHON 39 CASCADE DRIVE

ROCHESTER, NY 14614

PHONE 585-458-7770 www.marathoneng.com


JOB NO: 0804-16 SCALE: 1" = 150' DRAWN: RLJ

05/18/18

DATE:

EXISTING ZONING DISTRICTS

AL SIGL CAMPUS

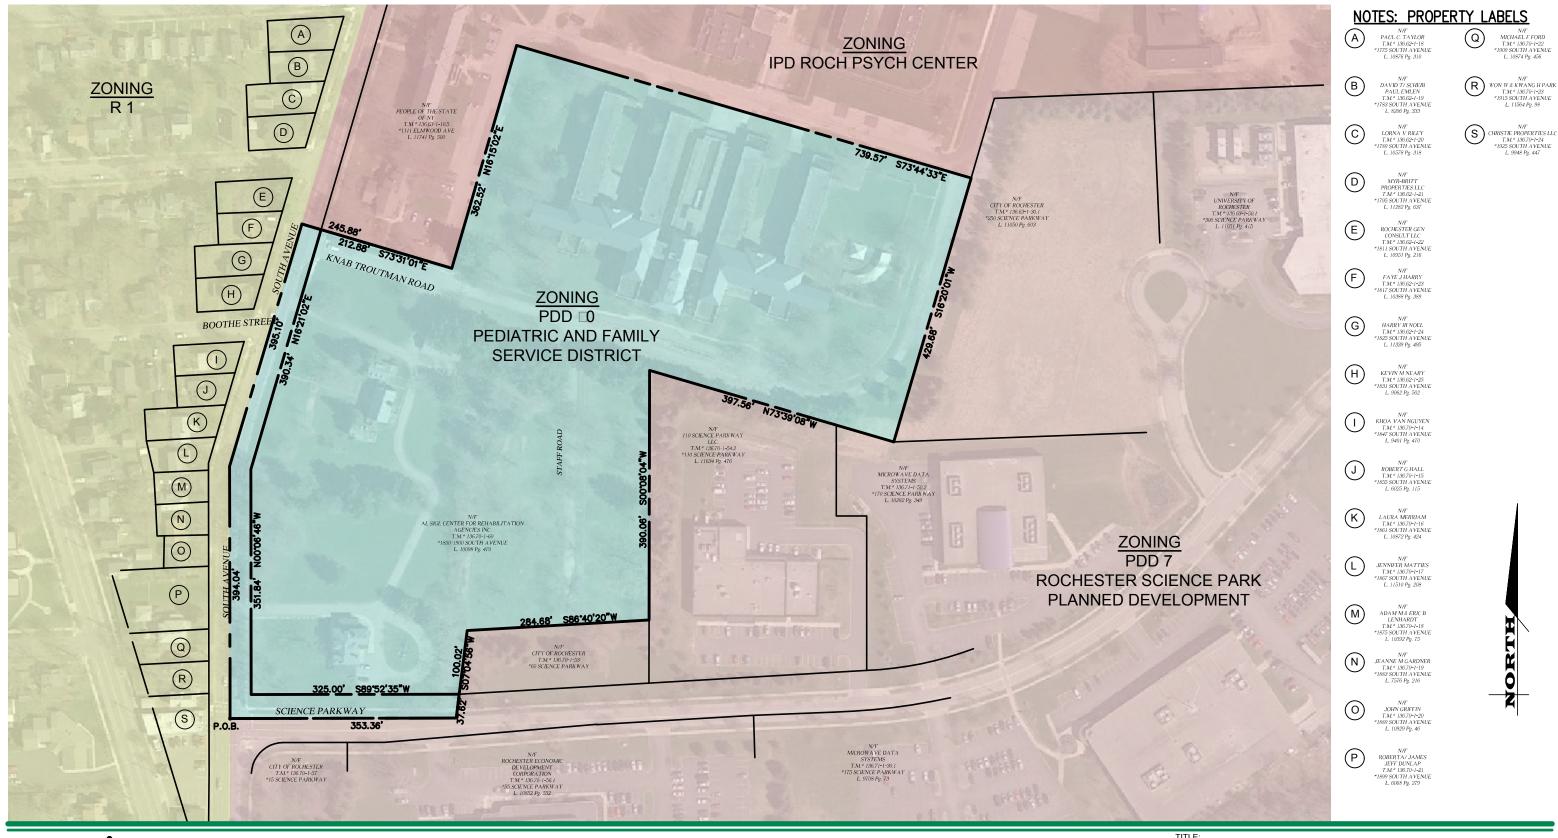

MARATHON **ENGINEERING**

JOB NO: 0804-16 39 CASCADE DRIVE SCALE: 1" = 150' ROCHESTER, NY 14614 DRAWN: RLJ PHONE 585-458-7770 www.marathoneng.com DATE: 07/31/18

PROPOSED ZONING DISTRICT PDD 20

PEDIATRIC AND FAMILY **SERVICE DISTRICT**

CITY OF ROCHESTER MONROE COUNTY NEW YORK

PLANNED DEVELOPMENT DISTRICTS

Planned Development District No. 20 Pediatric and Family Service District

A. Purpose and Intent

- (1) Planned Development District No. 20, Pediatric and Family Service District, is a campus that provides specialized services. Golisano Autism Center is a one of kind collaboration of agencies that provide a comprehensive range of services based in a common location to individuals and families affected by autism spectrum disorder and related disorders. The services provided may include, but are not limited to speech and occupational therapy, support and social skills groups, pre-school and school age classrooms, vocational training, life skills development and other opportunities. In addition, a Pediatric Behavioral Health & Wellness building operated by the University of Rochester Medical Center (URMC) will be located on the campus. Collectively these agencies, and other health and human service organizations will provide educational, recreation and fitness, therapeutic, medical and other support services, activities and programs, and the like. These services will co-exist on a self-contained campus to emphasize the safety, security and privacy of those served.
- (2) PDD No. 20 encompasses approximately 15 acres of land. The northern 7 acres of the site is generally bounded by Knab Troutman Road to the south and east, and by land owned by the State of New York to the north and west. This portion of the property includes a vacant, multi-story structure known as the Walters Building, for which there is no proposed use or redevelopment.
 - The southern 8 acres of the site is generally bounded by Science Parkway to the south, South Avenue to the west, and Knab Troutman Road to the north. This portion of the property includes a two-story structure that is currently occupied by a health and human services agency. The remainder of the land area is vacant and is the location of the Golisano Autism Center and a Pediatric Behavioral Health and Wellness building.
- B. Permitted Uses. Permitted uses include the following, and the like, uses:
 - (1) Medical Offices and Health Care Clinics, such as medical offices and practices, dental offices and practices, outpatient services, and the like
 - (2) Schools, Educational Facilities, Training Facilities, and the like, serving individuals and their families
 - (3) Day Care Centers
 - (4) Residential Care Facilities
 - (5) Respite Care
 - (6) Community Centers

PDD No. 20 Page 1 of 6

- (7) Sheltered Workshops
- (8) Support services associated with and subordinate to a permitted use, such as but not limited to offices, retail, restaurant facilities, bookstores and gift shops, pharmacies, and the like.
- C. Bulk, space and yard requirements.

(1) Maximum Lot Coverage: 80%

(2) Maximum building height: 4 stories or 60 feet

(3) Minimum yard requirements:

(a) South Avenue:

[2] Principal buildings: 90 feet

(b) Science Parkway:

[2] Principal buildings: 30 feet

D. Building Characteristics

The provisions of § 120-158 City-wide design standards and of § 120-159 Nonresidential and mixed-use building standards shall not apply to Planned Development District No. 20. Design standards are as set forth below:

- (1) General. The following design standards apply to nonresidential and mixed-use development. They apply to new construction, including additions to existing structures, and to substantial repair or rehabilitation of the exterior facade of an existing structure. In the case of repair or rehabilitation, only those standards that relate to the specific repair or rehabilitation activities conducted shall apply. It is intended that a basic design compatibility and architectural harmony will result among the buildings in the district.
- (2) Façades. The exterior shall be a mixture of materials. The materials and forms are intended to be warm and natural to provide a comfortable and inviting façade while projecting a professional appearance. Building facades that are 100 linear feet or more shall include an architectural pattern with two or more of the following elements: color change, texture change, material change, or a wall articulation change such as a reveal, recess, offset, or pilaster.
- (3) Building entrances. The main entrance shall have a direct pedestrian connection to the parking facility.
- (4) Building materials.
 - (a) Exterior walls. The following building materials are prohibited on any exterior wall:

PDD No. 20 Page 2 of 6

- Concrete finishes or precast concrete panels (tilt wall) that are not exposed aggregate, hammered, embossed, imprinted, sandblasted or covered with a cement-based acrylic coating.
- Metal panels with a depth of less than one inch or a thickness less than U.S.
 Standard 26 gauge.
- 3) Mirrored glass with a reflectance greater than 40% shall be prohibited from covering more than 40% of the exterior walls of any building.
- (b) Facades. The following building materials are prohibited on any facade:
 - 1) Plain concrete block
 - 2) Glass block
 - 3) Exposed aggregate (rough finish) concrete wall panels
 - 4) Exterior insulating finish systems (EIFS) installed lower than four feet above grade on any building facade
 - 5) T-111 plywood or oriented strand board (OSB) siding.
 - 6) Plastic.
 - 7) Vinyl, except cellular vinyl trim may be used as decorative or detail elements for up to 25% of the facade.
 - 8) Metal, except metal may be used as decorative or detail elements for up to 30% of the facade.
- (c) Windows and transparency.
 - 1) All windows shall be clear or lightly tinted.
 - 2) All new construction on building facades that are within 50 feet of a dedicated street right-of-way shall provide areas of transparency not less than 30% of the wall area between the height of two feet and eight feet from the ground.
 - 3) The percentage of transparency required on buildings may be reduced to 20% of the wall area if landscaping improvements consisting of one tree of at least twoinch caliper for every 20 feet of lot frontage are installed between the building and the public street.
- (5) Fenestration may be composed of both fixed and operable units.
- (6) Roofs. It is preferred that the buildings have a flat roof, which may house necessary mechanical and/or electrical equipment, and the like. Roof screens, if used, shall be compatible with the building palette.

PDD No. 20 Page 3 of 6

- a. Green roof, blue roof, and white roof designs are permitted
- Reflective surfaces that produce glare are prohibited, except for solar panels or white roofs intended to radiate absorbed or nonreflected solar energy and reduce heat transfer to the building.

E. Accessory Uses and Structures

- (1) Accessory structures and uses are permitted in the side and rear yard in conjunction with the uses permitted within the district, including without limitation storage structures, as well as decks, patios, and terraces, and the like.
- (2) Maximum building size: 2,500 square feet
- (3) Fences
 - (a) Chain-link fence is not permitted in the front yard
 - (b) Maximum height

[1] Front Yard: 6 feet[2] Other Yards: 10 feet

F. Off-Street Parking

The provisions of § 120-173 Off-street parking shall not apply to Planned Development District No. 20. Off-street parking requirements are as set forth below:

- (1) Parking Location
 - (a) Parking for uses within the Pediatric and Family Service District may be located anywhere within the district, as well as outside the district provided that a shuttle service, or the like, to the district is provided.
 - (b) Setback

i. South Avenue: 20 feetii. Science Parkway: 20 feet

- (2) Surface
 - (a) Parking areas shall be constructed in such a manner so as to provide an all-weather, durable and dustless surface. Individual stalls shall be clearly identified by markings four to six inches in width.
 - (b) Parking surfaces shall be graded and drained to dispose of all surface water accumulation in the area without shedding additional water on an adjoining property or right-of-way.

PDD No. 20 Page 4 of 6

(3) Site Lighting

- (a) Illumination shall not be used for the purpose of advertising or attracting attention to the principal use.
- (b) Lighting fixtures shall be designed, sized and located so as not to cast direct rays of excessive brightness upon adjoining premises or cause glare hazardous to pedestrians or person using adjacent public streets.
- (c) Parking lots used after sundown shall be lighted to give protection to persons using the lot and the light source shall cast down.
- (d) All parking lots shall be required to provide lighting from dusk to dawn that meets the Illumination Engineers Society of North America (IESNA) standards for that particular use.

G. Off-street Loading

The provisions of § 120-172 Off-street loading shall not apply to this district. Off-street loading requirements are as set forth below.

- (1) Location of required loading spaces. Loading spaces shall be located on the same lot, or on a directly adjoining lot, as the building or structure to which they are accessory. No loading space shall be located in any required front yard setback.
- (2) Required spaces. Loading spaces shall be provided in sufficient number and of sufficient size so that no loading and unloading operations infringe upon any dedicated street or sidewalk.
- (3) Loading and unloading operations shall take place wholly within the site.

H. Signage

- (1) A sign program shall be developed for the district which will include building, and/or tenant identification, wayfinding, and event promotion. The sign program shall be subject to Administrative Adjustment Approval by the Manager of Zoning, subject to Section 120-191A of the Rochester Zoning Code.
- I. Personal wireless telecommunication facilities (PWTF)

The provisions of § 120-143 Personal wireless telecommunication facilities shall apply to this district, except as modified below.

(1) Antennas on buildings. Antennas are permitted on all buildings which are four stories in height or greater, provided that the antennas and related support structures do not extend more than 20 feet above the roofline of such buildings.

PDD No. 20 Page 5 of 6

- (2) Antennas on existing towers. Antennas on existing telecommunication towers or other structures shall be permitted unless otherwise restricted pursuant to the terms of a prior special permit.
- (3) Telecommunication towers. Telecommunication towers shall be permitted in Planned Development District No. 20, provided that the base of the tower is located at least 100 feet from the nearest residential building, open space or preservation district or landmark and the height of the tower does not exceed 100 feet.

(4) Setback

i. Street yards: 10 feet.

ii. Other yards: zero feet.

iii. Street yard setback areas shall be landscaped

J. Additional Regulations

- (1) The provisions of § 120-146 Residential care facilities shall not apply to this district.
- (2) Development and redevelopment in PD No. 20 is subject to Requirements Applying to All Districts (Article XX), except as herein modified.
- (3) The general height and yard exceptions set forth in Article XXIII shall apply to this district.

PDD No. 20 Page 6 of 6

Full Environmental Assessment Form Part 1 - Project and Setting

Instructions for Completing Part 1

Part 1 is to be completed by the applicant or project sponsor. Responses become part of the application for approval or funding, are subject to public review, and may be subject to further verification.

Complete Part 1 based on information currently available. If additional research or investigation would be needed to fully respond to any item, please answer as thoroughly as possible based on current information; indicate whether missing information does not exist, or is not reasonably available to the sponsor; and, when possible, generally describe work or studies which would be necessary to update or fully develop that information.

Applicants/sponsors must complete all items in Sections A & B. In Sections C, D & E, most items contain an initial question that must be answered either "Yes" or "No". If the answer to the initial question is "Yes", complete the sub-questions that follow. If the answer to the initial question is "No", proceed to the next question. Section F allows the project sponsor to identify and attach any additional information. Section G requires the name and signature of the project sponsor to verify that the information contained in Part 1 is accurate and complete.

A. Project and Sponsor Information.

of two projects: a 30,500 +/- squal dentified as a Pediatric Behaviora	re-foot single story building I Health & Wellness building	
or the 8+/- acres being developed eable future	the 7 acres containing the	
ame of Applicant/Sponsor: Telephone: 585-442-4102 x 8945		
E-Mail: tconnor@alsigl.com		
State: New York	Zip Code: 14620	
Telephone: 585-458-7770		
E-Mail: jstapleton@marathoneng.com		
State:	Zip Code:	
NY	14614	
Telephone:		
E-Mail:		
State:	Zip Code:	
	State: New York Telephone: 585-458-7770 E-Mail: jstapleton@marathone State: NY Telephone: E-Mail:	

B. Government Approvals

B. Government Approvals, Funding, or Spor assistance.)	sorship. ("Funding" includes grants, loans, ta	ax relief, and any other	r forms of financial
Government Entity	If Yes: Identify Agency and Approval(s) Required	Applicati (Actual or	
a. City Council, Town Board, ✓Yes□No or Village Board of Trustees	City Council: Rezoning	August 2018	
b. City, Town or Village ☐Yes☑No Planning Board or Commission	Site Plan approval by City Manager of Zoning	August 2018	
c. City Council, Town or ☐Yes☑No Village Zoning Board of Appeals			
d. Other local agencies ✓Yes□No	Rochester Water Bureau & Rochester Pure Waters: Site Plan for utility connections		
e. County agencies ∠ Yes No	MC Dept of Health: Site Plan MCDOT: Traffic analysis & curb cuts		
f. Regional agencies			
g. State agencies ✓Yes□No	NYSDEC: SWPPP		
h. Federal agencies ☐Yes☑No			
i. Coastal Resources.i. Is the project site within a Coastal Area, o	r the waterfront area of a Designated Inland W	aterway?	□Yes Z No
ii. Is the project site located in a community iii. Is the project site within a Coastal Erosion		ion Program?	✓ Yes ✓ No
C. Planning and Zoning			
C.1. Planning and zoning actions.			
 Will administrative or legislative adoption, or ar only approval(s) which must be granted to enab If Yes, complete sections C, F and G. If No, proceed to question C.2 and complete sections C.2. 		-	∏Yes Z INo
C.2. Adopted land use plans.			
a. Do any municipally- adopted (city, town, vill where the proposed action would be located?	age or county) comprehensive land use plan(s)	include the site	∠ Yes□No
If Yes, does the comprehensive plan include spe would be located?	cific recommendations for the site where the p	roposed action	□Yes ☑ No
 b. Is the site of the proposed action within any log Brownfield Opportunity Area (BOA); designation or other?) If Yes, identify the plan(s): NYS Heritage Areas:West Erie Canal Corridor 	ocal or regional special planning district (for ex ted State or Federal heritage area; watershed r		∠ Yes□No
 c. Is the proposed action located wholly or partion or an adopted municipal farmland protection. If Yes, identify the plan(s): 		pal open space plan,	□Yes Z No

C.3. Zoning	
a. Is the site of the proposed action located in a municipality with an adopted zoning law or ordinance. If Yes, what is the zoning classification(s) including any applicable overlay district? The City Zoning Map identifies this land as IPD (Institutional Planned Development). The City Zoning Code does not recognize outdated zoning district.	☐ Yes ☑ No this district, as it is an
b. Is the use permitted or allowed by a special or conditional use permit?	□Yes☑No
c. Is a zoning change requested as part of the proposed action? If Yes, i. What is the proposed new zoning for the site Planned Development District # 20 Pediatric and Family Service District	☑ Yes□No
C.4. Existing community services.	
a. In what school district is the project site located? Rochester City School District	
b. What police or other public protection forces serve the project site? <u>City of Rochester Police</u> , with assistance from neighboring municipalities, as well as County Sheriffs and State Police	
c. Which fire protection and emergency medical services serve the project site? City of Rochester; American Medical Response (AMR) of Rochester with assistance from neighboring municipalities.	
d. What parks serve the project site? <u>City and County Parks, including Highland Park, Genesee Valley Park, and Bausch & Lomb Riverfront Park.</u>	
D. Project Details	
D.1. Proposed and Potential Development	
a. What is the general nature of the proposed action (e.g., residential, industrial, commercial, recreational; if mixed, components)? Health and human service organizations	include all
b. a. Total acreage of the site of the proposed action? b. Total acreage to be physically disturbed? c. Total acreage (project site and any contiguous properties) owned or controlled by the applicant or project sponsor? 15.1 +/- acres 15.1 +/- acres	
c. Is the proposed action an expansion of an existing project or use? i. If Yes, what is the approximate percentage of the proposed expansion and identify the units (e.g., acres, miles, however, square feet)? % Units:	☐ Yes☑ No nousing units,
d. Is the proposed action a subdivision, or does it include a subdivision? If Yes, i. Purpose or type of subdivision? (e.g., residential, industrial, commercial; if mixed, specify types)	∐Yes Z INo
 ii. Is a cluster/conservation layout proposed? iii. Number of lots proposed?	□Yes □No
e. Will proposed action be constructed in multiple phases? i. If No, anticipated period of construction: months ii. If Yes: Total number of phases anticipated Anticipated commencement date of phase 1 (including demolition) Anticipated completion date of final phase Anticipated completion date of final phase Generally describe connections or relationships among phases, including any contingencies where progress determine timing or duration of future phases: The first three buildings and possibly a connector building will be built in 2018-2019. Subsequent buildings will be built determined.	
availability of funding. Long term vision includes the renovation of the Walters building, but there are no plans, nor have funding sour	ces been identified.

f Does the project	ct include new resid	ential uses?			□Yes☑No
	bers of units propo				1032110
, 11 1 00, 0110 11 11011	One Family	Two Family	Three Family	Multiple Family (four or more)	
Initial Dhana					
Initial Phase At completion					
of all phases					
or an phases	-				
g. Does the propo	osed action include	new non-residentia	al construction (inclu	iding expansions)?	Z Yes□No
If Yes,					
i. Total number	of structures	3			
				165 width; and 210 length	
iii. Approximate	extent of building s	space to be heated	or cooled:	72,500 square feet	
				l result in the impoundment of any	Z Yes □No
	s creation of a water	r supply, reservoir	, pond, lake, waste la	agoon or other storage?	
If Yes,	1 01-				
	e impoundment: Stor			☐ C111	[7]O ₄
Stormwater	oundment, the princ			Ground water Surface water stream	ns Votner specify:
iii. If other than v	vater, identify the ty	pe of impounded/	contained liquids and	d their source.	
iv Annroximate	size of the proposed	d impoundment	Volume:	0.30 million gallons; surface area:	1+/- acres
v. Dimensions o	f the proposed dam	or impounding str	ructure:	4 height; 50 length	117- deles
vi. Construction	method/materials f	or the proposed da	m or impounding str	ructure (e.g., earth fill, rock, wood, cond	rete):
			ne emergency spillway	· -	,
D.2. Project Ope	erations				
				uring construction, operations, or both?	☐ Yes Z No
		ition, grading or in	stallation of utilities	or foundations where all excavated	
materials will r If Yes:	emain onsite)				
	rpose of the excava	tion or dradging?			
ii How much ma	terial (including roc	ek earth sediment	etc) is proposed to	be removed from the site?	
Volume	(specify tons or cub	nic vards).	s, etc.) is proposed to		
 Over wh 	at duration of time?)			
iii. Describe natur	re and characteristic	s of materials to b	e excavated or dreds	ged, and plans to use, manage or dispose	of them.
2 37711 4 1		• •	. 1		
If yes, describ	onsite dewatering o	or processing of ex	cavated materials?		∐Yes∐No
ii yes, desciii	···				
y What is the to	tal area to be dredge	ed or excavated?		acres	
	aximum area to be			acres acres	
				feet	
	vation require blast				∏Yes∏No
b. Would the prop	oosed action cause o	or result in alteration	on of, increase or dec	crease in size of, or encroachment	☐Yes Z No
			ch or adjacent area?	•	
If Yes:					
				vater index number, wetland map number	
description):					

ii. Describe how the proposed action would affect that waterbody or wetland, e.g. excavation, fill, placement alteration of channels, banks and shorelines. Indicate extent of activities, alterations and additions in square	
iii. Will proposed action cause or result in disturbance to bottom sediments? If Yes, describe:	□Yes□No
iv. Will proposed action cause or result in the destruction or removal of aquatic vegetation? If Yes:	☐ Yes ☐ No
acres of aquatic vegetation proposed to be removed:	
expected acreage of aquatic vegetation remaining after project completion:	
purpose of proposed removal (e.g. beach clearing, invasive species control, boat access):	500 h
proposed method of plant removal:	
if chemical/herbicide treatment will be used, specify product(s):	110000000000000000000000000000000000000
v. Describe any proposed reclamation/mitigation following disturbance:	
c. Will the proposed action use, or create a new demand for water? If Yes:	Z Yes □No
i. Total anticipated water usage/demand per day: 7,600 gallons/day	
ii. Will the proposed action obtain water from an existing public water supply?	Z Yes □No
f Yes:	₩ 1 €3 <u></u> 110
Name of district or service area: City of Rochester	
Does the existing public water supply have capacity to serve the proposal?	✓ Yes No
• Is the project site in the existing district?	✓ Yes No
• Is expansion of the district needed?	☐ Yes ✓ No
Do existing lines serve the project site?	✓ Yes No
iii. Will line extension within an existing district be necessary to supply the project? f Yes:	✓Yes □No
Describe extensions or capacity expansions proposed to serve this project:	
Extension of private waterlines (ductile iron), new hydrants and services - all with backflow protection	
Source(s) of supply for the district: Hemlock Lake	
iv. Is a new water supply district or service area proposed to be formed to serve the project site? f, Yes:	☐ Yes Z No
Applicant/sponsor for new district:	
Date application submitted or anticipated:	
Proposed source(s) of supply for new district:	
v. If a public water supply will not be used, describe plans to provide water supply for the project:	
vi. If water supply will be from wells (public or private), maximum pumping capacity: gallons/minu	te.
d. Will the proposed action generate liquid wastes?	✓ Yes □No
f Yes:	
 i. Total anticipated liquid waste generation per day:	ommon onto and
approximate volumes or proportions of each):	omponents and
Sanitary wastewater (bathrooms, kitchen waste, etc). Any medical waste will be collected & disposed of by licensed haul	er
Will the proposed action was any orietine million and the traction of California	
ii. Will the proposed action use any existing public wastewater treatment facilities? If Yes:	✓ Yes □No
 Name of wastewater treatment plant to be used: Frank E. Van Lare 	
Name of district: Rochester Sewer District	· · · · · · · · · · · · · · · · · · ·
Does the existing wastewater treatment plant have capacity to serve the project?	✓ Yes □No
• Is the project site in the existing district?	✓ Yes □No
Is expansion of the district needed?	☐ Yes Z No
·	

 Do existing sewer lines serve the project site? Will line extension within an existing district be necessary to serve the project? 	Z Yes □No Z Yes □No
If Yes:	
Describe extensions or capacity expansions proposed to serve this project:	
PVC sanitary mains and laterals to the dedicated sewers	
iv. Will a new wastewater (sewage) treatment district be formed to serve the project site? If Yes:	☐Yes Z No
 Applicant/sponsor for new district: 	
Date application submitted or anticipated:	
What is the receiving water for the wastewater discharge?	
v. If public facilities will not be used, describe plans to provide wastewater treatment for the project, including spec	cifying proposed
receiving water (name and classification if surface discharge, or describe subsurface disposal plans):	, <u>8</u> pp
vi. Describe any plans or designs to capture, recycle or reuse liquid waste:	
e. Will the proposed action disturb more than one acre and create stormwater runoff, either from new point	Z Yes □No
sources (i.e. ditches, pipes, swales, curbs, gutters or other concentrated flows of stormwater) or non-point	
source (i.e. sheet flow) during construction or post construction? If Yes:	
<i>i.</i> How much impervious surface will the project create in relation to total size of project parcel?	
139K Square feet or 3.2 acres (impervious surface)	
349K Square feet or 8 acres (parcel size)	
ii. Describe types of new point sources. Parking lots, buildings, sidewalks, etc	
22 What are the control of the contr	
iii. Where will the stormwater runoff be directed (i.e. on-site stormwater management facility/structures, adjacent p groundwater, on-site surface water or off-site surface waters)?	properties,
On-site stormwater management facility to existing stormwater piping systems	
on the stemmater management launty to existing stemmater piping systems	
If to surface waters, identify receiving water bodies or wetlands:	
Ultimately flows to Lake Ontario	
• Will stormwater runoff flow to adjacent properties? iv. Does proposed plan minimize impervious surfaces, use pervious materials or collect and re-use stormwater?	□Yes☑No ☑Yes□No
f. Does the proposed action include, or will it use on-site, one or more sources of air emissions, including fuel combustion, waste incineration, or other processes or operations?	□Yes ☑ No
If Yes, identify:	
i. Mobile sources during project operations (e.g., heavy equipment, fleet or delivery vehicles)	
Typical construction vehicles (dozers / shovels / rollers)	
ii. Stationary sources during construction (e.g., power generation, structural heating, batch plant, crushers)	
Possibly temporary heat for winter construction.	
iii. Stationary sources during operations (e.g., process emissions, large boilers, electric generation)	
Heating systems for the proposed building - type not identified yet.	
g. Will any air emission sources named in D.2.f (above), require a NY State Air Registration, Air Facility Permit,	□Yes ☑ No
or Federal Clean Air Act Title IV or Title V Permit? If Yes:	
i. Is the project site located in an Air quality non-attainment area? (Area routinely or periodically fails to meet	□Yes□No
ambient air quality standards for all or some parts of the year)	
ii. In addition to emissions as calculated in the application, the project will generate:	
•Tons/year (short tons) of Carbon Dioxide (CO ₂)	
•Tons/year (short tons) of Nitrous Oxide (N ₂ O)	
•Tons/year (short tons) of Perfluorocarbons (PFCs)	
• Tons/year (short tons) of Sulfur Hexafluoride (SF ₆)	
•Tons/year (short tons) of Carbon Dioxide equivalent of Hydroflourocarbons (HFCs)	
 Tons/year (short tons) of Hazardous Air Pollutants (HAPs) 	

h. Will the proposed action generate or emit methane (includ landfills, composting facilities)? If Yes:	ling, but not limited to, sewage treatment plants,	□ Yes □ No
i. Estimate methane generation in tons/year (metric):ii. Describe any methane capture, control or elimination mean electricity, flaring):	asures included in project design (e.g., combustion to ge	enerate heat or
Will the proposed action result in the release of air pollutar quarry or landfill operations? If Yes: Describe operations and nature of emissions (e.g., die proposed action result in the release of air pollutar quarry or landfill operations?		□ Yes □ No
j. Will the proposed action result in a substantial increase in a new demand for transportation facilities or services? If Yes: *Refer to attached Traffic Impact Study prepared by SRF Association i. When is the peak traffic expected (Check all that apply): □ Randomly between hours of to	tes ☐ Morning ☐ Evening ☐ Weekend —·	□ Yes □ No
iv. Does the proposed action include any shared use parking v. If the proposed action includes any modification of exist	g?	\square Yes \square No
vi. Are public/private transportation service(s) or facilities a vii Will the proposed action include access to public transpo or other alternative fueled vehicles?viii. Will the proposed action include plans for pedestrian or pedestrian or bicycle routes?	ortation or accommodations for use of hybrid, electric	□ Yes □ No □ Yes □ No □ Yes □ No
k. Will the proposed action (for commercial or industrial profor energy?If Yes:i. Estimate annual electricity demand during operation of the		□ Yes □ No
<i>ii.</i> Anticipated sources/suppliers of electricity for the project other):	t (e.g., on-site combustion, on-site renewable, via grid/le	ocal utility, or
iii. Will the proposed action require a new, or an upgrade to,	an existing substation?	□ Yes □ No
Hours of operation. Answer all items which apply. i. During Construction:	 ii. During Operations: Monday - Friday: Saturday: Sunday: Holidays: 	

m. Will the proposed action produce noise that will exceed existing ambient noise levels during construction, operation, or both? If yes:	Z Yes □No
 i. Provide details including sources, time of day and duration: Construction equipment operations, delivery, etc., during construction period. 	
ii. Will proposed action remove existing natural barriers that could act as a noise barrier or screen? Describe:	☐ Yes Z No
n Will the proposed action have outdoor lighting? If yes:	Z Yes □No
 Describe source(s), location(s), height of fixture(s), direction/aim, and proximity to nearest occupied structures: Parking lot light poles, building mounted light fixtures - only enough for safe convenient ingress & egress - no light spillage off process. 	roperty
 ii. Will proposed action remove existing natural barriers that could act as a light barrier or screen? Describe:	☐Yes Z No
o. Does the proposed action have the potential to produce odors for more than one hour per day? If Yes, describe possible sources, potential frequency and duration of odor emissions, and proximity to nearest occupied structures:	□Yes Z No
p. Will the proposed action include any bulk storage of petroleum (combined capacity of over 1,100 gallons) or chemical products 185 gallons in above ground storage or any amount in underground storage? If Yes: i. Product(s) to be stored ii. Volume(s) per unit time (e.g., month, year) iii. Generally describe proposed storage facilities:	☐ Yes ☑ No
 q. Will the proposed action (commercial, industrial and recreational projects only) use pesticides (i.e., herbicides, insecticides) during construction or operation? If Yes: i. Describe proposed treatment(s): Some level of pesticides or herbicides may be used during operation - contracted to a licensed applicator if purs 	☑ Yes □No
ii. Will the proposed action use Integrated Pest Management Practices?	✓ Yes □No
r. Will the proposed action (commercial or industrial projects only) involve or require the management or disposal of solid waste (excluding hazardous materials)? If Yes: i. Describe any solid waste(s) to be generated during construction or operation of the facility: • Construction:	
Operation:	
 iii. Proposed disposal methods/facilities for solid waste generated on-site: Construction: Local hauler 	
Operation: Local hauler - also may include medical waste (licensed hauler)	


s. Does the proposed action include construction or mod	ification of a solid waste m	nanagement facility?	Yes 🗸 No
If Yes:			
i. Type of management or handling of waste proposed for the site (e.g., recycling or transfer station, composting, landfill, or			
other disposal activities):			
ii. Anticipated rate of disposal/processing:Tons/month, if transfer or other non-	aambustian/thammal treatm	agent or	
Tons/hour, if combustion or thermal		ient, or	
iii. If landfill, anticipated site life:	vears		
		P 1 C1 1	
t. Will proposed action at the site involve the commercia waste?	I generation, treatment, sto	orage, or disposal of hazardous	☑ Yes □ No
waste? If Yes:			
i. Name(s) of all hazardous wastes or constituents to be	e generated handled or ma	naged at facility:	
	generated, namerou or ma		
ii. Generally describe processes or activities involving h	nazardous wastes or constit	tuents:	244
Swabs/needles			
iii. Specify amount to be handled or generated 0.1 to	ons/month		
iv. Describe any proposals for on-site minimization, rec	young or reuse of nazardo	us constituents:	
	· · · · · · · · · · · · · · · · · · ·		
v. Will any hazardous wastes be disposed at an existing	offsite hazardous waste fa	acility?	✓ Yes No
If Yes: provide name and location of facility:	,	,	
Facility preference of licensed hauler			
If No: describe proposed management of any hazardous	wastes which will not be so	ent to a hazardous waste facility	/:
E. Site and Setting of Proposed Action			
L. Site and Setting of Froposed Action			
E.1. Land uses on and surrounding the project site			
a. Existing land uses.			
i. Check all uses that occur on, adjoining and near the	project site.		
☑ Urban ☑ Industrial ☑ Commercial ☑ Resid	lential (suburban) 🔲 Ru	ıral (non-farm)	
☐ Forest ☐ Agriculture ☐ Aquatic ☐ Other	(specify): Institutional / Hur	man Services	
ii. If mix of uses, generally describe:			
b. Land uses and covertypes on the project site.			
Land use or	Current	Acreage After	Change
Covertype	Acreage	Project Completion	(Acres +/-)
Roads, buildings, and other paved or impervious			
surfaces	1.3	3.2	1.9+
• Forested			
Meadows, grasslands or brushlands (non-			
agricultural, including abandoned agricultural)	0.6	0.0	0.6-
Agricultural			
(includes active orchards, field, greenhouse etc.)			
Surface water features	· · · · · · · · · · · · · · · · · · ·		
(lakes, ponds, streams, rivers, etc.)	0.0	0.6	0.6+
(lakes, ponds, streams, rivers, etc.) • Wetlands (freshwater or tidal)	0.0	0.6	0.6+
• Wetlands (freshwater or tidal)	0.0	0.6	0.6+
 Wetlands (freshwater or tidal) Non-vegetated (bare rock, earth or fill) 	0.0	0.6	0.6+
 Wetlands (freshwater or tidal) Non-vegetated (bare rock, earth or fill) Other 	0.0	0.6	0.6+
 Wetlands (freshwater or tidal) Non-vegetated (bare rock, earth or fill) 	6.1	0.6	0.6+

c. Is the project site presently used by members of the community for public recreation?	□Yes☑No
i. If Yes: explain:	LI TESLLINO
d. Are there any facilities serving children, the elderly, people with disabilities (e.g., schools, hospitals, licensed day care centers, or group homes) within 1500 feet of the project site? If Yes,	✓ Yes No
i. Identify Facilities:	
Al Sigl Community of Agencies, Mary Cariola Children's Center, Ellawanger Barry Nursery School, Monroe County Community Psychiatric Center, University of Rochester Strong Memorial Hospital	Hospital, Rochester
e. Does the project site contain an existing dam?	☐ Yes 7 No
If Yes:	
i. Dimensions of the dam and impoundment:	
• Dam height:	
• Dam length: feet	
• Surface area: acres	
Volume impounded: gallons OR acre-feet ## Dans's spiriting housed also different in the spiriting in the spiriti	
ii. Dam's existing hazard classification: iii. Provide date and summarize results of last inspection:	
m. Flovide date and summarize results of last hispection.	
f. Has the project site ever been used as a municipal, commercial or industrial solid waste management facility, or does the project site adjoin property which is now, or was at one time, used as a solid waste management facil If Yes:	□Yes ☑ No ity?
i. Has the facility been formally closed?	□Yes□ No
If yes, cite sources/documentation:	
ii. Describe the location of the project site relative to the boundaries of the solid waste management facility:	
iii. Describe any development constraints due to the prior solid waste activities:	
g. Have hazardous wastes been generated, treated and/or disposed of at the site, or does the project site adjoin property which is now or was at one time used to commercially treat, store and/or dispose of hazardous waste? If Yes:	☐Yes ☑ No
i. Describe waste(s) handled and waste management activities, including approximate time when activities occurre	ed:
h. Potential contamination history. Has there been a reported spill at the proposed project site, or have any remedial actions been conducted at or adjacent to the proposed site? If Yes:	☐Yes No
 i. Is any portion of the site listed on the NYSDEC Spills Incidents database or Environmental Site Remediation database? Check all that apply: 	□Yes□No
Yes – Spills Incidents database Provide DEC ID number(s):	
☐ Yes – Environmental Site Remediation database Provide DEC ID number(s): Neither database	
ii. If site has been subject of RCRA corrective activities, describe control measures:	
iii. Is the project within 2000 feet of any site in the NYSDEC Environmental Site Remediation database? If yes, provide DEC ID number(s):	
iv. If yes to (i), (ii) or (iii) above, describe current status of site(s):	


v. Is the project site subject to an institutional control limiting property uses?	□Yes☑No
If yes, DEC site ID number:	
Describe the type of institutional control (e.g., deed restriction or easement):	
Describe any use limitations:	
 Describe any engineering controls: Will the project affect the institutional or engineering controls in place? 	Yes □No
Explain:	L res_ino
Lapiani,	
E.2. Natural Resources On or Near Project Site	
a. What is the average depth to bedrock on the project site? > 6 feet	
b. Are there bedrock outcroppings on the project site?	☐ Yes Z No
	<u>%</u>
c. Predominant soil type(s) present on project site: Ontario Loam (OnB)	
	%
	%
d. What is the average depth to the water table on the project site? Average:< 6 feet	
e. Drainage status of project site soils: Well Drained: 100 % of site	
☐ Moderately Well Drained: % of site	
Poorly Drained% of site	
	% of site
	% of site
☐ 15% or greater:	% of site
g. Are there any unique geologic features on the project site?	□Yes☑No
If Yes, describe:	
h. Surface water features.	
i. Does any portion of the project site contain wetlands or other waterbodies (including streams,	rivers, □Yes ✓No
ponds or lakes)?	, company
ii. Do any wetlands or other waterbodies adjoin the project site?	□Yes ∠ No
If Yes to either <i>i</i> or <i>ii</i> , continue. If No, skip to E.2.i.	
iii. Are any of the wetlands or waterbodies within or adjoining the project site regulated by any f state or local agency?	ederal, Yes No
iv. For each identified regulated wetland and waterbody on the project site, provide the following	information:
	fication
Laborar Bandar Nama	C 4:
• Wetlands: Name Appro	oximate Size
Wetlands: Name Appro Wetland No. (if regulated by DEC) Are any of the phase water hadies listed in the most recent compilation of NVS water quality.	
v. Are any of the above water bodies listed in the most recent compilation of NYS water quality-waterbodies?	impaired ☐Yes ☑ No
If yes, name of impaired water body/bodies and basis for listing as impaired:	
i. Is the project site in a designated Floodway?	□Yes ∠ No
j. Is the project site in the 100 year Floodplain?	Yes Z No
k. Is the project site in the 500 year Floodplain?	Yes Z No
l. Is the project site located over, or immediately adjoining, a primary, principal or sole source aq If Yes:	uifer? Z Yes N o
i. Name of aquifer: Principal Aquifer, Primary Aquifer	

m. Identify the predominant wildlife species Squirrels Birds	that occupy or use the project site: Chipmunks	Rabbits	
n. Does the project site contain a designated of the first of the first of the habitat/community (composition).	·	ition):	∐Yes Z No
 ii. Source(s) of description or evaluation:	proposed:ant or animal that is listed by the fede	acres acres acres eral government or NYS as	☐ Yes Z No
p. Does the project site contain any species of special concern?	of plant or animal that is listed by NY	'S as rare, or as a species of	☐Yes ☑ No
q. Is the project site or adjoining area current If yes, give a brief description of how the pro			□Yes ☑ No
E.3. Designated Public Resources On or N	ear Project Site		
a. Is the project site, or any portion of it, local Agriculture and Markets Law, Article 25-If Yes, provide county plus district name/nur	ted in a designated agricultural distriction AA, Section 303 and 304?	ct certified pursuant to	□Yes Z No
b. Are agricultural lands consisting of highly i. If Yes: acreage(s) on project site? ii. Source(s) of soil rating(s):	productive soils present?		∐Yes Z No
c. Does the project site contain all or part of, Natural Landmark? If Yes: i. Nature of the natural landmark:	Biological Community G	Geological Feature	□Yes ☑ No
d. Is the project site located in or does it adjoint Yes: i. CEA name: ii. Basis for designation: iii. Designating agency and date:			□Yes ☑ No

e. Does the project site contain, or is it substantially contiguous to, a bu which is listed on, or has been nominated by the NYS Board of Histo State or National Register of Historic Places? If Yes: i. Nature of historic/archaeological resource: Archaeological Site ii. Name: iii. Brief description of attributes on which listing is based:		☐ Yes [] No
f. Is the project site, or any portion of it, located in or adjacent to an are archaeological sites on the NY State Historic Preservation Office (SH		☑ Yes □ No
g. Have additional archaeological or historic site(s) or resources been id If Yes: i. Describe possible resource(s): ii. Basis for identification:		∐Yes ∏ No
h. Is the project site within fives miles of any officially designated and pascenic or aesthetic resource? If Yes: i. Identify resource: ii. Nature of, or basis for, designation (e.g., established highway overloads)		□Yes ☑No
etc.):	iles.	
 i. Is the project site located within a designated river corridor under the Program 6 NYCRR 666? If Yes: i. Identify the name of the river and its designation: 	Wild, Scenic and Recreational Rivers	☐ Yes No
ii. Is the activity consistent with development restrictions contained in	6NYCRR Part 666?	□Yes □No
F. Additional Information Attach any additional information which may be needed to clarify you If you have identified any adverse impacts which could be associated measures which you propose to avoid or minimize them.		npacts plus any
G. Verification I certify that the information provided is true to the best of my knowle	dge.	
Applicant/Sponsor Name John Stapleton, Marathon Engineering, as agent	Date_07/31/2018	
Signature John Styller	Title Project Manager, Marathon Engineering	

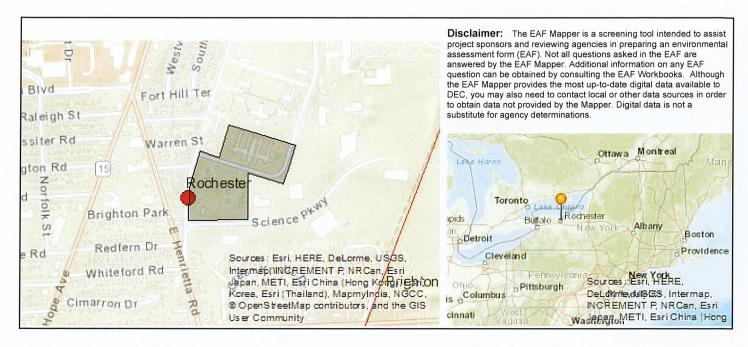

B.i.i [Coastal or Waterfront Area]	No
B.i.ii [Local Waterfront Revitalization Area]	Yes
C.2.b. [Special Planning District]	Yes - Digital mapping data are not available for all Special Planning Districts. Refer to EAF Workbook.
C.2.b. [Special Planning District - Name]	NYS Heritage Areas: West Erie Canal Corridor
E.1.h [DEC Spills or Remediation Site - Potential Contamination History]	Digital mapping data are not available or are incomplete. Refer to EAF Workbook.
E.1.h.i [DEC Spills or Remediation Site - Listed]	Digital mapping data are not available or are incomplete. Refer to EAF Workbook.
E.1.h.i [DEC Spills or Remediation Site - Environmental Site Remediation Database]	Digital mapping data are not available or are incomplete. Refer to EAF Workbook.
E.1.h.iii [Within 2,000' of DEC Remediation Site]	No
E.2.g [Unique Geologic Features]	No
E.2.h.i [Surface Water Features]	No
E.2.h.ii [Surface Water Features]	No
E.2.h.iii [Surface Water Features]	No
E.2.h.v [Impaired Water Bodies]	No
E.2.i. [Floodway]	No
E.2.j. [100 Year Floodplain]	No
E.2.k. [500 Year Floodplain]	No
E.2.I. [Aquifers]	Yes
E.2.I. [Aquifer Names]	Principal Aquifer, Primary Aquifer
E.2.n. [Natural Communities]	No
E.2.o. [Endangered or Threatened Species]	No

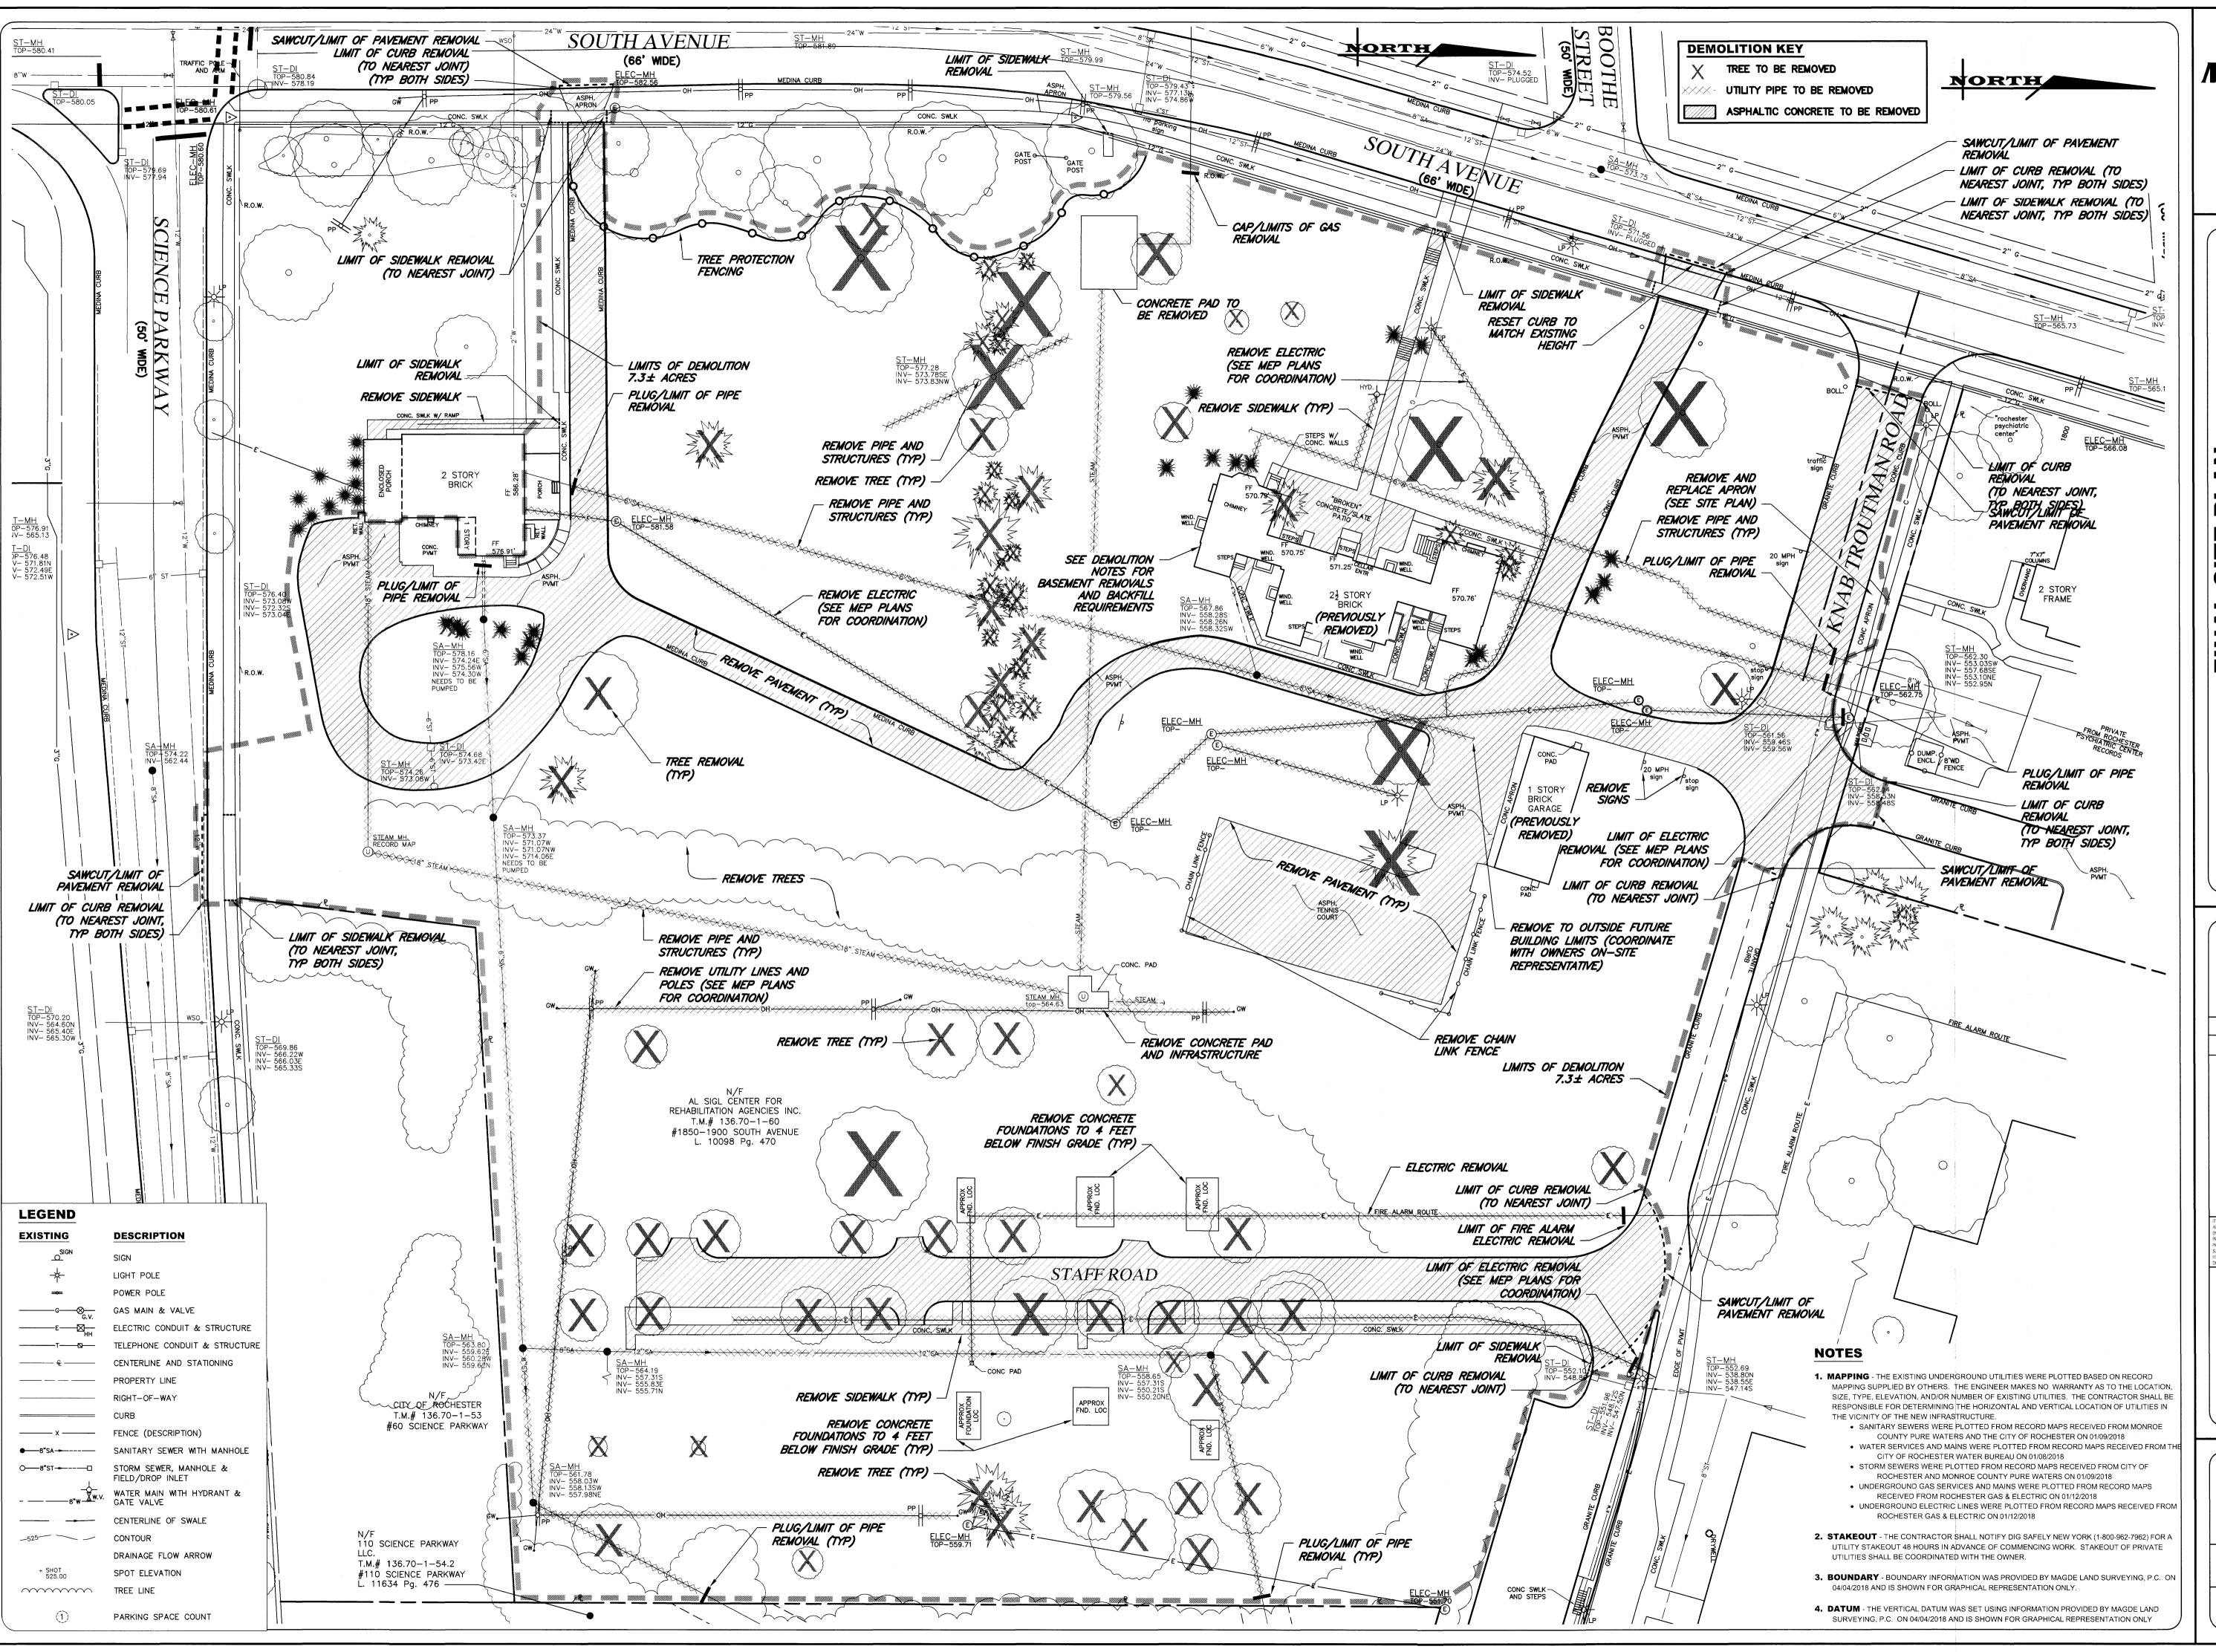

MARATHON ENGINEERING

3 9 CASCADE DRIVE
ROCHESTER, NY 14614
5 8 5 - 4 5 8 - 7 7 7 0

ITHACA LOCATION

840 HANSHAW RD, STE 12
ITHACA, NY 14850
6 0 7 - 2 4 1 - 2 9 1 7

www.marathoneng.com

ER D WELLNESS STATE OF NEW YC

FINAL SITE FLAN

30I BEI

PEDIATRIC Y OF ROCHESTER

JOB NO: 0804-17

SCALE: 1" = 30'

DRAWN: PBG

DESIGNED: RPB

DATE: 08/01/2018

REVISIONS

DATE BY REVISION

TI S A WOLATON OF NEW YORK STATE EDUCATION LAW ARTICLE 145, SECTION 220 FOR ANY PRESON, LINESS ACTING UNDER THE DIRECTION OF A LICENSED PROFESSIONAL ANY STREAM OF A PROFESSIONAL PROMETRY OF LAND SURVEYOR IS ANY WAY, AN ITAM BEARING THE STAL OF A PROFESSIONAL ROCKERS OF LAND SURVEYOR IS ANTERO, THE ATTERO, THE ATTERIOR CHICARD SURVEYOR STALL AFTR TO THE ITEM THER SEAL AND THE NOTATION 'A JURIED' BY OLIOWID BY THER STONATURE AND THE DATE OF SUCH ALTERATION, AND A SPECIFIC DESCRIPTION OF THE ATTERATION.

COPYRIGHT® 2018 MARATHON ENG.

DRAWING TITLE:

EXISTING

CONDITIONS AND


DEMOLITION PLAN

ROBERT BRINGLEY


03 of 15
SHEET No: V1.

DRAWING No:

JOB No:

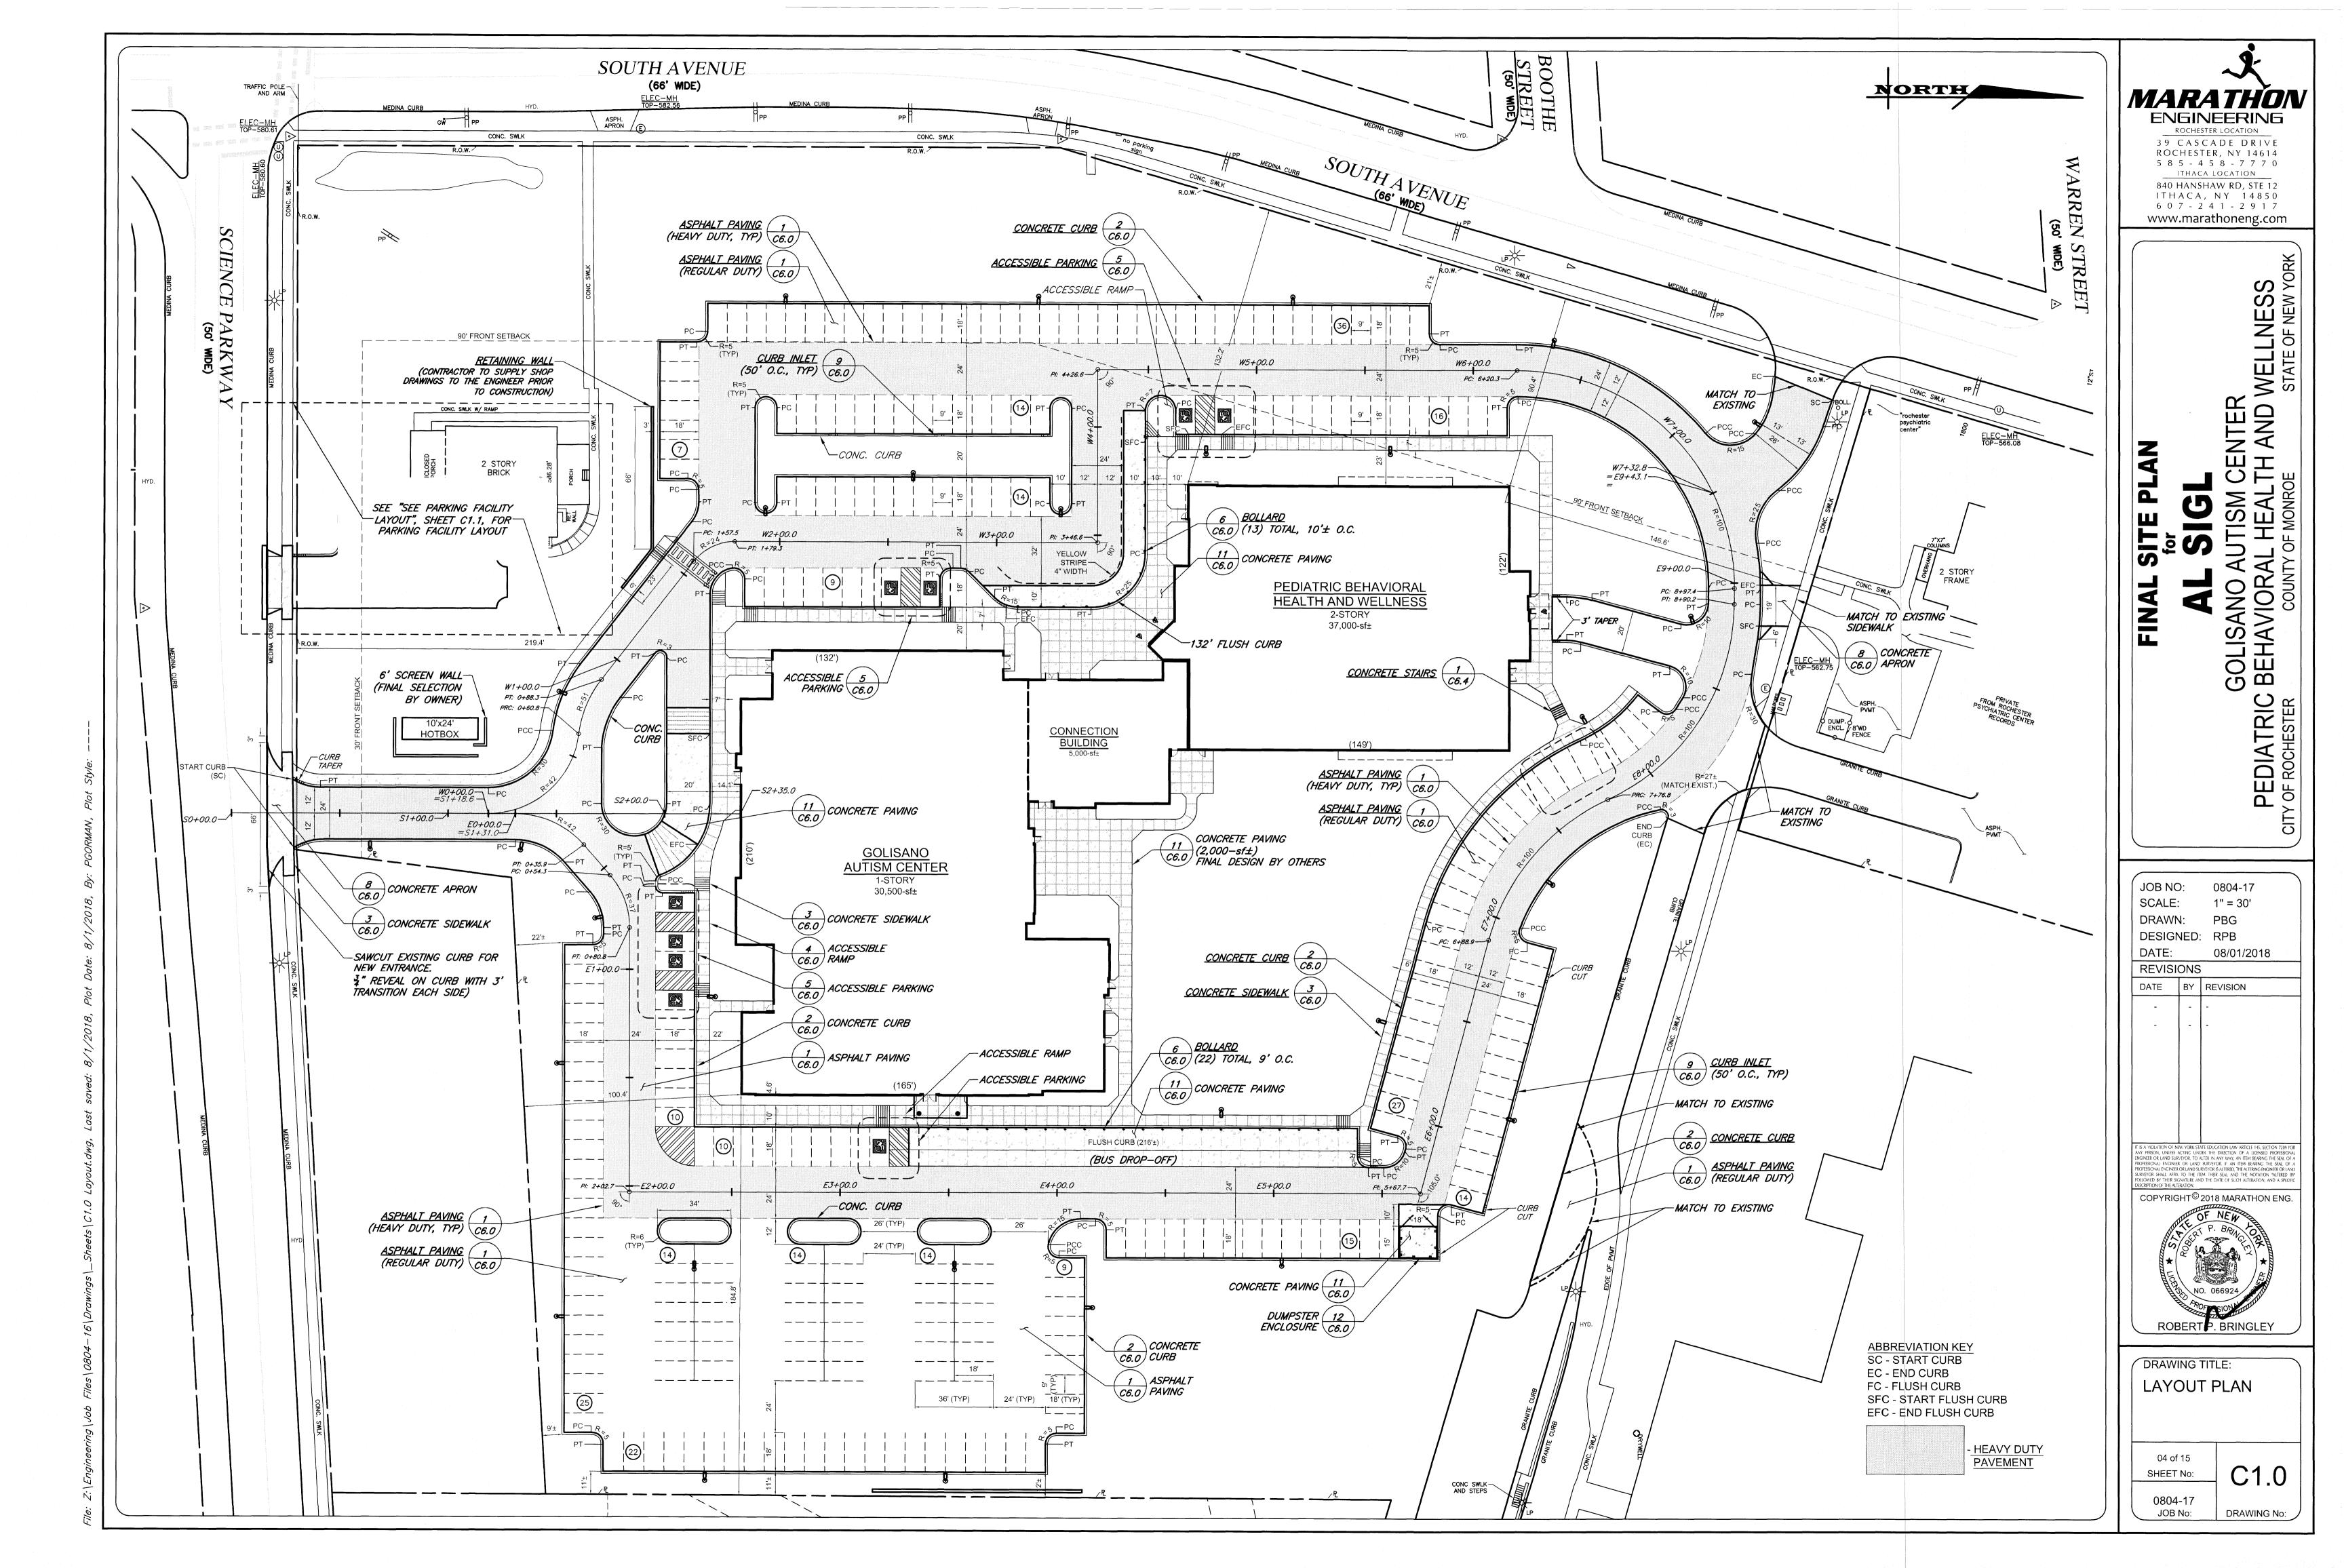



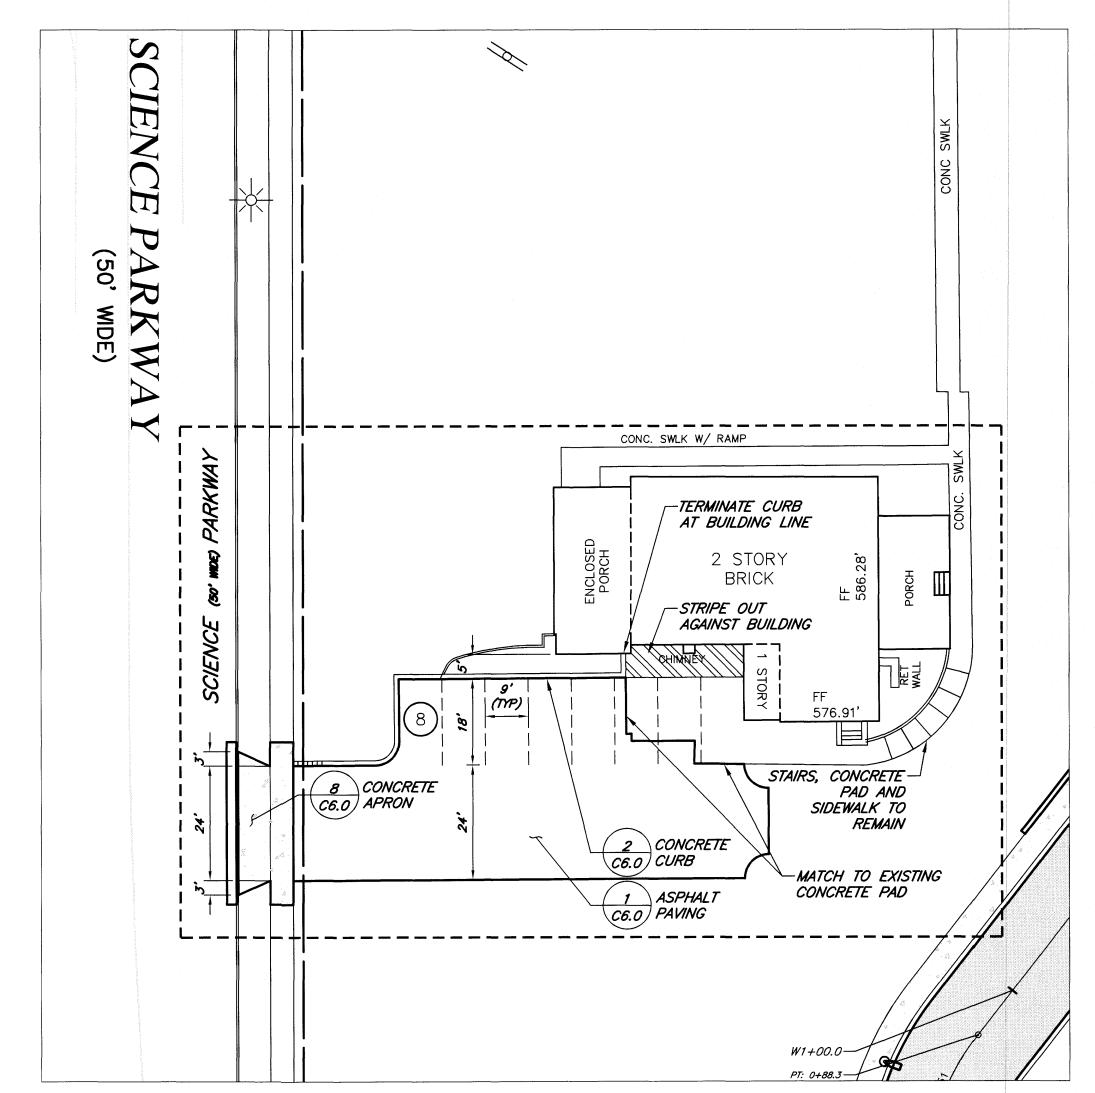

PARKING FACILITY LAYOUT DETAIL SCALE: 1"=20'



3 9 CASCADE DRIVE ROCHESTER, NY 14614 5 8 5 - 4 5 8 - 7 7 7 0 ITHACA LOCATION

840 HANSHAW RD, STE 12 ITHACA, NY 14850 607-241-2917 www.marathoneng.com

WELLNESS STATE OF NEW YORK GOLISA BEHAVI


JOB NO: 0804-17 SCALE: 1" = 20' DRAWN: PBG DESIGNED: RPB 08/01/2018 DATE: REVISIONS DATE BY REVISION COPYRIGHT[©] 2018 MARATHON ENG.

_	
1	DRAWING TITLE:
	LAYOUT PLAN
	LATOUTPLAN

SHEET No: 0804-17

JOB No:

DRAWING No:

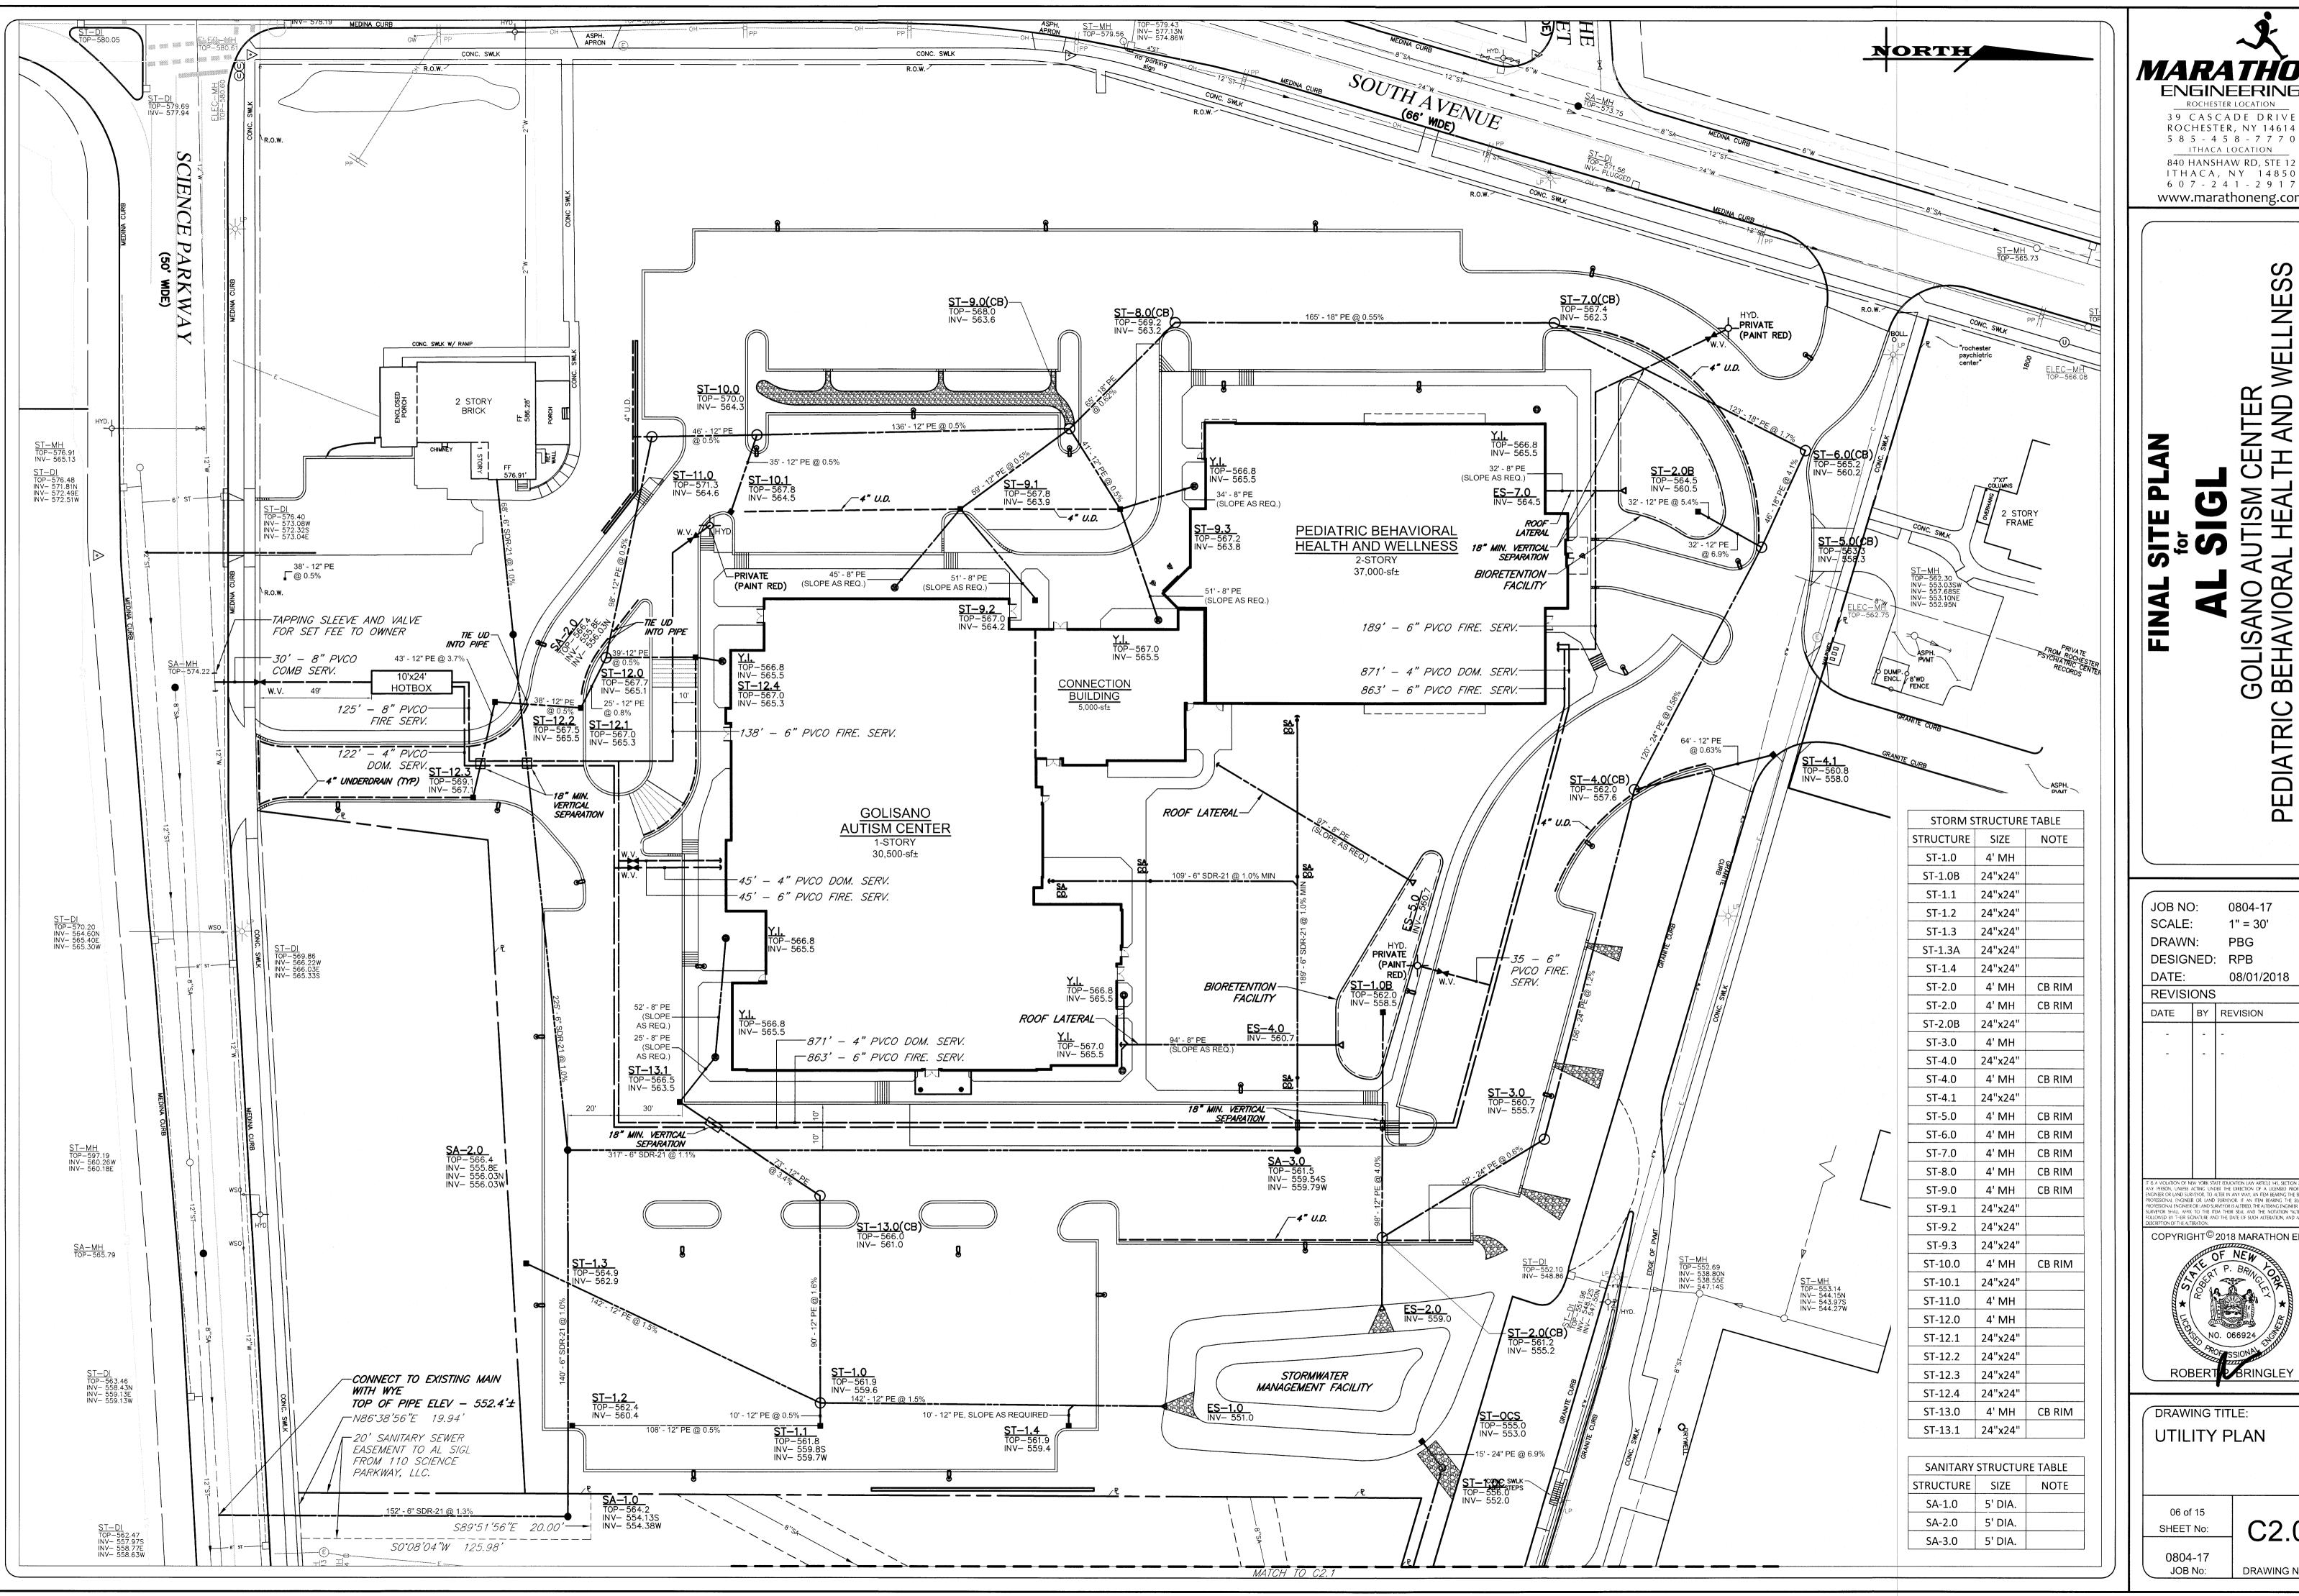

MARATHON **ENGINEERING**

> 39 CASCADE DRIVE ROCHESTER, NY 14614 ITHACA LOCATION

5 8 5 - 4 5 8 - 7 7 7 0 840 HANSHAW RD, STE 12 ITHACA, NY 14850 6 0 7 - 2 4 1 - 2 9 1 7 www.marathoneng.com

WELLNESS STATE OF NEW YORK

の

PEDIATRIC Y OF ROCHESTER


OLISANC

0804-17 1" = 30' DESIGNED: RPB 08/01/2018 DATE BY REVISION IT IS A VIOLATION OF NEW YORK STATE EDUCATION LAW ARTICLE 145, SECTION 7209 FG ANY PERSON, UNIESS ACTING UNDER THE DIRECTION OF A LICENSED PROFESSION RICKINER OR LAND SURVEYOR. TO ALTER IN ANY WAY, AN ITEM BEARING THE SEAL OF PROFESSIONAL ENGINEER OR LAND SURVEYOR. IF AN ITEM BEARING THE SEAL OF PROFESSIONAL ENGINEER OR LAND SURVEYOR IS ALTERED, THE ALTERING ENGINEER OR LAND SURVEYOR SHATLERD, THE ALTERING ENGINEER OR LAND SURVEYOR SHATL AFFIX TO THE ITEM THER SEAL AND THE NOTATION "ALTERED E FOLLOWED BY THEIR SIGNATURE AND THE DATE OF SUCH ALTERATION, AND A SPECI DESCRIPTION OF THE ALTERATION. COPYRIGHT[©] 2018 MARATHON ENG.

DRAWING TITLE: UTILITY PLAN

C2.0

DRAWING No:

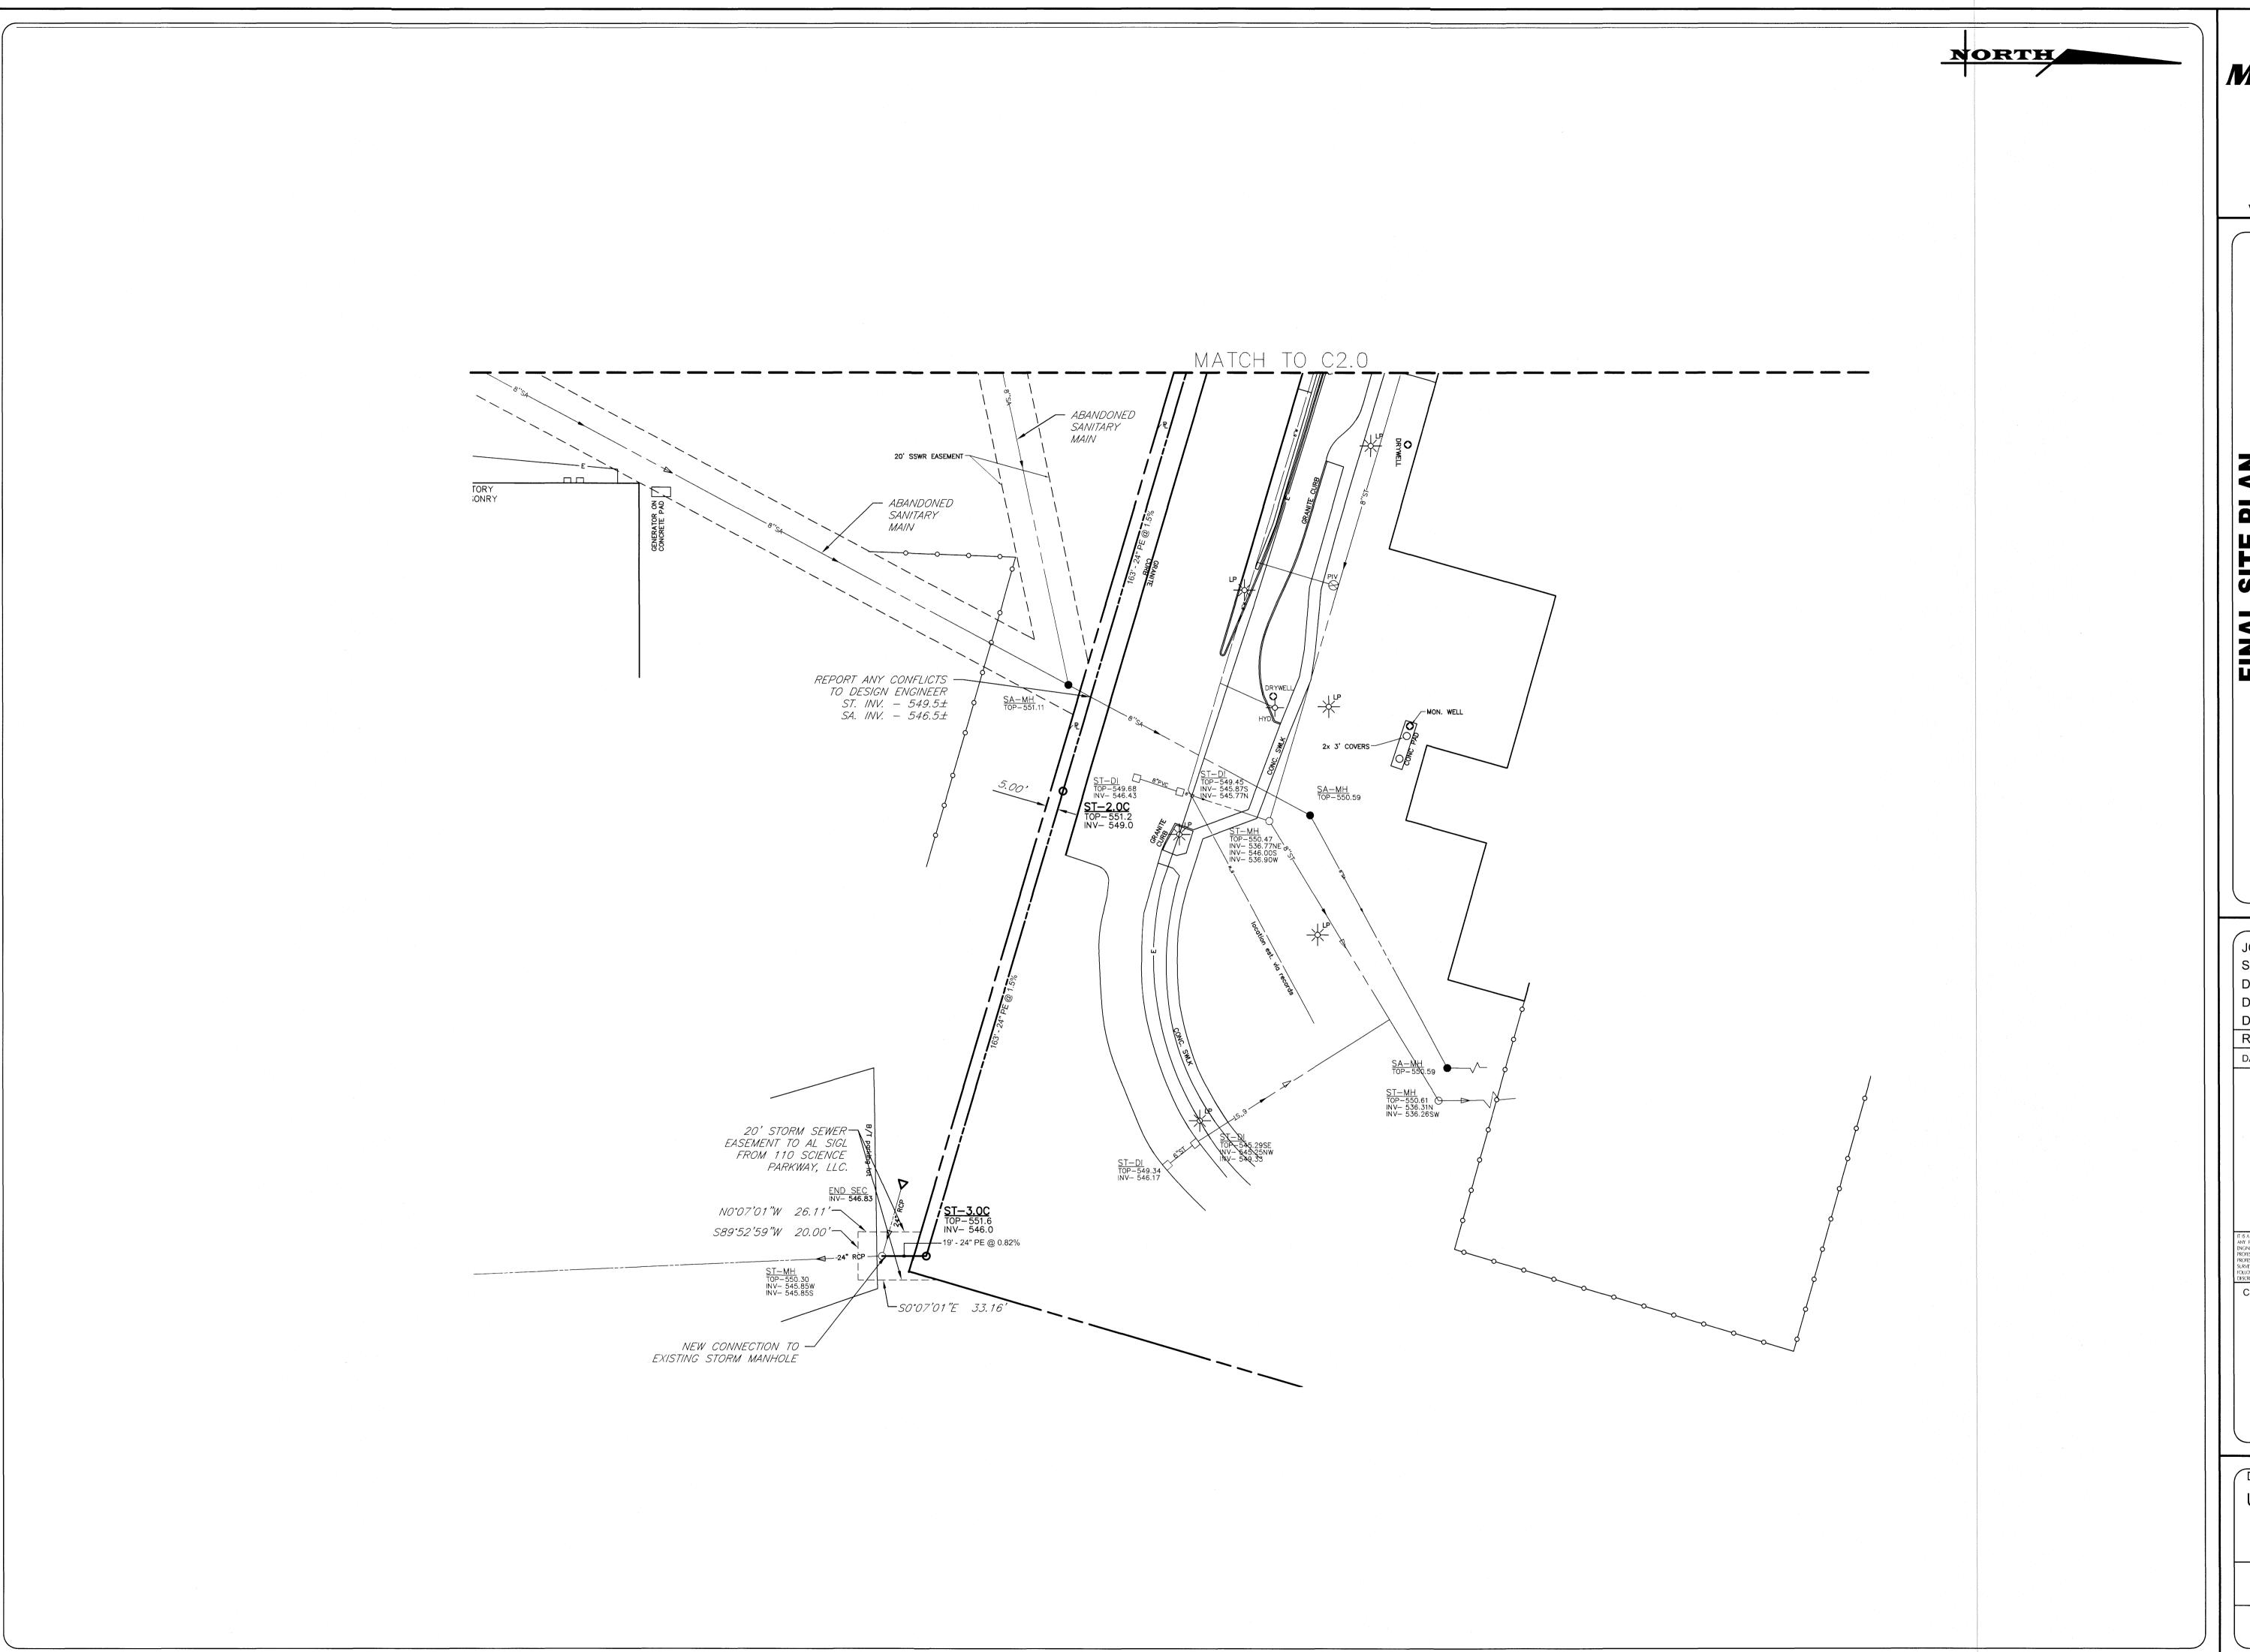

MARATHON ENGINEERING
ROCHESTER LOCATION

ROCHESTER LOCATION

3 9 CASCADE DRIVE
ROCHESTER, NY 14614
5 8 5 - 4 5 8 - 7 7 7 0

ITHACA LOCATION

840 HANSHAW RD, STE 12
ITHACA, NY 14850
6 0 7 - 2 4 1 - 2 9 1 7

www.marathoneng.com

FINAL SITE PLAN

for

AL SIGL

GOLISANO AUTISM CENTER

PEDIATRIC BEHAVIORAL HEALTH AND WELLNESS

Y OF ROCHESTER

COUNTY OF MONROE

STATE OF NEW YORK

SURVEYOR SHALL AFFIX TO THE ITEM THEIR SEAL AND THE NOTATION "ALTERED BY FOLLOWED BY THEIR SIGNATURE AND THE DATE OF SUCH ALTERATION, AND A SPECIFIC DESCRIPTION OF THE ALTERATION.

COPYRIGHT® 2018 MARATHON ENG.


OF NEW P. BRILL OF SUCH ALTERATION AND A SPECIFIC DESCRIPTION OF THE ALTERATION.


NO. 066924

DRAWING TITLE:
UTILITY PLAN

07 of 15 SHEET No:

0804-17
JOB No: DRAWING No:

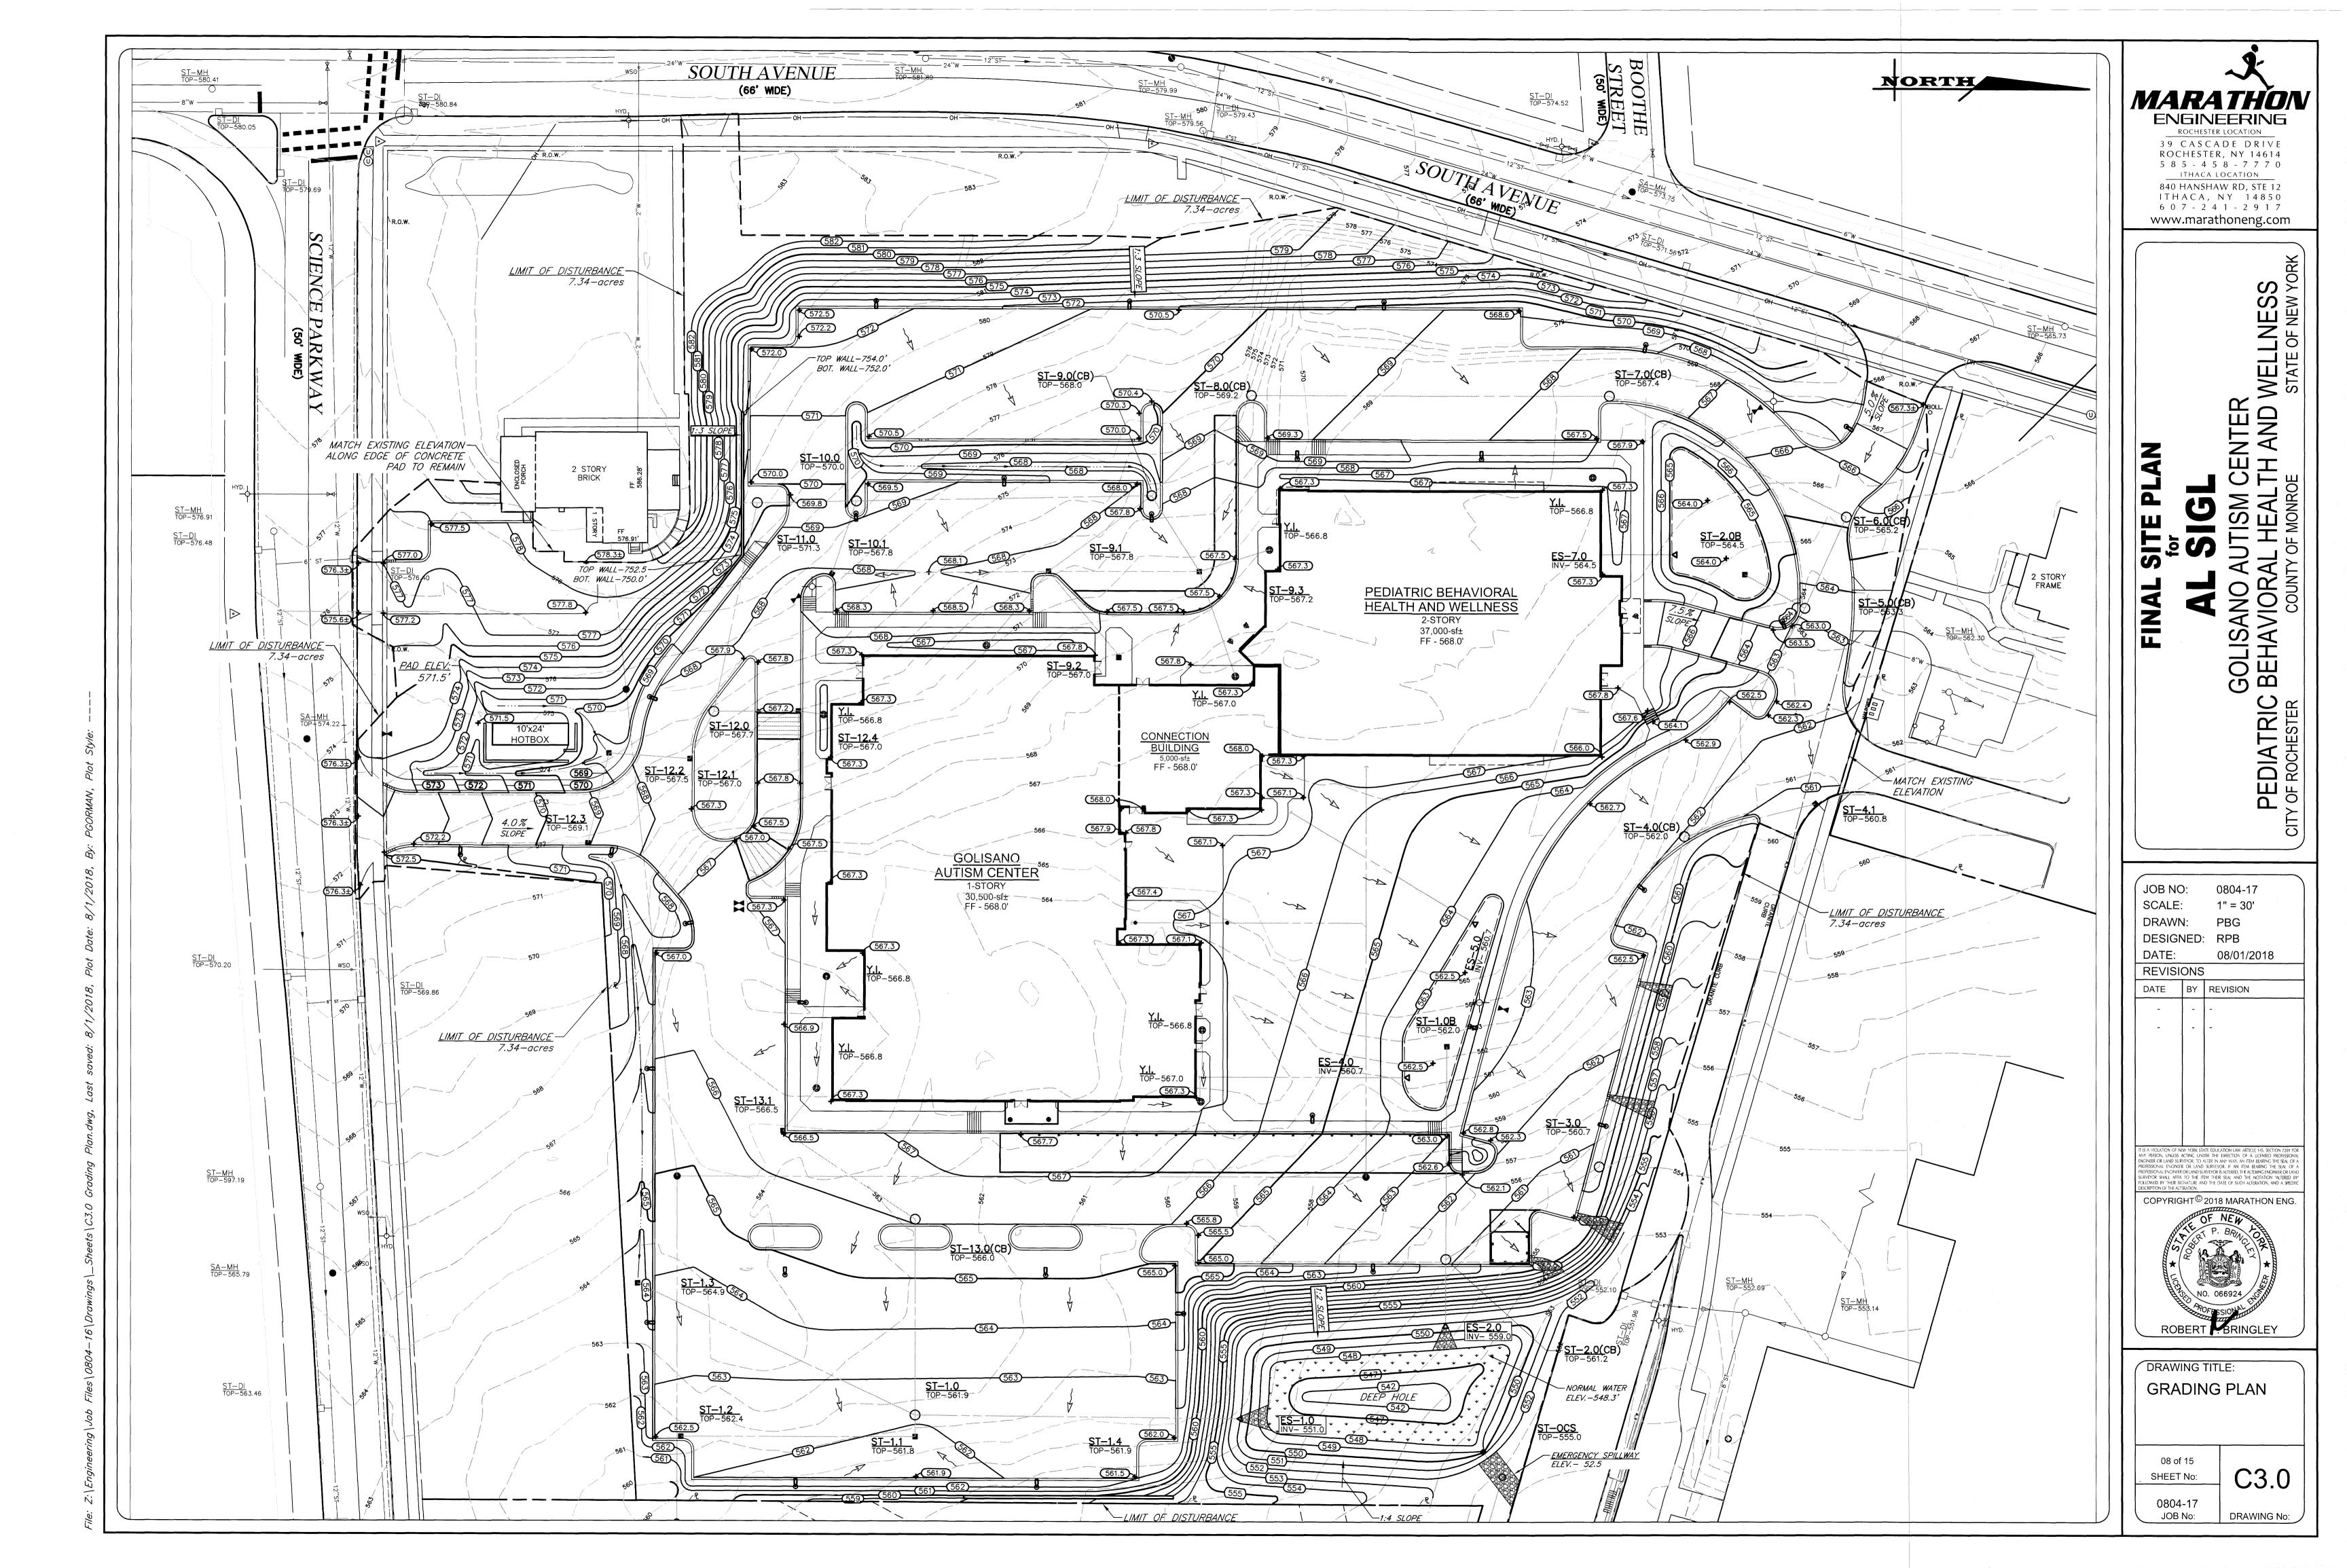

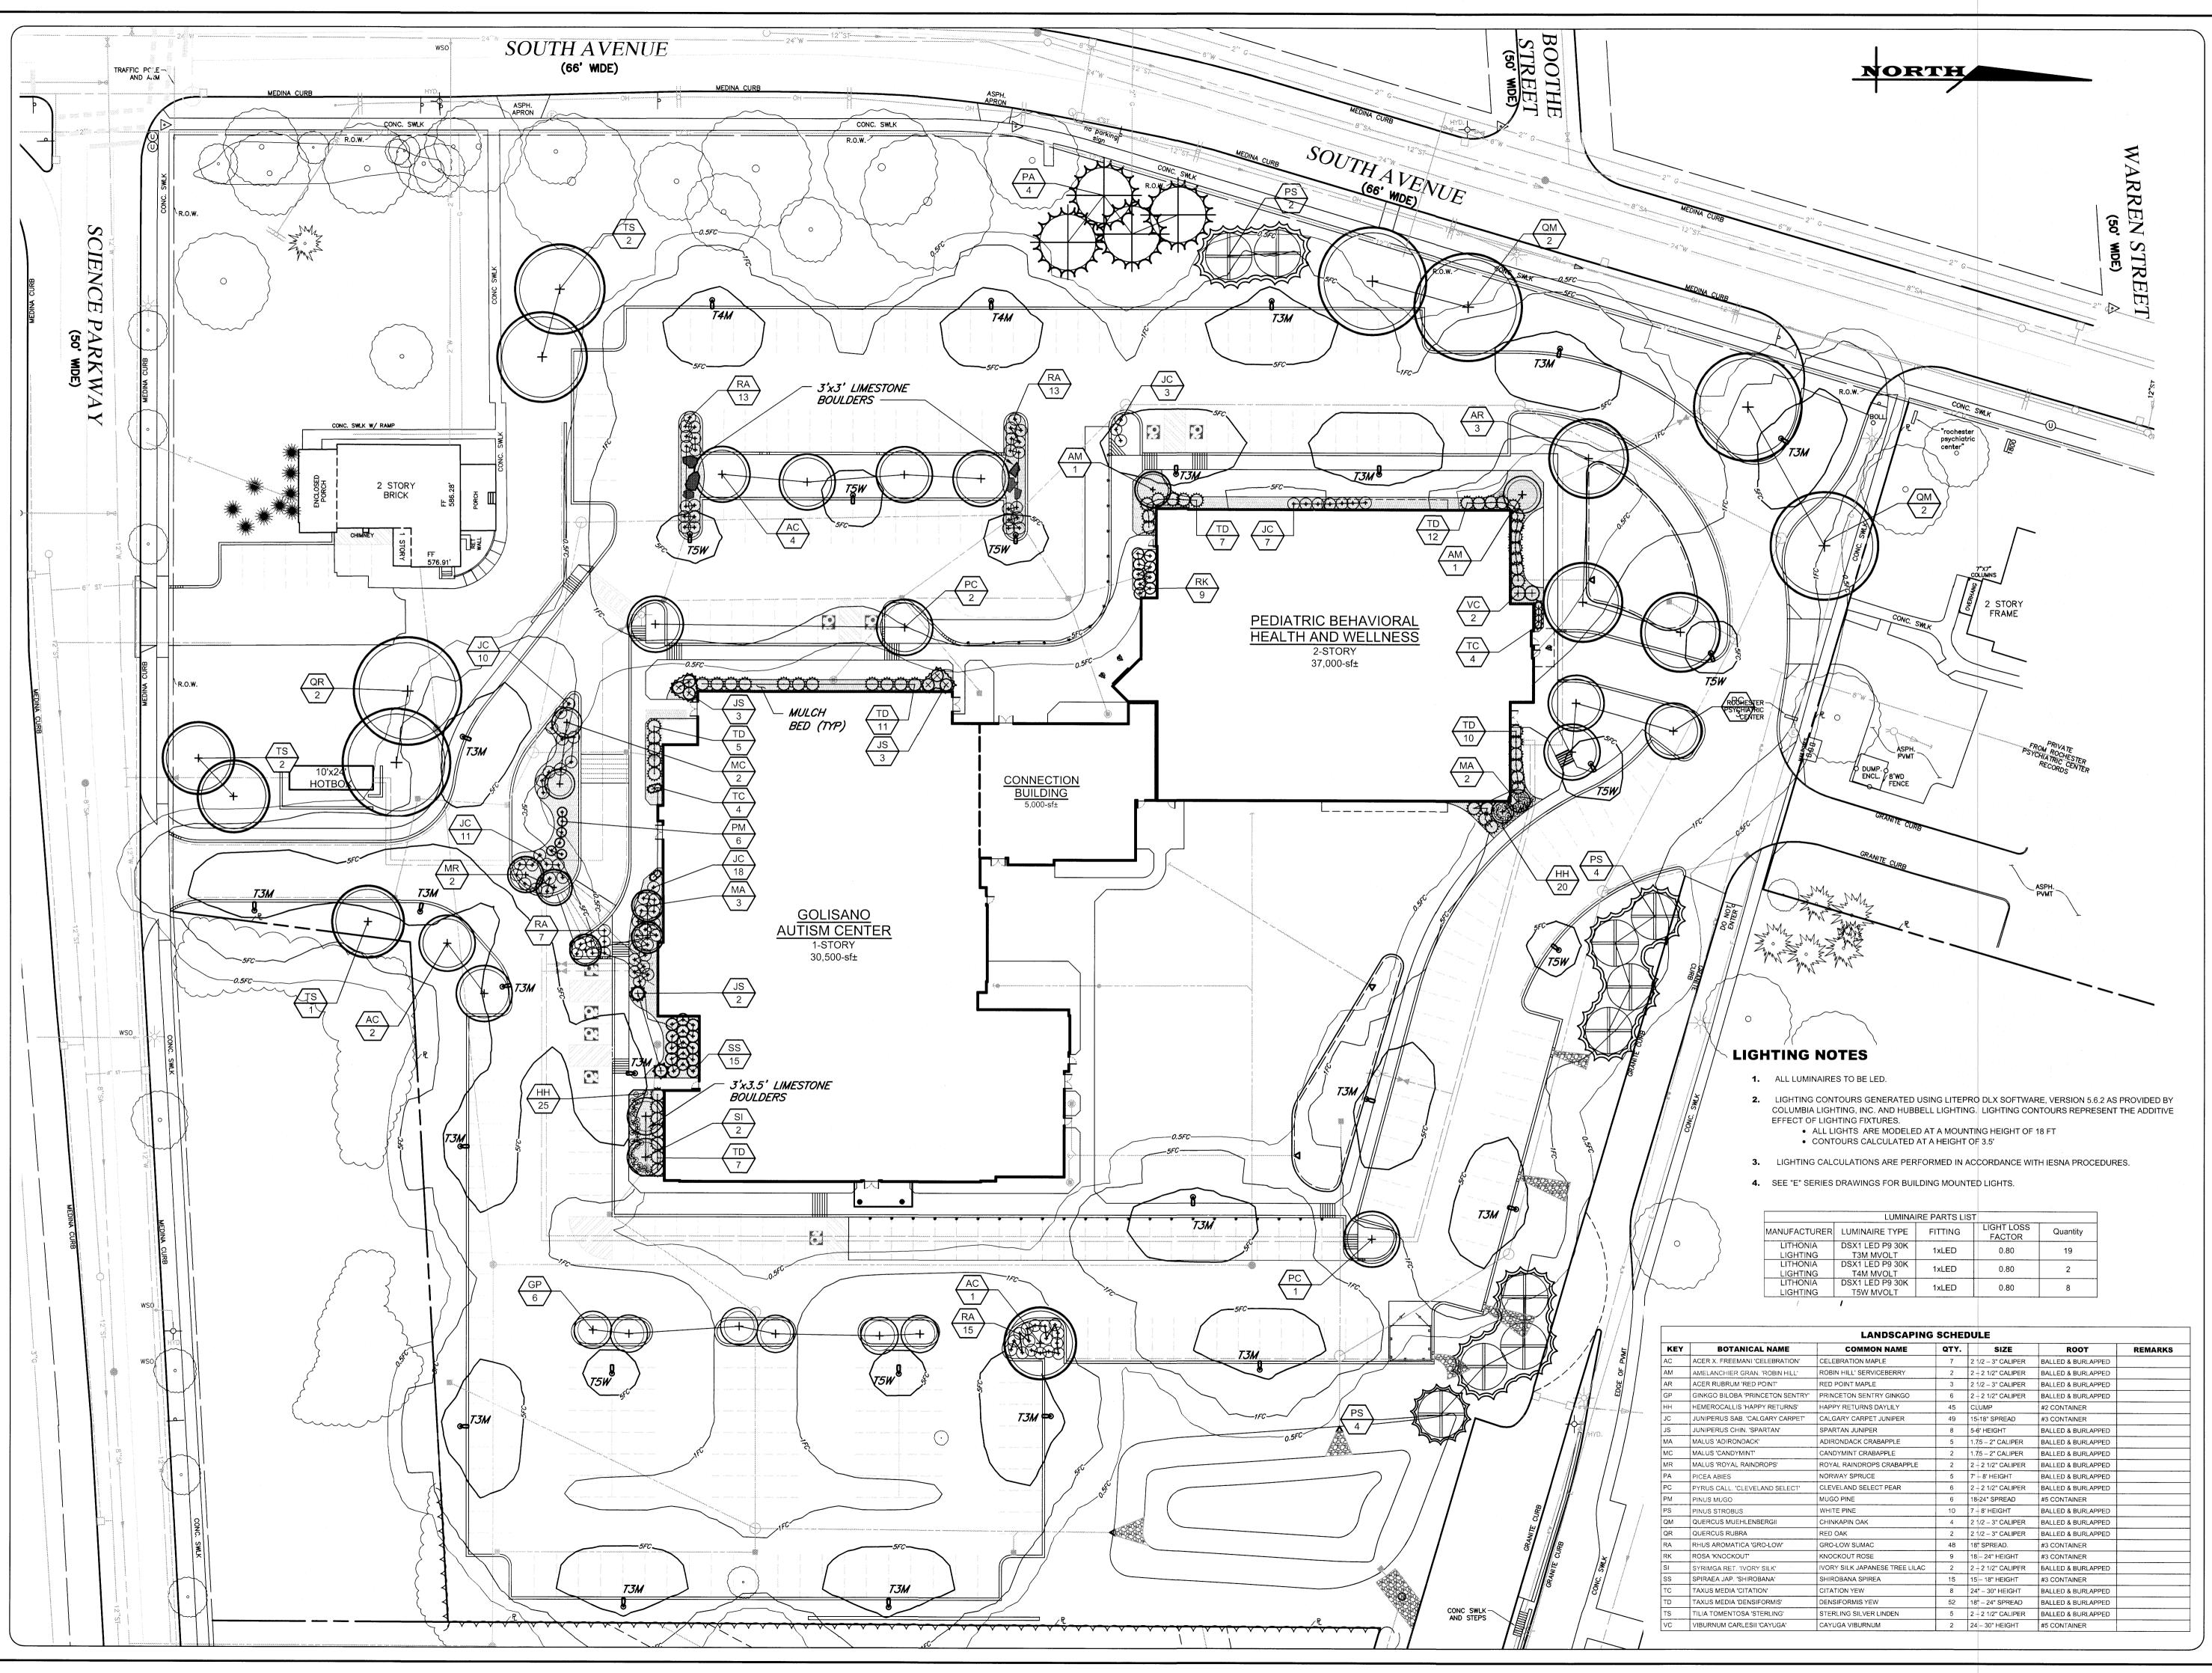



ROCHESTER LOCATION

3 9 CASCADE DRIVE
ROCHESTER, NY 14614
5 8 5 - 4 5 8 - 7 7 7 0

WELLNESS STATE OF NEW YORK

GOLIS, BEHA

ITHACA LOCATION

840 HANSHAW RD, STE 12
ITHACA, NY 14850

6 0 7 - 2 4 1 - 2 9 1 7 www.marathoneng.com

FINAL SITE PLAN for AL SIGL

JOB NO: 0804-17

SCALE: 1" = 30'

DRAWN: PBG

DESIGNED: RPB

DATE: 08/01/2018

REVISIONS

DATE BY REVISION

---- --- --- --
IT IS A MOLATION OF NEW YORK STATE EDUCATION LAW: ARTICLE 145, SECTION 7209 TO ANY PRESON, UNIESS ACTING UNDER THE DIRECTION OF A LICENSED PROFESSIONA BNGINEER OR LAND SURVEYOR. A LITER IN BRAINED THE SEAL OF PROFESSIONAL ENGINEER OR LAND SURVEYOR STATEBED, THE ALTERIOR SEAL AND THE DATE OF SUCH ALTERIOR SHOULD BE COLOUTED BY THER SIGNATURE AND THE DATE OF SUCH ALTERATION, AND A SPECIFIC DESCRIPTION OF THE ALTERATION.

COPYRIGHT© 2018 MARATHON ENG.

DRAWING TITLE:
LIGHTING AND
LANDSCAPING
PLAN

ROBERT P. BRINGLEY

10 of 15
SHEET No:

0804-17
JOB No:

DRAWING No: