
# PROJECT LOCATION PROJECT LOCATION SCALE IN MILES

### GENERAL LOCATION MAP



### **ENLARGED VIEW**

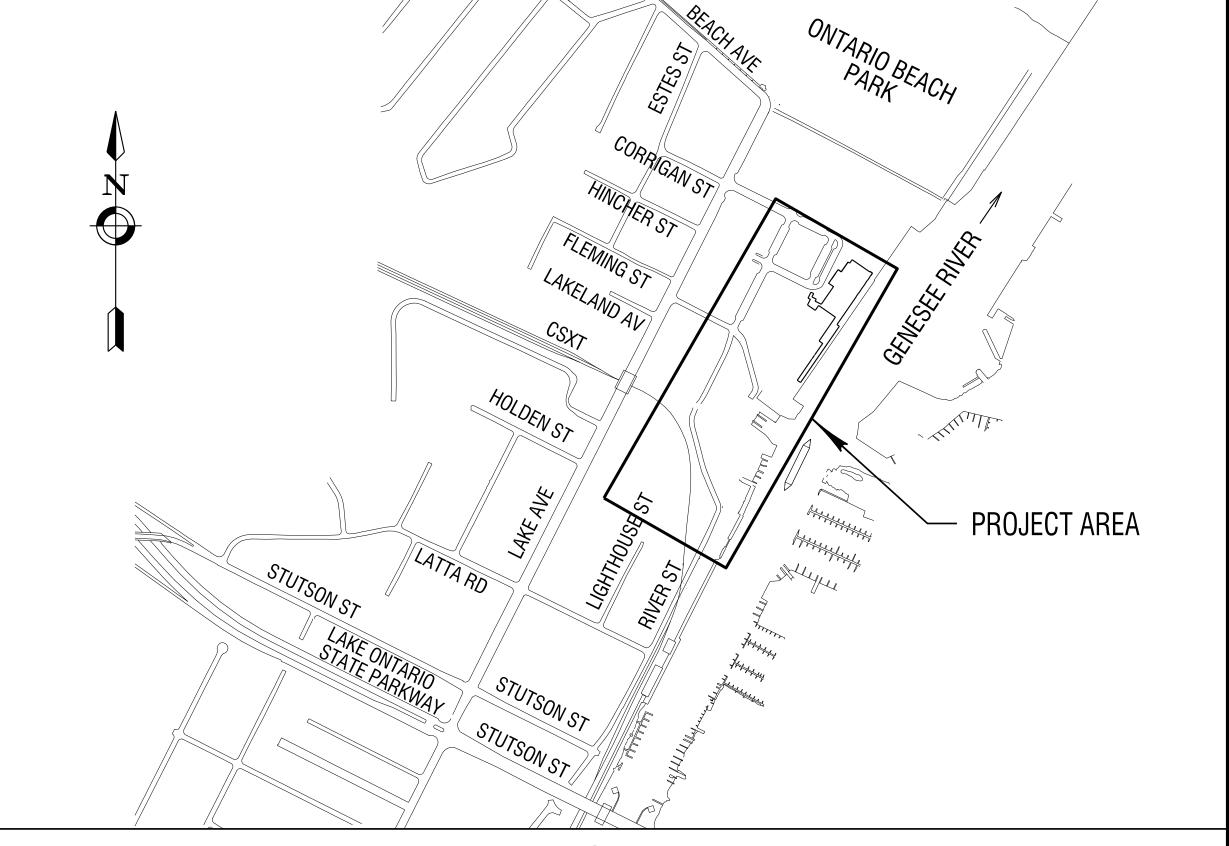












### PREPARED BY

## CITY OF ROCHESTER, NEW YORK

# DEPARTMENT OF ENVIRONMENTAL SERVICES

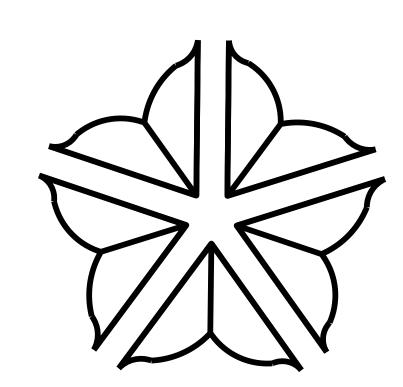

# PORT OF ROCHESTER MARINA DEVELOPMENT PROJECT

CONTRACT 1: UTILITY, ROADWAY, PEDESTRIAN, SITE AND MARINE IMPROVEMENTS
PROJECT NO. 13108





THE FEDERAL AID IN SPORT FISH RESTORATION PROGRAM
IS FUNDING THIS CONSTRUCTION THANKS TO YOUR
PURCHASE OF FISHING EQUIPMENT AND MOTORBOAT FUELS



THIS DOCUMENT WAS PREPARED FOR THE NEW YORK STATE DEPARTMENT OF STATE WITH FUNDS PROVIDED UNDER TITLE 11 OF THE ENVIRONMENTAL PROTECTION FUND ACT



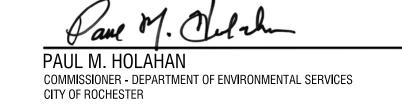

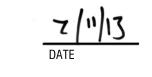










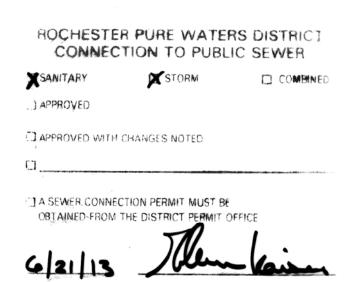

EMPLOYEES OF THE FACILITY, FROM HARM AS A RESULT OF HIS CONSTRUCTION ACTIVITIES. THE HORIZONTAL AND VERTICAL LOCATION OF ALL EXISTING ABOVE GROUND AND BELOW GROUND UTILITIES, STRUCTURES, AND APPURTENANCES SHOWN ON THE PLANS ARE APPROXIMATE AND ARE NOT GUARANTEED. THE CONTRACTOR ALONE SHALL BE RESPONSIBL FOR DETERMINING THE EXACT HORIZONTAL AND VERTICAL LOCATION OF ALL UTILITIES, STRUCTURES, AND APPURTENANCES IN THE PATH OF AND ADJACENT TO THE PROPOSED WORK.

EXISTING CONDITIONS ARE TAKEN FROM FIELD OBSERVATIONS AND PRIOR CONSTRUCTION DOCUMENTS WHEN AVAILABLE AND ARE NOT GUARANTEED. FIELD VERIFY ALL EXISTING CONDITIONS PRIOR TO BID. NO ALLOWANCE WILL BE MADE FOR ADDITIONAL COSTS DUE TO CONTRACTORS FAILURE TO VERIFY EXISTING CONDITIONS AND DIMENSIONS. PRIOR TO THE START OF MEANINGFUL CONSTRUCTION, DIG TEST PITS TO DETERMINE

PRECISE LOCATIONS AND DEPTH OF ANY UNDERGROUND LITHLITY IN QUESTION AND IMPACTED BY THE WORK. IMMEDIATELY REPORT RESULTS TO THE ARCHITECT/ENGINEER OF ANY SIGNIFICANT DISCREPANCIES BETWEEN THE PLANS AND ACTUAL LOCATIONS OF SAID STRUCTURES. TEST PITS AND ASSOCIATED REPORTING SHALL BE INCLUDED IN THE PRICE

WHEN EXISTING CONSTRUCTION WHICH IS TO REMAIN IS DAMAGED DURING THE COURSE OF CONSTRUCTION AS A RESULT OF CONTRACTORS WORK, IT SHALL BE REPAIRED AND/OR REPLACED WITH SIMILAR OR LIKE MATERIALS AS MUCH AS POSSIBLE, SUBJECT TO OWNERS

6. PROPERTY LINES AND RIGHTS-OF-WAY LINES AS SHOWN ARE APPROXIMATE AND ARE INTENDED FOR GENERAL INFORMATION. NO WARRANTY IS EXPRESSED OR IMPLIED TO THEIR ACCURACY

EASEMENTS, IF ANY, WILL FIELD LOCATE AND MARK THE LOCATION OF THEIR FACILITIES.

IT IS THE CONTRACTOR'S RESPONSIBILITY TO NOTIFY THE VARIOUS UTILITY OWNERS IN

EQUIPMENT, INCLUDING SPECIAL CUTTING DEVICES, NECESSARY TO PERFORM THE WORK

7. THE OWNERS OF THE VARIOUS UTILITIES WITHIN THE RIGHTS-OF-WAY OR ADJACENT

AMPLE TIME FOR THEM TO LOCATE THEIR FACILITIES. SITE DRAINAGE, INCLUDING THE PROJECT SITE AND ADJACENT PRIVATE AND PUBLIC ROADWAYS, DRIVES, PARKING AREAS OR PROPERTIES SHALL BE MAINTAINED THROUGHOUT

THE CONSTRUCTION PERIOD. 9. THE CONTRACTOR IS RESPONSIBLE FOR SUPPLYING ALL MATERIALS, TOOLS AND

CONTAINED IN THIS CONTRACT. 10. CONTRACTOR STAGING AREAS AND CONSTRUCTION ENTRANCE LOCATIONS SHALL BE COORDINATED WITH THE OWNERS DESIGNATED REPRESENTATIVE PRIOR TO START OF CONSTRUCTION. PROVIDE A STABILIZED CONSTRUCTION ENTRANCE, IF REQUIRED AND

RESTORE ALL DISTURBED AREAS. PROTECT ALL EXISTING SITE AMENITIES NOT DESIGNATED FOR REMOVAL.

ANY SITE AMENITY. UTILITY. STREET APPURTENANCE. OR OTHER ITEM WHICH BECOMES DAMAGED AS A RESULT OF THE CONTRACTOR'S OPERATIONS SHALL BE REPAIRED OR REPLACED IN-KIND BY THE CONTRACTOR AS DETERMINED BY THE OWNER'S DESIGNATED REPRESENTATIVE OR ARCHITECT/ENGINEER AND AT NO ADDITIONAL COST TO THE OWNER.

PRIOR TO THE START OF CONSTRUCTION, NOTIFY DIG SAFELY NEW YORK (U.F.P.O.) TWO (2) FULL WORK DAYS (NOT COUNTING THE DAY OF THE CALL, WEEKENDS, OR HOLIDAYS) AT 1-800-962-7962 OR 81 TO REQUEST UTILITY STAKEOUT OF ALL PUBLIC

PROVIDE PROTECTION FOR ALL OF THE EXISTING TREES TO REMAIN WITHIN THE PROJECT LIMITS FOR THE DURATION OF THE PROJECT TO MINIMIZE ANY DAMAGE TO THE TREES AS A RESULT OF CONSTRUCTION ACTIVITIES IN ACCORDANCE WITH ITEM 615.04020004. PLACE PROTECTION BEFORE ANY WORK IS STARTED AND IS TO BE IN THE FORM OF FLUORESCENT ORANGE SNOW FENCING OR WOOD RAIL AND POSTS PLACED AROUND EACH TREE PER ITEM 615.04020004 AND THE DETAIL DRAWINGS.

ALL TREES, SHRUBS AND PLANTS DESIGNATED TO REMAIN AND DISTURBED BY CONSTRUCTION OPERATIONS. SHALL BE REPLACED IN-KIND AS DIRECTED BY THE OWNER'S DESIGNATED REPRESENTATIVE OR ARCHITECT/ENGINEER AT NO ADDITIONAL COST TO THE

NOTIFY PROPERTY OWNERS PRIOR TO ANY REMOVAL OR RECONSTRUCTION WORK EITHER ON THEIR PROPERTY OR ALONG THE RIGHT-OF-WAY IN FRONT OF THEIR PROPERTY. DURING THE COURSE OF CONSTRUCTION MINOR GRADING DRIVEWAY LEAD WALK STEP AND/OR RETAINING WALL WORK MAY BE REQUIRED OUTSIDE THE RIGHT-OF-WAY, WHERE WORK OUTSIDE THE STREET RIGHT-OF-WAY IS REQUIRED, OBTAIN A "GRADING RELEASE" FROM PROPERTY OWNERS PRIOR TO PERFORMING ANY WORK.

COORDINATE ALL NECESSARY RELOCATIONS OF POSTAL BOXES WITHIN THE PROJECT LIMITS WITH THE UNTIED STATES POSTAL SERVICE (1-800-275-8777), FURNISH AND INSTALL A CONCRETE PEDESTAL OR OTHER FOOTING FOR THE IMPACTED POSTAL BOXES IF REQUIRED BY THE USPS. THE COST OF ALL WORK ASSOCIATED WITH THE RELOCATION OF POSTAL BOXES IS TO BE INCLUDED IN THE VARIOUS ITEMS IN THE CONTRACT.

MAINTAIN SAFE AND CONTINUOUS ACCESS TO ALL ACTIVE FIRE HYDRANTS THROUGHOUT THE PERIOD OF CONSTRUCTION.

 MAINTAIN SAFE AND CONTINUOUS THROUGH TRAFFIC AND INGRESS AND EGRESS FOR ADJACENT PRIVATE DRIVEWAYS, SERVICE ROADS, PARKING AREAS AND PUBLIC STREETS THROUGHOUT THE PERIOD OF CONSTRUCTION. IF. BY AGREEMENT WITH THE OWNER'S REPRESENTATIVE AND JURISDICTIONAL AGENCY, A STREET, ROAD, DRIVE OR PARKING AREA WILL REQUIRE TEMPORARY CLOSING DURING CONSTRUCTION, THE CONTRACTOR SHALL NOTIFY IN WRITING THE LOCAL AND STATE POLICE, AND LOCAL FIRE DEPARTMENT REGARDING THE

20. MAINTAIN SAFE VEHICULAR AND PEDESTRIAN ACCESS TO THE EXISTING BUILDINGS FOR THE DURATION OF THE CONTRACT.

MAINTAIN THE CONSTRUCTION SITE IN A SAFE AND ORDERLY FASHION THROUGHOUT THE PERIOD OF CONSTRUCTION WITH MINIMAL DISRUPTION OF THROUGH TRAFFIC AND INGRESS AND EGRESS FOR PRIVATE DRIVEWAYS, PUBLIC STREETS AND ENTRANCES TO BUSINESSES ALONG THE ROUTE OF CONSTRUCTION.

22. CONFORM TO THE CONDITIONS OF ALL EASEMENTS. RESTORATION OF INDIVIDUAL EASEMENT AREAS IS SUBJECT TO APPROVAL OF THE PROPERTY OWNERS.

PROTECT AND PRESERVE ALL RIGHTS-OF-WAY MONUMENTS AND PROPERTY CORNER MARKERS TO REMAIN. ALL RIGHTS-OF-WAY MONUMENTS AND PROPERTY CORNER MARKERS DISTURBED BY THE CONTRACTOR SHALL BE REPLACED BY A NYS LICENSED SURVEYOR AT THE CONTRACTOR'S EXPENSE.

PROVIDE ADEQUATE TEMPORARY SANITARY FACILITIES DURING CONSTRUCTION. THE CONTRACTOR SHALL COORDINATE WITH THE PROJECT MANAGER FOR USE OF TEMPORARY ON-SITE UTILITIES SUCH AS WATER AND ELECTRICITY. THE CONTRACTOR SHALL BE RESPONSIBLE TO REIMBURSE THE OWNER FOR USE OF SUCH UTILITIES.

RESEARCH, SECURE AND PAY FOR ALL PERMITS, MUNICIPAL APPROVALS, FEES AND SIMILAR ITEMS AS NEEDED TO COMPLETE THE WORK.

26. IF THE FORESTRY DIVISION DETERMINES THAT THE ROOTS OF AN EXISTING TREE TO REMAIN WILL BE IMPACTED BY THE INSTALLATION OF GRANITE CURB, INSTALL BRIDGE CURB A.O.B.E. PAYMENT WILL BE MADE UNDER ITEM 609.0303.

### **ROADWAY NOTES:**

HOT MIX ASPHALT PAVEMENT COURSES CONSTRUCTED ON THIS PROJECT WILL BE DEVELOPED USING THE SUPERPAVE MIX DESIGN PROCEDURES AND SPECIFICATIONS, TO AVOID DAMAGE TO THE EXISTING UTILITIES, VIBRATORY COMPACTION WILL NOT BE PERMITTED HOWEVER, THE CONTRACTOR WILL BE RESPONSIBLE FOR COMPACTING THE PAVEMENT WITHIN THE SPECIFIED DENSITY RANGE PER THE SUPERPAVE SPECIFICATIONS INCLUDED IN THE CONTRACT DOCUMENTS.

PRIOR TO BEGINNING PAVING WORK, A PRE-PAVING MEETING WILL BE REQUIRED. NOTIFY THE CITY PROJECT REPRESENTATIVE AT LEAST THREE (3) WEEKS IN ADVANCE OF THE START OF SUPERPAVE PAVING OPERATIONS TO SCHEDULE A MEETING WITH THE CITY, THE CONTRACTOR, THE ASPHALT SUPPLIER AND THE DESIGN ENGINEER.

INCLUDE THE COST TO FURNISH AND APPLY TACK COAT ON PAVEMENT EDGES, CURBING, MANHOLES AND STRUCTURES IN ITEM 407.0101.

TYPICAL WORK LIMITS ARE SHOWN ON THE TYPICAL SECTIONS. ACTUAL WORK LIMITS SHALL BE DETERMINED IN THE FIELD AT THE TIME OF CONSTRUCTION. THE ENGINEER IN CHARGE SHALL DEFINE SPECIFIC LIMITS WHERE QUESTIONS ARISE.

FULL DEPTH SAWCUTTING IS REQUIRED FOR ALL TRENCH AND EXCAVATION WORK IN PAVEMENT REHARILITATION AREAS AS WELL AS SIDEWALK EDGES ARLITTING SIDEWALK TO BE RETAINED, SIDE STREET WORK LIMITS, PROJECT WORK LIMITS AND ALONG CURBS TO BE REPLACED IN PAVEMENT REHABILITATION AREAS. THE COST FOR ALL SAWCUTTING WILL BE INCLUDED IN ITEM 520.50140008

RESTORE ALL DISTURBED AREAS ADJACENT TO CURBING. DRIVEWAY AND SIDEWALK INSTALLATION BY THE TREATMENT SHOWN ON THE PLANS BY TOPSOIL AND SEEDING OR AS ORDERED BY THE ENGINEER IN CHARGE.

7. FOLLOW THE PROVISIONS OF THE NYSDOT "STANDARD SPECIFICATIONS". DATED MAY 1. 2008 AND ALL REVISIONS". FOLLOW THE PROVISIONS OF THE "CITY OF ROCHESTER HEREIN. FOLLOW THE PROVISIONS OF THE CITY OF ROCHESTER DEPARTMENT OF ENVIRONMENTAL SERVICES STANDARD DETAILS EXCEPT AS MODIFIED BY THE DETAILS SHOWN ON THE CONSTRUCTION CONTRACT DOCUMENT DRAWINGS.

CONSTRUCT DRIVEWAY APRONS AND SIDEWALK RAMPS OF THE TYPE AND AT THE LOCATIONS SHOWN ON THE PLANS OR AS ORDERED BY THE ENGINEER IN CHARGE. TRANSITION CURB FOR DRIVEWAYS AND TRANSITION CURB FOR SIDEWALK RAMPS SHALL BE AS SHOWN ON THE DETAILS OR AS ORDERED BY THE ENGINEER IN CHARGE.

NEW GRANITE CURB SHALL TRANSITION WITHIN THE LAST THREE (3) FEET TO MEET EXISTING TOP OF CURB AT EACH SIDE STREET WORK LIMIT AS SHOWN IN THE DETAILS.

COORDINATE ALL GENERAL CONSTRUCTION ACTIVITIES AND ANY ROAD CLOSINGS WITH THE CITY OF ROCHESTER FIRE DEPARTMENT, THE CITY OF ROCHESTER POLICE DEPARTMENT, ROCHESTER CITY SCHOOL DISTRICT AND THE MONROE COUNTY DEPARTMENT OF TRANSPORTATION (MCDOT).

MAINTAIN ALL SIGNS AS ORDERED BY THE ENGINEER IN CHARGE AND MCDOT. THE WORK SHALL CONFORM TO THE REQUIREMENTS OF NYSDOT SECTION 619. RETURN SIGNS DIRECTED BY THE ENGINEER IN CHARGE OR MCDOT TO BE REMOVED TO THE MONROE COUNTY

DEPARTMENT OF TRANSPORTATION, FLEET CENTER ON PAUL ROAD, ROCHESTER, NY.

### **UTILITY NOTES:**

1. ESTABLISH AND MAINTAIN COMMUNICATION WITH AND COORDINATE WORK WITH THE FOLLOWING UTILITY COMPANIES AND BUSINESSES FOR THE DURATION OF THE PROJECT:

UTILITY COMPANY CONTACT PERSON PHONE NUMBER RG&E ELECTRIC PFTF DAWFS 724-8170 RG&E GAS 724-8331 MEGHANN KENDALL TWC CABLE HEATH LESSLIE 756-1320 FRONTIER TELEPHONE MARK TODD 746-5829 CITY STREET LIGHTING JOE BORRELLI 428-7979 CITY WATER BUREAU MIKE BUSHART 428-7567 MONROE COUNTY TRAFFIC SIGNALS ERNIE FATTORE 753-7772 MONROE COUNTY PURE WATERS GLENN KAISER 753-7609

THE ADJUSTMENT, RELOCATION OR REPLACEMENT OF EXISTING TELEPHONE, ELECTRIC. CABLE TV OR GAS FACILITIES SHALL BE PERFORMED BY THE PRIVATE UTILITY COMPANIES. THE UTILITY COMPANIES MUST BE INFORMED BY THE CONTRACTOR BEFORE CONSTRUCTION IS STARTED TO DETERMINE THE EXACT LOCATION OF ANY UTILITIES THAT ARE TO BE ADJUSTED. RELOCATED OR REPLACED. THE CONTRACTOR SHALL COORDINATE ANY WORK TO BE PERFORMED BY THE UTILITY COMPANIES THAT IS TO BE DONE DURING THE CONSTRUCTION

TAKE ALL PRECAUTIONS NECESSARY TO PRESERVE THE INTEGRITY OF EXISTING UTILITIES TO REMAIN AND PROVIDE UNINTERRUPTED SERVICE TO ALL USERS OF THE EXISTING UTILITIES. EXISTING UTILITIES (TO REMAIN) ENCOUNTERED IN TRENCH OR PAVEMENT EXCAVATIONS SHALL BE SUPPORTED AS ORDERED BY THE ENGINEER IN CHARGE OR AS DIRECTED BY THE UTILITY COMPANY, THE COST FOR SUPPORTING UTILITIES SHALL BE INCLUDED IN THE PRICE BID FOR EXCAVATION.

EXISTING LITH ITIES SHOWN ON THE PLANS HAVE BEEN PLOTTED FROM FIELD SURVEYS AND RECORD MAPS AND ARE NOT CERTIFIED AS TO THE ACCURACY OF THEIR LOCATION OR COMPLETENESS. THE CONTRACTOR SHALL BE RESPONSIBLE FOR DETERMINING THE EXACT LOCATION AND DEPTHS OF ALL LITILITIES AND STRUCTURES IN THE PATH OF, CLOSELY PARALLEL TO, OR UNDER THE PROPOSED CONSTRUCTION. THE CONTRACTOR SHALL BE RESPONSIBLE FOR ANY DELAYS OR DAMAGES OCCURRING AS A RESULT OF INCORRECTLY LOCATED UTILITIES. NO EXTENSIONS OF CONTRACT TIME AND NO MONETARY DAMAGE CLAMS SHALL BE ALLOWED AS A RESULT OF REVISED DESIGN LOCATIONS OR TIME ALLOWED TO DO SAME WHICH WOULD RESULT FROM EXISTING LITH ITIES BEING FOUND IN DIFFERENT LOCATIONS OTHER THAN SHOWN ON THESE DRAWINGS. IT IS THE CONTRACTOR'S RESPONSIBILITY TO NOTIFY THE VARIOUS UTILITY OWNERS IN AMPLE TIME FOR THEM TO LOCATE AND MARK THEIR FACILITIES. THE CONTRACTOR SHALL ALSO NOTIFY UNDERGROUND FACILITIES PROTECTIVE ORGANIZATION AT LEAST 48 HOURS IN ADVANCE OF COMMENCING ANY WORK (1-800-962-7962).

### LIGHTING NOTES:

EXISTING TO BE REMOVED SHALL BE REMOVED BY THE CONTRACTOR AS INDICATED IN THE PLANS AND TABLES.

THE CONTRACTOR WILL BE REQUIRED TO COORDINATE ALL WORK PERTAINING TO

STREET LIGHTING WITH THE CITY OF ROCHESTER STREET LIGHTING DIVISION. 3. THE COST OF ALL CONDUIT WITHIN LIGHT POLE BASES SHALL BE INCLUDED IN THE UNIT PRICE BID FOR POLE BASE FOUNDATIONS.

THE CONTRACTOR SHALL TAKE APPROPRIATE MEASURES TO SAFEGUARD AND

### MARINA GENERAL NOTES

CONTRACTOR IS RESPONSIBLE FOR ENSURING THAT ALL MARINA DOCK DESIGN AND CONSTRUCTION ADHERE TO PROJECT SPECIFICATIONS, APPLICABLE LOCAL, STATE, AND FEDERAL CODES AND IS ADEQUATELY DESIGNED FOR THE PROPOSED UTILITY SERVICES.

THE CONTRACTOR SHALL SUPPLY COMPLETE STRUCTURAL CALCULATIONS TO ACCOMPANY THE SHOP DRAWINGSAND SUBMITTALS. THESE STRUCTURAL CALCULATIONS SHALL INCLUDE SYSTEM ANCHORAGE. STRUCTURAL DESIGN. AND FLOTATION. ALL STRUCTURAL CALCULATIONS SHALL BEAR THE SIGNATURE AND SEAL OF A STATE OF NEW YORK LICENSED PROFESSIONAL ENGINEER. THE ENGINEER PROVIDING THE STRUCTURAL CERTIFICATION SHALL HAVE A MINIMUM OF 10 YEARS EXPERIENCE AS A PROFESSIONAL ENGINEER SPECIALIZING IN MARINA-WATERFRONT ENGINEERING.

THE PROPOSED DOCKS AND OTHER NECESSARY MATERIALS WILL BE CONFINED TO A STAGING AREA CONFIRMED PRIOR TO CONSTRUCTION. THE CONTRACTOR TRAILER WILL ALSO BE LOCATED IN THIS AREA.

CONTRACTOR SHALL BE RESPONSIBLE FOR OBTAINING TEMPORARY UTILITY SERVICES, AS NEEDED FOR CONSTRUCTION.

FLOATING DOCKAGE SYSTEM SHALL BE PAID AT THE GENERAL CONTRACTOR'S BID PRICE PER LUMP SUM TO FURNISH AND INSTALL A COMPLETE SYSTEM, INCLUDING, BUT NOT LIMITED TO, CLEATS, FENDER AND SUPPORT PILES, WALKWAYS, PIERS, GANGWAYS, UTILITY PEDESTALS (INCLUDING ELECTRICAL WIRING AND POTABLE WATER PIPING WITHIN THE PEDESTALS). ANCHORAGE WITH ALL ASSOCIATED MARINE HARDWARE, AND THE FOLLOWING DOCK UTILITY SYSTEMS:

WATER DISTRIBUTION SYSTEM INCLUDES ALL PIPE, VALVES, FITTINGS, AND SERVICE CONNECTIONS TO THE UTILITY PEDESTALS (INCLUDING CONNECTION AND PLUMBING WITHIN THE PEDESTAL). THIS ITEM SHALL ALSO INCLUDE ALL DISINFECTION AND TESTING NECESSARY TO PLACE THE POTABLE WATER DISTRIBUTION SYSTEM IN SERVICE.

SANITARY PUMPOUT SYSTEM INCLUDES ALL PUMPS. ALL PIPES FROM THE PUMPS TO THE POINT OF CONNECTION WITH SANITARY MAINS VALVES FITTINGS AND HOSE REFLIS THIS ITEM SHALL ALSO INCLUDE ALL TESTING NECESSARY TO PLACE THE SANITARY PUMPOUT

ELECTRICAL SYSTEM INCLUDES ALL CABLE, CONDUITS (AS NEEDED FOR ELECTRICAL

FACILITIES). DOCK AND LAND-BASED DISTRIBUTION FOUIPMENT, UTILITY PEDESTALS

(INCLUDING ELECTRICAL WIRING WITHIN THE PEDESTAL), AND ELECTRICAL SERVICE TO PEDESTALS, LIGHTS, PUMPOUT SYSTEM APPURTENANCÉS, AND ICE SUPPRESSION EQUIPMENT. PILES SHALL BE CIRCULAR STEEL, HELICAL, OR SPUD PILES, SIZED AND SPACED BY THE MANUFACTURER'S DESIGN ENGINEER TO RESIST THE HORIZONTAL AND VERTICAL

LOADING CONDITIONS DEFINED IN THE SPECIFICATIONS. 10. CONTRACTOR MUST ENSURE THAT THE MAIN FLOATING WALK WAY IS ABLE TO SUPPORT THE APPROPRIATELY SIZED GANGWAY AND MEET ALL PROJECT PERFORMANCE SPECIFICATIONS FOR LEVEL AND FREE BOARD.

11. ALL PROPOSED CLEATS SHALL BE S-SHAPED CLEATS PER THE DETAILS AND SPECIFICATIONS. SEE SHEET ME5.02 FOR CLEAT LOCATIONS AND SPACING.

### TEMPORARY SOIL EROSION AND WATER POLLUTION CONTROL NOTES

1. SEE DRAWING G4.01 EROSION AND SEDIMENT CONTROL PLAN

### FORESTRY DIVISION NOTES:

THE ROOT SYSTEM ON THE WALK SIDE OF THE TREE SHALL NOT BE CUT. IF ROOTS LARGER THAN 2" ARE ENCOUNTERED NO SUBBASE WILL BE USED AND SIDEWALK IS TO BE POURED OVER ROOTS.

EXPOSED TREE ROOTS SHALL BE COVERED WITH MULCH/BURLAP AND WATERED FROM A PERIOD IMMEDIATELY FOLLOWING CURB AND GUTTER REMOVAL UNTIL THE AREA IS BACKFILLED FOLLOWING CONSTRUCTION.

ROOT FOUNDATIONS MUST REMAIN ADEQUATE TO WITHSTAND HEAVY WINDSTORMS, TREE ROOTS 2" AND UNDER ARE TO BE CUT CLEANLY, CITY FORESTRY IS TO BE NOTIFIED (585-428-7581) TO SET UP INSPECTION IF ROOTS LARGER THAN 2" ARE IN CONFLICT WITH CONSTRUCTION.

REMOVE ALL TREE GRATES AND DO NOT REPLACE.

VIOLATIONS TO SPECIFICATION S617 FOR TREE PROTECTION. (STANDARDS FOR WORK IN THE PUBLIC RIGHT-OF-WAY), AND CITY CHARTER AND CODE 89.9 FOR TREES WILL BE SUBJECT TO A FINE OF \$150.00 PER VIOLATION PER DAY. NO WARNINGS OF VIOLATIONS ARE REQUIRED. STANDARDS ARE EXPECTED TO BE MET.

THE CONTRACTOR SHALL CONTACT THE MONROE COUNTY DEPARTMENT OF TRANSPORTATION TRAFFIC SIGNAL GROUP (753-7749) A MINIMUM OF TWO WEEKS PRIOR TO THE REMOVAL OF

ALL WORK PERFORMED AND MATERIALS SUPPLIED SHALL BE IN ACCORDANCE WITH THE

LATEST CITY OF ROCHESTER AND NYSDOT STANDARD SPECIFICATIONS AND DETAILS INCLUDING ALL REVISIONS, AND THE MANUAL OF UNIFORM TRAFFIC CONTROL DEVICES. THE CONTRACTOR SHALL IDENTIFY EACH AND EVERY CABLE ENTERING THE CONTROLLER CABINETS AND PULLBOXES BY FUNCTION AND DESTINATION ON MCDOT APPROVED TAGS. THE

TAGS SHALL BE ATTACHED TO THE CABLES WITH STAINLESS STEEL WIRE, PLASTIC OR ANY CHARGES RELATED TO POWER HOOK-UP AND/OR ANY PULLBOX/MANHOLE ENTRIES WILL BE PAID FOR BY THE CONTRACTOR. LOCATIONS SHALL BE APPROVED BY MCDOT PRIOR TO

THE CONTRACTOR SHALL COORDINATE WITH THE MONROE COUNTY DEPARTMENT OF TRANSPORTATION ANY MODIFICATIONS TO THE PLANS AND TO ESTABLISH THE PHASING AND TIMING OF THE SIGNALS.

ALL NEW LOOPS SHALL BE CENTERED IN THE TRAFFIC LANE AND THE PROPOSED

TRAFFIC SIGNAL GROUP (753-7749) TO COORDINATE PICK-UP.

LOCATIONS SHALL BE APPROVED BY MCDOT PRIOR TO INSTALLATION. ALL REMOVED TRAFFIC SIGNAL EQUIPMENT SHALL BECOME THE PROPERTY OF THE MONROE COUTY DEPARTMENT OF TRANSPORTATION. THE CONTRACTOR IS TO CONTACT THE MCDOT

### **WATER MAIN NOTES:**

ALL NEW WATER MAINS IN THIS PROJECT SHALL BE INSTALLED AT A MINIMUM COVER DEPTH OF 4.5 FEET FOR DOMESTIC MAINS UNLESS OTHERWISE NOTED OR ORDERED BY THE

NEW HYDRANTS ON WATER MAINS INSTALLED AT THE SPECIFIED 4'6" COVER DEPTH AND GREATER SHALL BE MANUFACTURED FOR 6'0"BURY.

FOR ALL ABANDONED WATER MAIN AND HYDRANT BRANCHES. THE CONTRACTOR SHALL PLUG ALL CUT AND OPEN PIPE ENDS WITH 12 INCHES OF CONCRETE, THE COST OF WHICH IS TO BE INCLUDED IN THE APPROPRIATE UNIT PRICE BID FOR ITEMS UNDER SECTIONS S907. S908 OR S917. THE CONTRACTOR SHALL LEAVE ABANDONED MAIN LINE VALVES IN THE SHUT POSITION, INCLUDING VALVES ON HYDRANT BRANCHES AND SERVICES.

ALL GATE VALVES IN THIS PROJECT SHALL BE OF THE RESILILENT SEAT TYPE, BID ITEM S903. S904 AND S905. ALL GATE VALVES SHALL REQUIRE MECHANCIAL RESTRAINT. STAND-ALONE GATE VALVES SHALL REQUIRE RESTRAINT AT BOTH ENDS. COST OF MECHANICAL RESTRAINTS SHALL LBE INCLUDED IN THE PIPE ITEM.

APPROPRIATE MEASURES SHALL BE TAKEN TO PREVENT DIRT, DEBRIS AND SURFACE

WATER FROM CONTAMINATING THE WATER MAIN. THE EXCAVATION WATER LEVEL SHALL NEVER BE LESS THAN 12 INCHES BELOW THE PIPE INVERT. AND WHENEVER AN OPEN PIPE END IS UNATTENDED, IT SHALL BE COVERED IN A WATER TIGHT MANNER. THE WATER MAIN SHALL BE PRESSURE/LEAKAGE TESTED IN ACCORDANCE WITH THE MINIMUM REQUIREMENTS OF THE AWWA STANDARD C600, C605 (LATEST VERSIONS

WHERE APPLICABLE) OR IN ACCORDANCE WITH MORE STRINGENT REQUIREMENTS

IMPOSED BY THE SUPPLIER OF WATER. SEE CITY OF ROCHESTER STANDARD SPECIFICATION

SECTION S900 GENERAL WATER PROVISIONS, TESTING. WHERE WATER MAINS CROSS UNDER SEWERS, MINIMUM VERTICAL SEPARATION BETWEEN THEM SHALL BE 18 INCHES AS MEASURED FROM THE OUTSIDE OF THE PIPES AT THE POINT OF CROSSING. WHERE THE WATER UTILITY CROSSES OVER SEWERS THE VERTICAL SEPARATION SHALL NOT BE LESS THAN 6 INCHES. ONE FULL STANDARD LAYING LENGTH OF WATER MAIN SHALL BE CENTERED UNDER OR OVER THE SEWER SO THAT BOTH END JOINTS WILL BE AS FAR FROM THE SEWER AS POSSIBLE. IN ADDITION, WHEN THE WATER MAIN PASSES UNDER A SEWER, ADEQUATE STRUCTURAL SUPPORT (COMPACTED SELECT FILL) SHALL BE PROVIDED FOR THE SEWER TO PREVENT EXCESSIVE DEFLECTION OF JOINTS AND SETTLING OF THE SEWER ON THE WATER MAIN.

MINIMUM HORIZONTAL SEPARATION BETWEEN PARALLEL WATER MAINS AND SEWER PIPES (INCLUDING MANHOLES AND VAULTS OR STRUCTURES, SEPTIC TANKS, SEEPAGE PITS OR LEACH LINES) SHALL BE 10 FEET MEASURED FROM THE OUTSIDE OF THE PIPES, MANHOLES

WHEN INSTALLING FIRE HYDRANTS, SHOULD GROUND WATER BE ENCOUNTERED WITHIN SEVEN (7) FEET OF FINISHED GRADE, FIRE HYDRANT WEEP HOLES (DRAINS) SHALL BE

10. THRUST BLOCKS SHALL CONSIST OF CENTRAL, TRANSIT OR TRUCK MIXED CONCRETE. WHERE APPROVED BY THE PROJECT MANAGER. THE CONTRACTOR WILL BE PERMITTED TO USE ON-SITE MIXED CONCRETE. THE CONCRETE SHALL BE THOROUGHLY MIXED PRIOR TO PLACEMENT. USE OF DRY, UNMIXED CEMENT FOR THRUST BLOCKS IS PROHIBITED.

11. ALL EXISITING WATER VALVE BOXES THAT ARE ABANDONED, DUE TO THE REPLACEMENT OF THE OLD WATER MAIN. ARE TO BE REMOVED THE COST OF WHICH IS TO BE INCLUDED IN THE APPROPRIATE UNIT PRICE BID FOR ITEMS 203.02, R206.04, S909.06 OR S917.05. THE CONTRACTOR SHALL LEAVE ABANDONED VALVES IN THE SHUT POSITION.

12. A CATHODIC PROTECTION TEST STATION SHALL BE INSTALLED (SECTION S968), WHERE SHOWN ON THE DRAWINGS AND AS DIRECTED BY THE PROJECT MANGER.

DURING THE WINTER SEASON (NOVEMBER 1 APRIL 14), THE CITY SNOW OFFICE (585-428-6687) SHALL BE NOTIFIED OF THE LOCATION. PLACEMENT AND REMOVAL OF ANY STEEL PLATES USED IN PUBLIC RIGHT-OF-WAY. A WARNING SIGN STATING "RAISE PLOW ROAD PLATE 20 FT AHEAD"SHALL BE INSTALLED AS SHOWN IN DETAIL DRAWING NO. S999-2. ALL STEEL PLATES MUST BE RECESSED. STACKED AND RAMPED.

14. DURING THE WINTER SEASON, ARTERIAL AND COLLECTOR STREETS SHALL HAVE A WEARING SURFACE CONSISITING OF FOUR (4) INCHES MINIMUM THICKNESS OF HIGH EARLY STRENGTH CONCRETE. LOCAL ACCESS STREETS SHALL HAVE A WEARING SURFACE CONSISTING OF THREE 3 INCHES OF HIGH EARLY STRENGTH CONCRETE.

15. ON ALL STREETS WHERE THE CENTERLINE OF THE WATER MAIN TRENCH IS 6 FEET OR LESS FROM THE EXISTING CURB LINE, OR AS ORDERED BY THE PROJECT MANAGER. THE CONTRACTOR SHALL MILL THE EXISTING 1 ½ INCH TOP COURSE MATERIAL BETWEEN THE CURB AND THE EDGE OF THE TRENCH PRIOR TO PLACEMENT OF THE NEW TOP COURSE MATERIAL. THE NEW TOP COURSE MATERIAL SHALL BE PLACED IN ONE OPERATION, OVERING BOTH THE WATER MAIN TRENCH AND THE AREA BETWEEN THE EDGE OF THE TRENCH AND THE CURB. THE COST OF MILLING AND DISPOSAL OF THE EXISTING ASPHALT MATERIAL SHALL BE INCLUDED IN THE UNIT PRICE BID FOR ITEM \$204.01 MILLING

16. THE CONTRACTOR SHALL NOTIFY THE FIRE DEPARTMENT IN WRITING 48 HOURS PRIOR TO TAKING ANY HYDRANT OUT OF SERVICE. ALL HYDRANTS TAKEN OUT OF SERVICE SHALL BE RED TAGGED. BAGGED. OR OTHERWISE MARKED IN A MANNER ACCEPTABLE TO THE OWNER. THE FIRE DEPARTMENT SHALL ALSO BE NOTIFIED WHEN A HYDRANT IS PLACED IN

17. THE PROJECT OWNER AND AFFECTED PROPERTY OWNERS SHALL BE NOTIFIED IN WRITING 24 HOURS PRIOR TO ANY DISRUPTION IN SERVICES.

18. PERMISSION IS REQUIRED TO USE WATER FROM FIRE HYDRANTS. WATER USE REQUIRES THE USE OF A BACKFLOW PREVENTER. THE BACKFLOW PREVENTER SHALL BE SUPPLIED BY

19. FOR WATER MAINS THAT PASS OVER SEWERS: IF, IN THE OPINION OF THE ENGINEER, 18 INCHES OF VERTICAL SEPARATION IS NOT FEASIBLE AND THE VERTICAL SEPARATION IS BETWEEN 6 INCHES AND 18 INCHES, ALL WATER MAIN JOINTS WITHIN 20 FEET OF THE SEWER SHALL BE ENCASED IN CONTROL DENSITY FILL.

20. NITRILE GASKETS TO BE FACTORY INSTALLED ON PVC WATER MAIN.

### WATER DISINFECTION NOTES:

1. THE WATER MAIN (AND/OR TEMPORARY BYPASS, WHEN PROVIDED) SHALL BE DISINFECTED EQUAL TO AWWA STANDARD FOR DISINFECTING WATER MAINS DESIGNATION C651 (LATEST REVISION) USING THE CONTINUOUS FEED METHOD. FOLLOWING DISINFECTION, THE WATER MAIN (OR BYPASS PIPE) SHALL BE FLUSHED UNTIL THE CHLORINE CONCENTRATION IN THE WATER LEAVING THE MAIN (OR BYPASS PIPE) IS NO HIGHER THAN THAT GENERALLY

ALL WATERMAIN FITTINGS NOT RECEIVING 24-HOUR CHLORINE DISINFECTION CONTACT TIME MUST BE SWAB DISINFECTED 30 MINUTES PRIOR TO INSTALLATION.

 UPON COMPLETION OF DISINFECTION AND FLUSHING, THE CONTRACTOR SHALL CALL THE MONROE COUNTY DEPARTMENT OF HEALTH (585-753-5057) FOR WATER SAMPLES TO BE COLLECTED. SAMPLES OF WATER MUST BE COLLECTED FROM THE MAIN (OR BYPASS PIPE) AND EACH BRANCH. MAXIMUM DISTANCE BETWEEN DISINFECTION/SAMPLING TAPS ON NEW WATER MAINS AND BYPASS PIPE SHALL BE

• THE SAMPLING POINT(S) MUST BE DECONTAMINATED BY FLAMING.

• FIRE HYDRANTS ARE NOT ACCEPTABLE SAMPLING POINTS.

THE MONROE COUNTY DEPARTMENT OF HEALTH MUST RECEIVE AT LEAST 48-HOUR ADVANCE NOTIFICATION REQUESTING SAMPLING SERVICES. SAMPLING WILL NOT BE PERFORMED PRIOR TO RECEIPT FROM A NEW YORK STATE LICENSED OR REGISTERED DESIGN PROFESSIONAL (ENGINEER, ARCHITECT OR LAND SURVEYOR WITH A SPECIAL EXEMPTION UNDER SECTION 7208(N) OF THE EDUCATION LAW CERTIFYING THAT THE WATER SUPPLY IMPROVEMENTS, TESTING AND DISINFECTION PROCEDURES WERE COMPLETED IN ACCORDANCE WITH THE APPROVED PLANS. REPORTS. SPECIFICATIONS AND ANY APPROVED AMENDMENTS. THE DEPARTMENT WILL COLLECT SAMPLES FOR FREE CHLORINE RESIDUAL, TOTAL AND FECAL COLIFORM AND 24-HOUR BACTERIAL PLATE COUNT

 THE WATER MAIN SHALL NOT BE PLACED INTO SERVICE UNTIL SO AUTHORIZED BY THE MONROE COUNTY DEPARTMENT OF HEALTH.

FOLLOWING DISINFECTION, ALL TREATED WATER SHALL BE THOROUGHLY FLUSHED FROM THE MAIN (MINIMUM FLUSHING VELOCITY 2.5 FEET PER SECOND). SUPER-CHLORINATED WATER SHALL NOT BE DISCHARGE DIRECTLY TO STORM OR SANITARY SEWERS OR WATER COURSES. DECHLORINATION OF TREATED WATER SHALL BE REQUIRED.

FOR BYPASS WATER MAIN. THE CONTRACTOR SHALL DISINFECT THE EXISTING HYDRANT STAND PIPE PRIOR TO CONNECTING THE BYPASS PIPE. THE HYDRANT STAND PIPE SHALL BE DISINFECTED BY POURING 1 QUART OF COMMERCIALLY AVAILABLEL CHLORINE (5% SUCH AS CLOROX) INTO THE HYDRANT. THE CONTRACTOR SHALL FILL THE HYDRANT WITH CLEAN WATER AND LET STAND FOR A MINIMUM OF 20 MINUTES. THE CONTRACTOR SHALL THEN FLUSH THE HYDRANT AND CONNECT THE BYPASS PIPE.

WHEN CONNECTING NEW WATER MAINS, WATER SERVICES 4 INCHES IN DIAMETER AND LARGER, AND HYDRANT BRANCHES TO EXISTING WATER MAINS THE INTERIOR OF NEW PIPE, OPEN PIPE ENDS, SLEEVES, SADDLES, VALVES AND ALL FITTINGS USED TO MAKE THE CONNECTION SHALL BE SWAB DISINFECTED USING A 1-5 PERCENT HYPOCHLORITE (BLEACH) SOLUTION WHENEVER THESE APPURTENANCES HAVE NOT BEEN SUBJECTED TO THE 24 HOUR DISINFECTION CONTACT PERIOD. THE SOLUTION SHALL BE APPLIED NO MORE THAN 30 MINUTES PRIOR TO INSTALLATION.

### **WATER SERVICE NOTES:**

THE CONTRACTOR SHALLL VERIFY THE LOCATION AND DISPOSITION OF ALL WATER SERVICES. THE CONSEQUENCES OF THE CONTRACTOR'S FAILURE TO DO THIS SHALL BE BORNE SOLEY BY THE CONTRACTOR. ALL WATER SERVICE WORK SHALL BE COORDINATED WITH THE ROCHESTER WATER BUREAU.

MINIMUM COVER DEPTH FOR NEW WATER SERVICES IN THIS PROJECT SHALL BE 4.5 FEET FOR DOMESTIC SERVICES UNLESS NOTED OR ORDERED OTHERWISE BY THE PROJECT MANAGER. EXISTING CURB BOXES ON ABANDONED AND PREVIOUSLY ABANDONED SERVICES SHALL BE

AREAS WHERE NO WORK IS PLANNED, OTHERWISE CURB BOX REMOVAL SHALL BE PAID FOR UNDER ITEM R206.04 OR 203.02. FOR NEW WATER SERVICE CARD INFORMATION. THE CONTRACTOR SHALL PROVIDE AN ADDITIONAL COORDINATE MEASUREMENT TO THE NEAREST HYDRANT WHERE SERVICES ARE

MORE THAN 200 FEET FROM THE INTERSECTING STREET RIGHT-OF-WAY. THE CONTRACTOR MUST OBTAIN WORK RELEASES FROM PROPERTY OWNERS WHERE WORK IS REQUIRED ON WATER SERVICES OUTSIDE OF PUBLIC RIGHT-OF-WAYS.

THE CONTRACTOR SHALL PROVIDE TEMPORARY SERVICE TO CUSTOMERS WHOSE SERVICE IS

REMOVED UNDER ITEM S914, AS APPROVED BY THE PROJECT MANAGER, ONLY IF LOCATED IN

DISCONNECTED MORE THAN 24 HOURS. THE CONTRACTOR IS RESPONSIBLE FOR TESTING THE NEW SERVICE PRIOR TO BACKFILLING. THE TEST SHALL CONSIST OF OPENING THE ISOLATION VALVE OR CORPORATION STOP TO EXPOSE THE COMPLETED SERVICE TO ACTIVE LINE PRESSURE IN THE PRESENCE OF THE ENGINEER. ALL WATER SERVICE PIPE AND APPURTENANCES SHALL BE MADE WATER TIGHT PRIOR TO ACCEPTANCE.

### MCPW ROCHESTER PURE WATERS **DISTRICT SEWER NOTES:**

1. THE ROCHESTER PURE WATERS DISTRICT (RPWD) MUST RECEIVE THE FOLLOWING PRIOR TO GIVING NOTICE TO PROCEED WITH SEWER CONSTRUCTION: SHOP DRAWINGS/CERTIFICATION LETTERS/TEST REPORTS FOR ALL MATERIALS TO BE USED FOR THE STORM/SANITARY/COMBINATION MAINLINE SEWER AND LATERAL CONSTRUCTION. THE DOCUMENTS MUST BE APPROVED BY THE CONTRACTOR, ENGINEER AND RPWD PRIOR TO CONSTRUCTION.

2. THE ROCHESTER PURE WATERS DISTRICT SHALL BE NOTIFIED, IN WRITING, SEVEN (7) WORKING DAYS IN ADVANCE OF MAINLINE SEWER CONSTRUCTION, AND FORTY-EIGHT (48) HOURS IN ADVANCE OF LATERAL (CONNECTION) INSTALLATION, OR DISTRICT-SUPPLIED TAP. THE DEVELOPER, OR HIS/HER AGENT, SHALL VERIFY THE SCHEDULING OF ALL WORK THE DAY PRIOR TO ACTUAL WORK WITH A PHONE CALL TO THE DISTRICT (753-7600 OPTION 5).

3. PRIOR TO A LATERAL (SERVICE) CONNECTION AND INSTALLATION, A SEWER CONNECTION PERMIT MUST BE OBTAINED FROM THE MONROE COUNTY PURE WATERS (MCPW) PERMIT OFFICE, 444 FAST HENRIFTTA BOAD, BUILDING 15, BOCHESTER NY 14620. A SEWER CONNECTION PERMIT WILL NOT BE ISSUED UNTIL THE NEW SEWER CONSTRUCTION IS COMPLETE; HAS PASSED ALL REQUIRED TESTS & INSPECTIONS; EASEMENTS TO THE RPWD ARE EXECUTED (IF APPLICABLE); AN AS-BUILT IS FURNISHED TO AND ACCEPTED BY THE RPWD, AND, THE RPWD HAS APPROVED AND ACCEPTED THE

NEW SEWER. A SEWER CONNECTION PERMIT CAN ONLY BE ISSUED TO A LICENSED PLUMBER THAT IS FULLY INSURED AND BONDED IN THE RPWD. APPLICABLE SEWER CONNECTION PERMIT FEES MUST BE PAID PRIOR TO OR AT TIME OF PERMIT ISSUANCE. PAYMENT MUST BE MADE BY CHECK OR MONEY ORDER PAYABLE

CONSTRUCTED IN CONFORMANCE WITH THE REQUIREMENTS OF THE ROCHESTER PURE WATERS APPROPRIATE MEASURES MUST BE TAKEN TO PREVENT DIRT, DEBRIS, AND CONSTRUCTION

MATERIALS FROM ENTERING STORM/SANITARY/COMBINATION SEWERS, LATERALS, CATCH

4. STORM/SANITARY/COMBINATION SEWERS, LATERALS, AND APPURTENANCES SHALL BE

BASINS, MANHOLES, AND APPURTENANCES DURING CONSTRUCTION. IMMEDIATELY REMOVE ANY SUCH MATERIALS FROM MCPW - RPWD SEWERS AND APPLIRTENANCES AND REPAIR ANY DAMAGE CAUSED BY SUCH MATERIALS AT NO COST TO THE OWNER. REPLACE ALL MCPW - RPWD SEWER MANHOLE FRAMES AND COVERS (AS NOTED) WITH NEW FRAMES AND COVERS FURNISHED BY MCPW. MAKE ARRANGEMENTS TO OBTAIN NEW FRAMES

IN CONFORMANCE WITH THE REQUIREMENTS OF THE RPWD 7. ALL OLD/REMOVED CATCH BASIN GRATES AND MANHOLE CASTINGS ARE PROPERTY OF MCPW RPWD. RETURN FRAMES, GRATES AND CASTINGS TO MONROE COUNTY PURE WATERS FLEET CENTER AT 145 PAUL ROAD, MONDAY THROUGH FRIDAY BETWEEN 8:00AM AND 3:00PM AT NOT

AND COVERS FROM MCPW BY CALLING THEIR STOCKROOM AT (585) 753-7521 AT LEAST TWO

WORKING DAYS IN ADVANCE. ADJUSTMENTS TO MCPW RPWD STRUCTURES MUST BE MADE

COST TO THE OWNER. 8. THE MAINLINE SEWER PIPE AND ASSOCIATED FITTINGS SHALL BE PVC SDR-35 CONFORMING TO ASTM D-3034. THE SEWER SERVICE LATERALS AND ASSOCIATED FITTINGS SHALL BE PVC SDR-21 CONFORMING TO ASTM D-2241. JOINTS ON HORIZONTAL PORTIONS SHALL BE PUSH-ON NEOPRENE GASKETS. GLUED OR CHEMICALLY WELDED JOINTS WILL ONLY BE ALLOWED AT, AND ARE REQUIRED FOR, THE WYE FITTING AND FOR RISER PORTIONS OF THE SEWER CLEANOUT. FOR A SEWER CLEANOUT, THE RISER AND APPROPRIATE FITTINGS

SHALL BE SCHEDULE 40 PVC PIPE CONFORMING TO ASTM D-2665.

9. SPACING BETWEEN SEWER MANHOLES SHALL NOT EXCEED THREE HUNDRED FEET (300'). 10. CLEANOUTS SHALL BE INSTALLED ON ALL 4"AND 6" DIAMETER SEWER LATERALS AT THE RIGHT-OF-WAY (ROW) LINE, OR THE SEWER EASEMENT LINE WHERE APPLICABLE. (THE SEWER EASEMENT. RIGHT-OF-WAY AND/OR PROPERTY LINE MUST BE STAKED OUT PRIOR TO INSTALLATION OF LOT LINE CLEANOUTS TO ENSURE PROPER LOCATION OF THE CLEANOUTS.

[REFER TO CLEANOUT DETAIL FOR PROPER INSTALLATION]). 11. ANY PORTION OF A SEWER AND/OR LATERAL WITH LESS THAN FOUR-FEET (4') OF COVER WILL REQUIRE CONCRETE ENCASEMENT. SEWERS/LATERALS WITH LESS THAN

THREE-FEET (3') OF COVER ARE NOT ALLOWED. 12. ELEVATIONS OF BASEMENTS WILL BE SUCH TO ALLOW GRAVITY FLOW OF BASEMENT FIXTURES TO THE SANITARY/COMBINATION SEWER, WHEREVER POSSIBLE.

13. SPECIAL CARE MUST BE TAKEN TO INSURE SEWERS ARE INSTALLED TO DESIGN GRADES. ANY SEWER NOT INSTALLED TO DESIGN GRADE AND BELOW THOSE INDICATED IN SECTION LAKES-UPPER MISSISSIPPI RIVER BOARD OF THE STATE PUBLIC HEALTH AND ENVIRONMENT MANAGERS) [A.K.A. 10 STATES STANDARDS] WILL BE RELAYED WITH AT LEAST THE RECOMMENDED MINIMUM SLOPES AT THE EXPENSE OF THE DEVELOPER OR HIS/HER/THEIR

14. FLOOR DRAINS, IF CONSTRUCTED, SHALL BE CONNECTED TO THE SANITARY/COMBINATION SEWER. FLOOR DRAINS DO NOT INCLUDE FOUNDATION/FOOTER DRAINS. NOTE: ALL DISCHARGES TO THE SANITARY/COMBINATION SEWER MUST COMPLY WITH THE EFFLUENT LIMITS OF THE LOCAL AND/OR MONROE COUNTY SEWER USE LAW.

**ENVIRONMENTAL MANAGEMENT PLAN NOTES:** 

**GENERAL DESCRIPTION OF MATERIAL** 

REGULATED SOLID WASTES (CINDERS, COALS, COAL, ASH, RAILROAD

SOLID WASTE) DETERMINED TO BE UNSUITABLE FOR RELOCATION TO

SURFACE TREATMENTS SUCH AS ASPHALT, CONCRETE, AND PAVERS

TOPSOIL, REWORKED NATIVE AND UNDISTURBED NATIVE MATERIAL.

NON-IMPACTED DEMOLITION MATERIAL INCLUDING ANY WOOD, METAL

BRICKS)WHICH ARE DETERMINED TO BE PHYSICALLY UNACCEPTABLE

NO SLAG. REGULATED SOLID WASTE. OR MIXED FILL MATERIALS GENERATED FROM THE PORT OF ROCHESTER SITE MAY BE PHYSICALLY REMOVED FROM THE

CONTROL OF DUST ORIGINATING FROM THE PORT OF ROCHESTER SITE OR THE 1655 LEXINGTON AVENUE SITE AS A RESULT OF CONTRACTOR OPERATIONS IS

ITEM S203.022

ITEM S203.96

ITEM S203.021

ITEM S203.02

ITEM S206.021

ITEM S206.022

ITEM 206,02

PORT OF ROCHESTER SITE WITHOUT EXPRESSED WRITTEN PERMISSION FROM THE CITY OF ROCHESTER OR THE ENVIRONMENTAL PROJECT MONITOR.

CONSIDERED A CRITICAL RESPONSIBILITY OF THE CONTRACTOR. REFER TO ENVIRONMENTAL MANAGEMENT PLAN (EMP) SPECIFICATION S203.98. FOR

ADDITIONAL INFORMATION REGARDING COMMUNITY AIR MONITORING PLANS (CAMPS) AND REQUIRED PROVISIONS FOR DUST CONTROL.

SCRAP, DRAINAGE PIPING, MASONRY (E.G., CONCRETE, BLOCK,

TIES. PETROLEUM IMPACTED SOILS. AND ALL OTHER REGULATED

THE STORAGE STOCKPILE AT 1655 LEXINGTON AVENUE

PREDOMINATELY SLAG. EXCAVATED WITH VERY

MINOR QUANTITIES OF MIXED FILL MATERIAL.

PROJECT] ARE BRIEFLY SUMMARIZED IN THE FOLLOWING TABLE:

FOR RE-USE.

**SOILS PAYMENT DIAGRAM:** 

MASS EXCAVATION

TRENCH EXCAVATION

**CLASS OF** 

MATERIAL

MATERIAL

1. THE CONTRACTOR ACKNOWLEDGES THAT THE CITY OF ROCHESTER WILL HAVE AN ENVIRONMENTAL PROJECT MONITOR ON-SITE TO INSPECT AND MONITOR THE EXCAVATION, CLASSIFICATION,

COMINGLING OF EXCAVATED MATERIALS. IN AVOIDING COMINGLING OF DIFFERENT CLASSIFICATIONS OF FILLS, EXCAVATIONS MAY REQUIRE REMOVAL OF MATERIAL IN ONE (1) TO TWO (2)

FOOT LIFTS. THE CLASSES OF MATERIAL ANTICIPATED FOR EXCAVATION, SEGREGATION AND MANAGEMENT [AS DETAILED IN THE ENVIRONMENTAL MANAGEMENT PLAN (EMP) FOR THIS

SEGREGATION, AND MANAGEMENT OF SPOILS. FOR THIS CONTRACT, THE CONTRACTOR WILL BE REQUIRED TO EXCAVATE THE SUBSURFACE MATERIAL IN DISCRETE LAYERS TO MINIMIZE THE

### MCPW ROCHESTER PURE WATERS DISTRICT SEWER NOTES: (CONT.)

15. EXFILTRATION AND/OR INFILTRATION FOR SEWERS SHALL BE LIMITED TO 100 GALLONS PER DAY, PER MILE OF PIPE, PER INCH DIAMETER FOR SANITARY AND COMBINATION SEWERS AND 250 GALLONS PER DAY, PER MILE OF PIPE, PER INCH DIAMETER FOR STORM SEWERS. TESTING SHALL BE PERFORMED IN ACCORDANCE WITH RPWD PROCEDURES.

16. DEFLECTION TESTS SHALL BE PERFORMED ON ALL FLEXIBLE PIPE. THE TEST SHALL BE CONDUCTED AFTER ALL FINAL BACKFILL HAS BEEN IN PLACE AT LEAST THIRTY (30) DAYS NO PIPE SHALL EXCEED A DEFLECTION OF FIVE PERCENT (5%) IF THE DEFLECTION TEST IS TO BE RUN USING A RIGID BALL OR MANDREL, IT SHALL HAVE A MINIMUM DIAMETER EQUAL TO NINETY-FIVE PERCENT (95%) OF THE INSIDE DIAMETER OF THE PIPE. THE TEST SHALL BE PERFORMED WITHOUT MECHANICAL PULLING DEVICES.

18. "AS-BUILT" DRAWINGS SHALL BE FURNISHED TO THE RPWD. THE "AS-BUILT"PLANS SHALL INDICATE THE EXACT LOCATION OF ALL SEWERS, MANHOLES, WYE BRANCHES, LATERALS, AND CLEANOUTS AS WELL AS LENGTHS AND SLOPES OF PIPES. ELEVATIONS OF ALL SEWER MANHOLE RIMS AND INVERTS AND LATERAL DEPTHS AT PROPERTY LINES OR RPWD EASEMENT LINES SHALL ALSO BE SHOWN.

17. SEWERS SHALL BE CLOSED-CIRCUIT VIDEOTAPED IN ACCORDANCE WITH RPWD STANDARDS.

19. THE REQUIREMENTS OF THE HIGHWAY OWNER/PROPERTY OWNER SHALL BE ADHERED TO FOR ITEMS ABOVE THE PIPE BEDDING. INCLUDING. BUT NOT LIMITED TO. MAINTENANCE AND PROTECTION OF TRAFFIC, BACKFILL MATERIAL AND SURFACE RESTORATION.

### **SURVEY NOTES:**

### HORIZONTAL CONTROL

THE HORIZONTAL DATUM SHOWN HEREON IS REFERENCED TO THE NEW YORK STATE PLANE COORDINATE SYSTEM, NAD 1983 TRANSVERSE MERCATOR PROJECTION, WESTERN ZONE THROUGH CONTROL TIES TO THE FOLLOWING MONUMENTATION:

1. USC&GS MONUMENT "RIVER". NO.047700203 - N 1185594.15 E 1406909.92 2. US ARMY CORP. OF ENG. MONUMENT "GENESEE", NO.047480101 - N 1190701.09 E 1410427.40 3. M.C.G.S. MONUMENT 4-1-53. NO.047700103 - N 1185582.59 E 1406336.43

THE PERIMETER AND TIES TO CONTROL MONUMENTS WERE ACCOMPLISHED USING PROCEDURES NECESSARY TO ACHIEVE AN ACCURACY OF ONE PART IN TEN THOUSAND (1/10000) OR BETTER.

COORDINATES SHOWN HEREON ARE AT GRID,

COMBINED FACTOR (SEA LEVEL & SCALE FACTOR) = 1.00000564

GROUND DISTANCES X COMBINED FACTOR = GRID DISTANCE. DISTANCES ARE AT GROUND.

### VERTICAL CONTROL:

THE VERTICAL DATUM SHOWN HEREON IS REFERENCED TO THE ROCHESTER CITY DATUM THROUGH CONTROL TIES TO THE FOLLOWING MONUMENTS:

1. USLS-"BATH HOUSE", NO.047390106 ELEVATION = 255.374

ELEVATION = 252.408'

GENERAL MANAGEMENT OF MATERIAL

PART 360 PERMITTED LANDFILL.

360 REGULATIONS.

FRANSPORTATION AND PLACEMENT IN AN OFF-SITE STORAGE STOCKPILE AT 1655.

1655 LEXINGTON AVENUE SHALL BE VIA NYSDEC PART 364 PERMITTED TRUCKS.

LEXINGTON AVENUE IN ACCORDANCE WITH THE NYSDEC PART 360-1.7(B)(4) EXEMPTION.

ALL TRANSPORTATION OF CLASS 1 MATERIAL FROM THE PORT OF ROCHESTER SITE TO

CLASS 2 MATERIAL SHALL BE MANAGED ON-SITE AS REGULATED SOLID WASTE IN

ACCORDANCE WITH ALL APPLICABLE RULES AND REGULATIONS UNTIL THE MATERIAL CAN BE

REMOVED FROM THE SITE FOR DISPOSAL. ALL TRANSPORTATION OF CLASS 2 MATERIAL

SURFACE TREATMENTS SUCH AS ASPHALT, CONCRETE, AND PAVERS SHALL BE REMOVED

REWORKED NATIVE AND UNDISTURBED NATIVE MATERIAL SHALL BE RE-USED ON-SITE OR

IS TO BE REMOVED FROM THE PORT OF ROCHESTER SITE AS CLEAN FILL. NON-IMPACTED

MASONRY (E.G. CONCRETE, BLOCK, BRICKS) WHICH ARE DETERMINED TO BE PHYSICALLY

UNACCEPTABLE FOR RE-USE SHALL BE SEPARATELY STOCKPILED FOR OFF-SITE DISPOSAL

OR RECYCLING. A PORTION OF THIS MATERIAL MAY BE CONSIDERED TO BE A REGULATED

SOLID WASTE AND REQUIRED HANDLING AND DISPOSAL IN ACCORDANCE WITH THE PART

CITY STORAGE SITE

**CLEAN FILL SITE** 

AND RECYCLED OR DISPOSED OF AT THE CONTRACTOR'S DISCRETION. TOPSOIL.

DEMOLITION MATERIAL INCLUDING ANY WOOD. METAL SCRAP, DRAINAGE PIPING,

SHALL BE VIA NYSDEC PART 364 PERMITTED TRUCKS FOR OFF-SITE DISPOSAL AT A NYSDEC

2. RTS MONUMENT NO. 047620203, SW COR. OF LAKE AVE. AND LATTA ROAD ELEVATION = 283.084

3. RTS MONUMENT NO. 047620104, NW COR. OF LATTA RD. AND RIVER ST.

4. RTS MONUMENT NO. 047470113, N. SIDE OF BEACH AVE, 140'+/- WEST OF RIVER WALL ELEVATION = 250.542

### DRAWING NUMBER DRAWING NAME GENERAL PLANS GENERAL NOTES & LIST OF DRAWINGS G1.01 G2.01 GENERAL LAYOUT PLAN STAGING / MPOT PLAN G3.01 - G3.04 **EROSION AND SEDIMENT CONTROL PLAN** G4.01 - G4.02 **EROSION AND SEDIMENT CONTROL DETAILS** G4.03 ALIGNMENT DATA G5.01 G5.02 SURVEY CONTROL CITY STORAGE SITE - 1655 LEXINGTON AVE. G6.01

V1.01 - V1.02

P1.01

P2.01

SURVEY / MAPPING PLANS

**EXISTING CONDITIONS PLAN & LEGEND** 

**LIST OF DRAWINGS** 

CIVIL PLANS SALAVAGE PLAN C1.01 - C1.02 SURFACE DEMOLITION PLAN C1.03 - C1.04 UTILITY DEMOLITION PLAN C1.05 - C1.06 C2.01 - C2.02 UTILITY PLAN UTILITY PLAN ENLARGEMENTS C2.03 - C2.04 UTILITY PROFILE LAYOUT PLAN C3.01 - C3.02 C3.03 - C3.07 UTILITY PROFILES SITE PLAN C4.01 - C4.02 C5.01 - C5.03 STREET PROFILES **GRADING PLAN** C6.01 - C6.02 STREET STRIPING & SIGNAGE PLAN C7.01 - C7.02 CONSTRUCTION TABLES C8.01 - C8.03 CONSTRUCTION DETAILS - STORM & SANITARY C9.01 - C9.03 CONSTRUCTION DETAILS - WATER MAIN C10.01 - C10.02 C11.01 - C11.02 TYPICAL SECTIONS - STREETS **CONSTRUCTION DETAILS - STREET** C12.01 - C12.04 CONSTRUCTION DETAILS - LIGHTING C13.01 - C13.02 **ELECTRICAL PLANS** 

ELECTRICAL SITE PLAN E1.01 E1.02 **ELECTRICAL SITE PLAN** LINK BLDG. ELECTRICAL PLAN E2.01 E3.01 ELECTRICAL DETAILS Record Drawing - ELECTRICAL ONELINE DIAGRAM E-100 Record Drawing - PARTIAL SITE ELECTRICAL PLAN E-120 Record Drawing - GROUND FLOOR POWER PLAN E-200 Record Drawing - LINK BUILDING POWER PLAN E-240 PLUMBING & FIRE PROTECTION PLANS

LINK BLDG. PLUMBING AND FIRE PROTECTION DEMO PLAN

LINK BLDG. PLUMBING AND FIRE PROTECTION PLAN

MARINE PLANS MARINA LAYOUT PLAN ME1.01 MARINA ENTRANCE DETAILS ME1.02 MARINA UTILITIES AND FIRE PROTECTION ME1.03 MARINA ELECTRICAL CIRCUITS ME1.04 ME3.01 COMBINED SECTIONS MARINA BASIN DETAILS ME5.01 - ME5.02 FLOATING DOCK DETAILS ME5.03 **GANGWAY PLATFORM ENLARGEMENTS** ME5.04 MARINA ENTRANCE DETAILS AND DREDGE PLAN ME5.05 RIVER WALL AND PIER DETAILS ME5.06 MARINE DETAILS ME5.07

LANDSCAPE PLANS PLANTING PLAN LP1.01 - LP1.02 PLANTING DETAILS LP5.01 HARDSCAPE AND SITE FURNISHINGS PLAN HARDSCAPE DETAILS

LS1.01 - LS1.02 DRAWING NUMBER LS5.01 - LS5.04

JRE / MHB

JWM / JRE

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ISSUED FOR

date of such alteration, and a specific description of the alteration.

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DESIGNED BY

DRAWN BY:

REVIEWED BY

PROJECT NUMBER:

518 Broad Street, Suite 200

P: (269) 932.4502 F: (269) 932 3542

St. Joseph, Michigan 49085

elationships. Resources. Results www.labellapc.com 300 State Street Architecture


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PROJECT/CLIENT

PORT OF ROCHESTER MARINA DEVELOPMENT **PROJECT** ROCHESTER, NY





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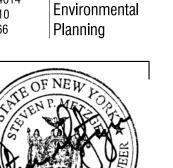
www.edgewaterresources.com 518 Broad Street, Suite 200 St. Joseph, Michigan 49085 P: (269) 932.4502 F: (269) 932.3542
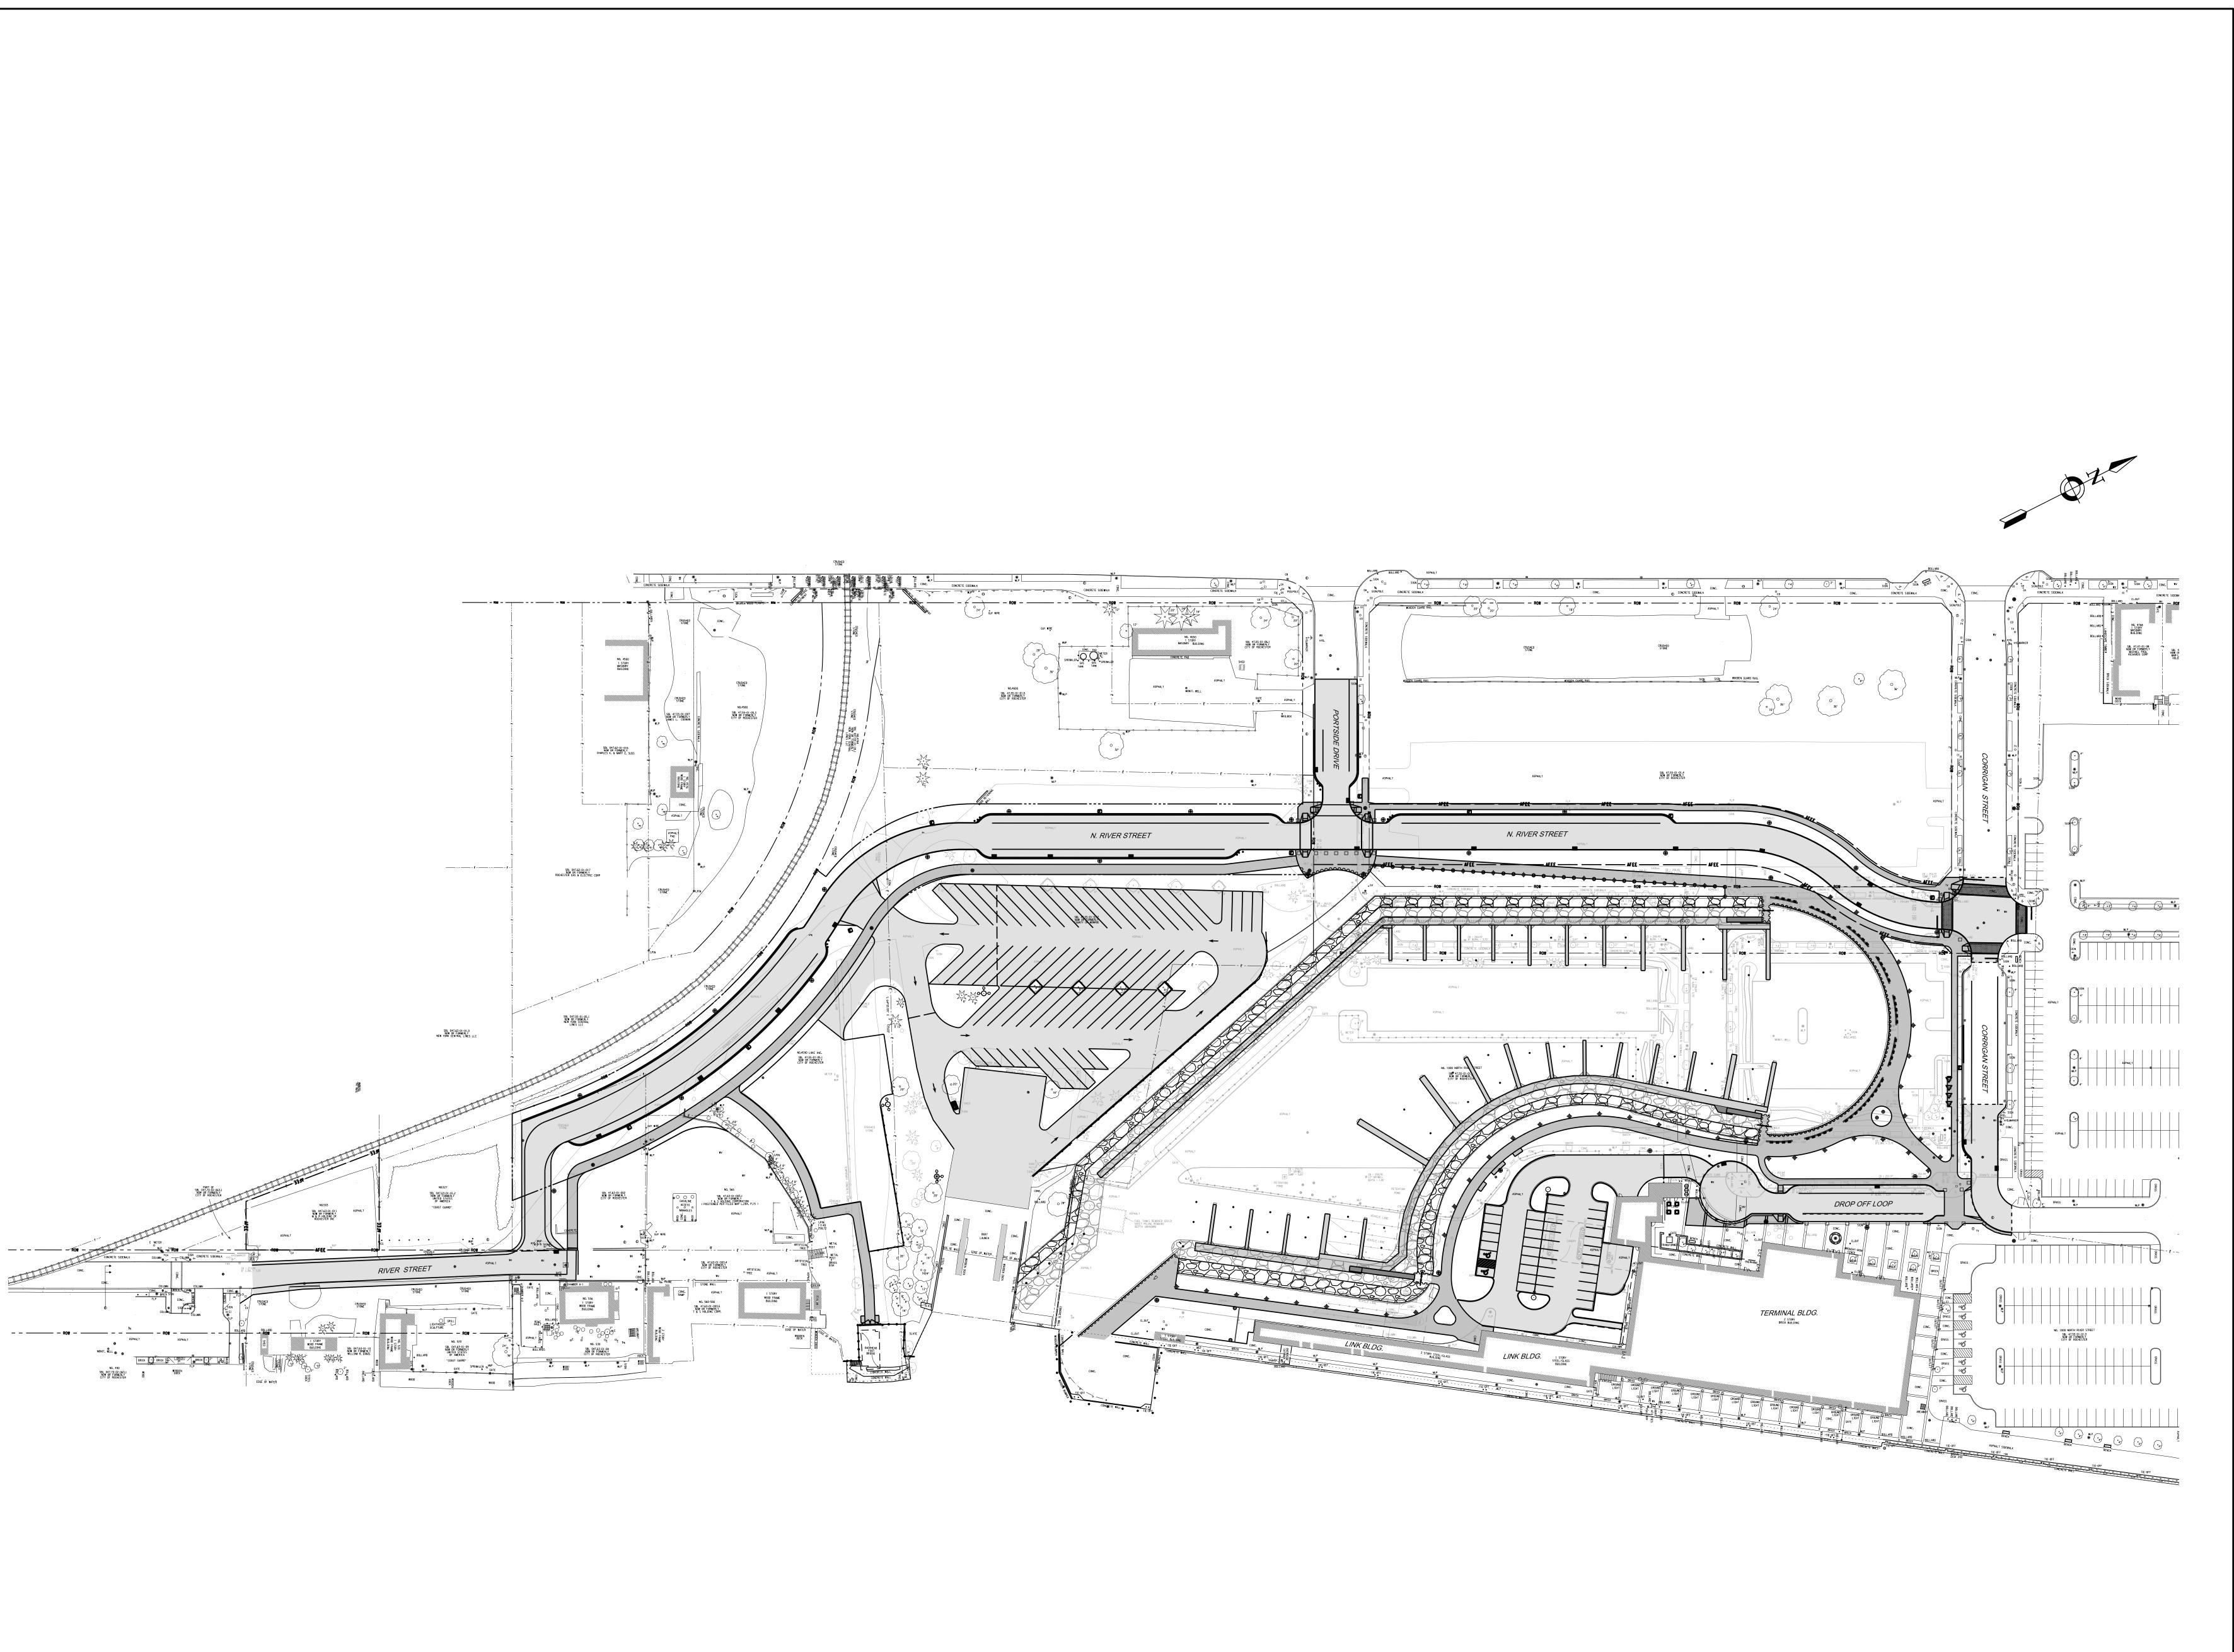
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City of Rochester

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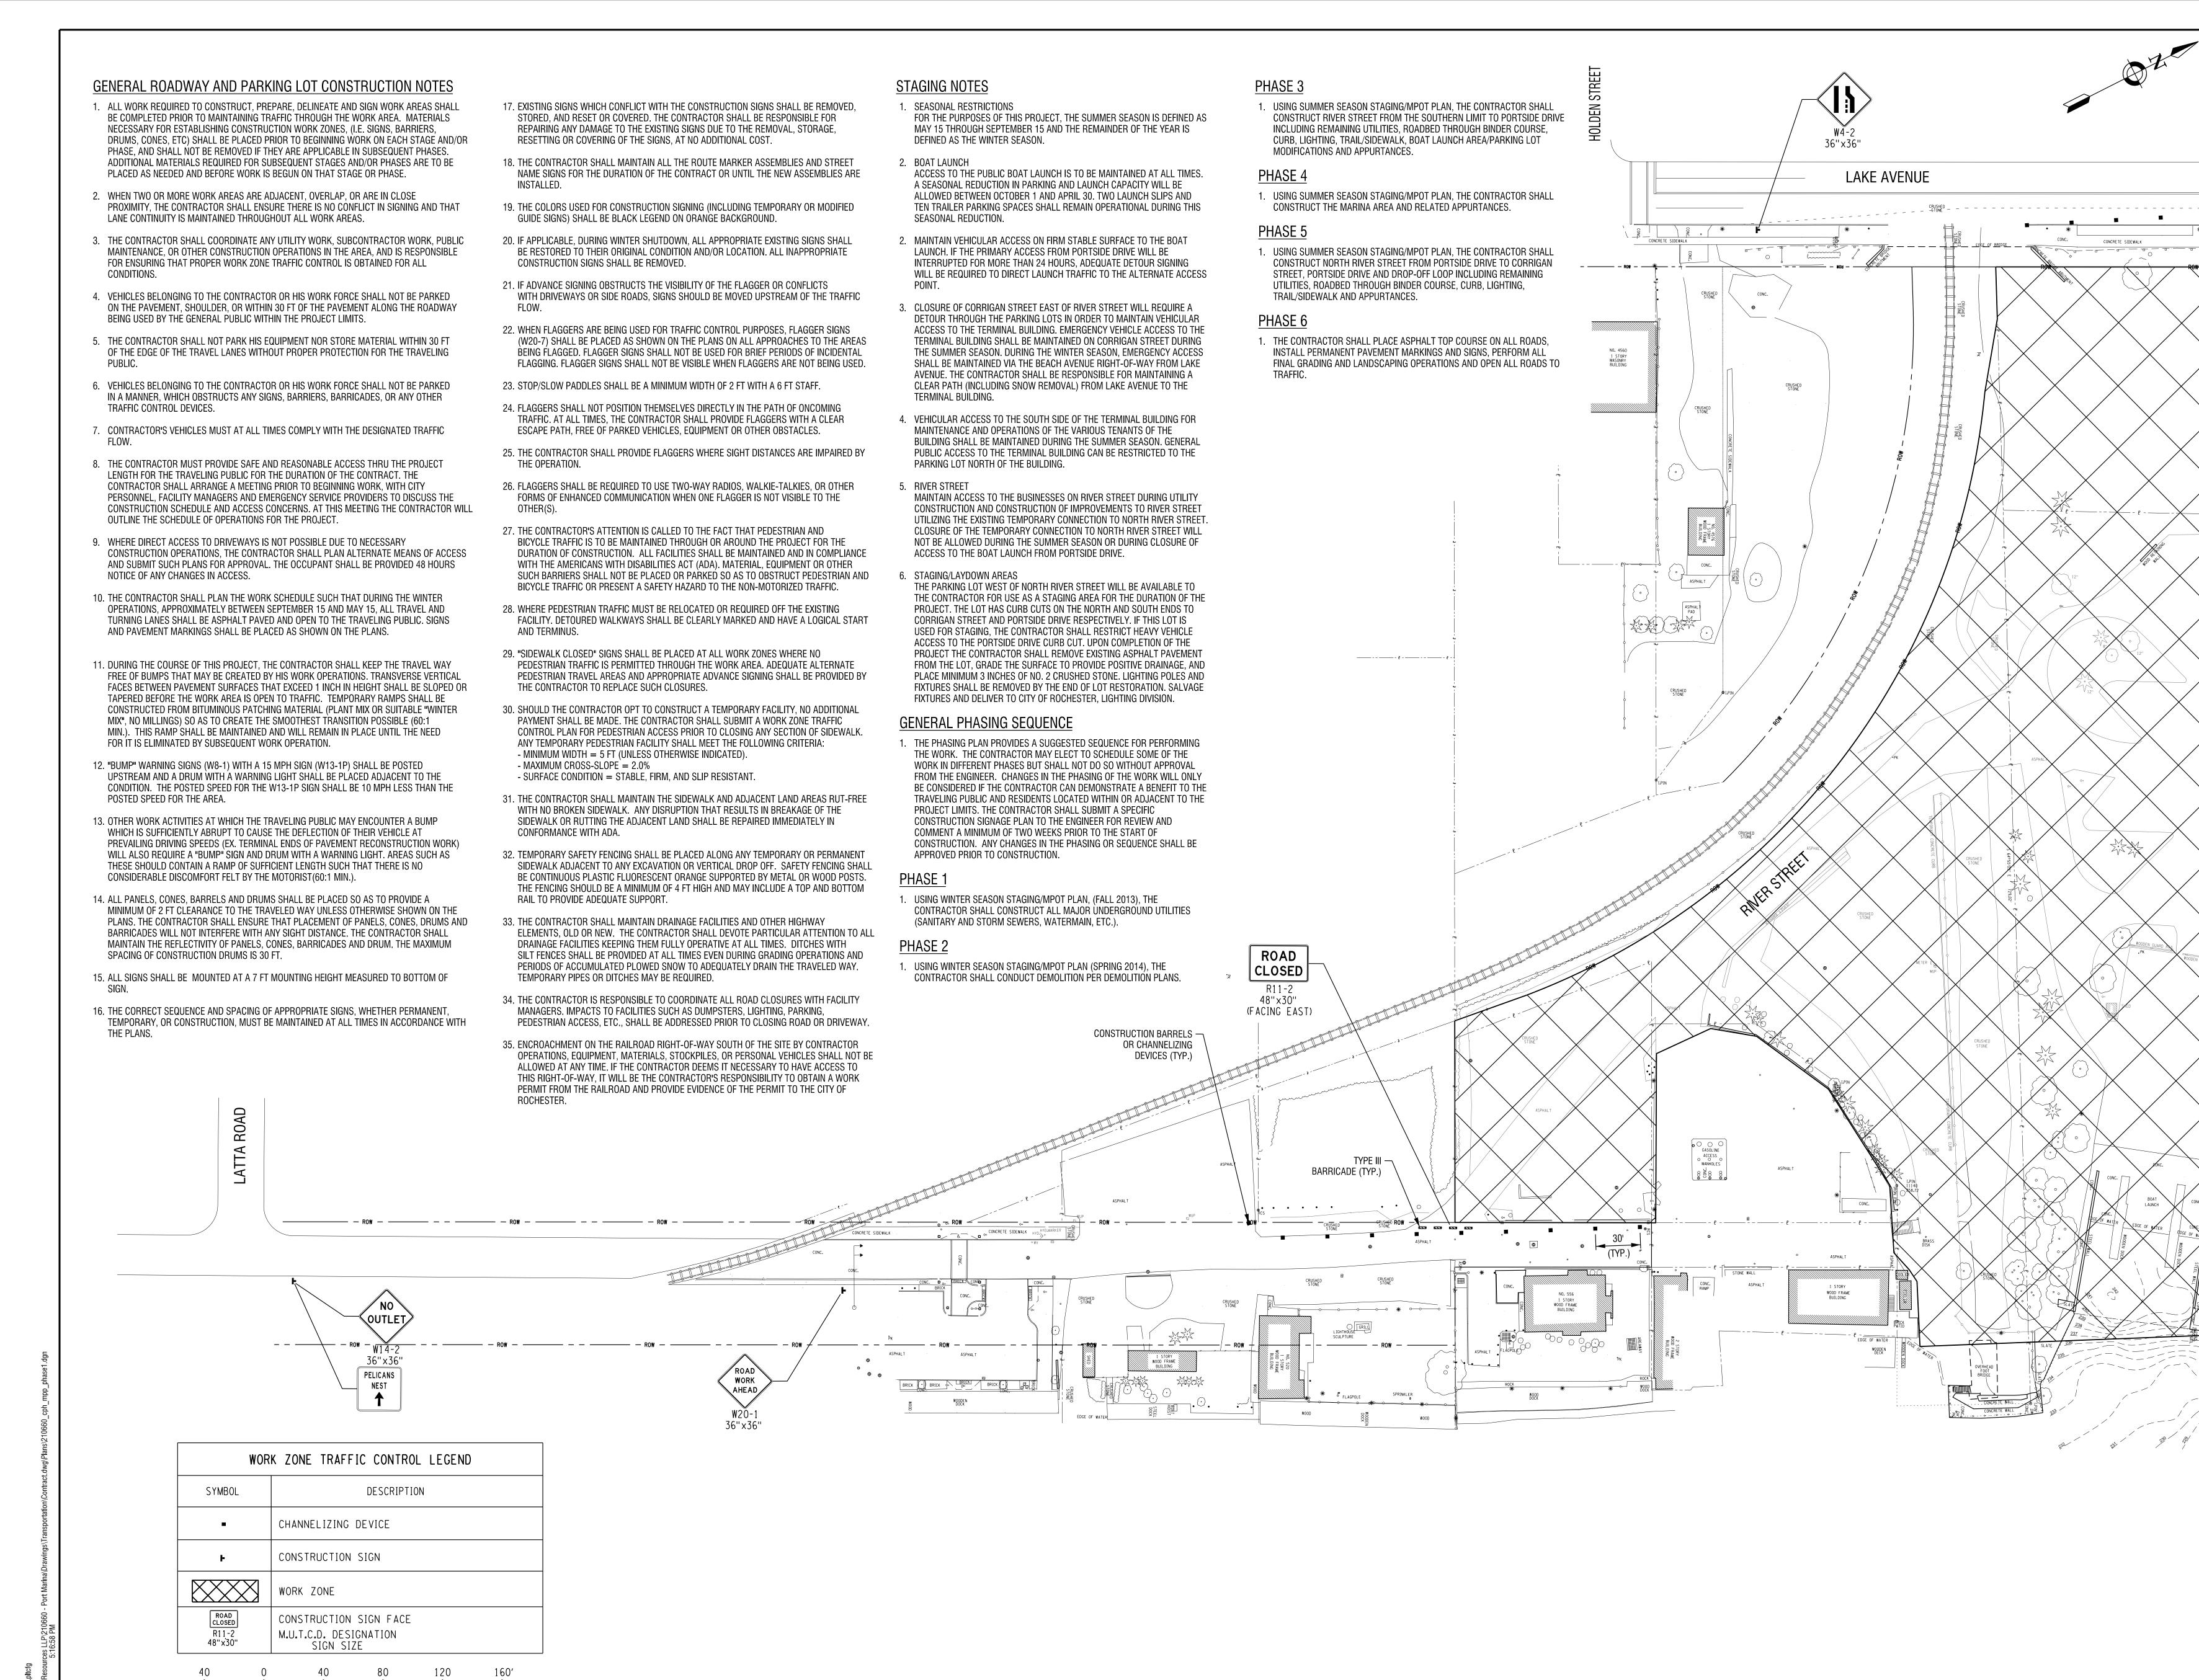
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DRAWING TIT

GENERAL LAYOUT PLAN

	DATE:	JULY 22, 2013
	SCALE:	1" = 60'
	DESIGNED BY:	МНВ
	DRAWN BY:	МНВ
	REVIEWED BY:	МНВ
	PROJECT NUMBER:	210660

G2.01



518 Broad Street, Suite 200 St. Joseph, Michigan 49085 P: (269) 932.4502 F. (269) 932.3542 elationships. Resources. Results. www.labellapc.com Architecture Rochester, NY 14614 Environmental P: (585) 454-6110 F: (585) 454-3066 Planning PROJECT/CLIENT PORT OF ROCHESTER MARINA DEVELOPMENT **PROJECT** ROCHESTER, NY **City of Rochester** REVISION -- | ---- | -- | -- | -- |

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ISSUED FOR

BID

STAGING/MPOT
PLAN
WINTER SEASON
(SEPTEMBER - MAY)

 DATE:
 JOLY 22, 2013

 SCALE:
 1" = 40'


 DESIGNED BY:
 CAE

 DRAWN BY:
 CON

 REVIEWED BY:
 WDD

 PROJECT NUMBER:
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G3\_01

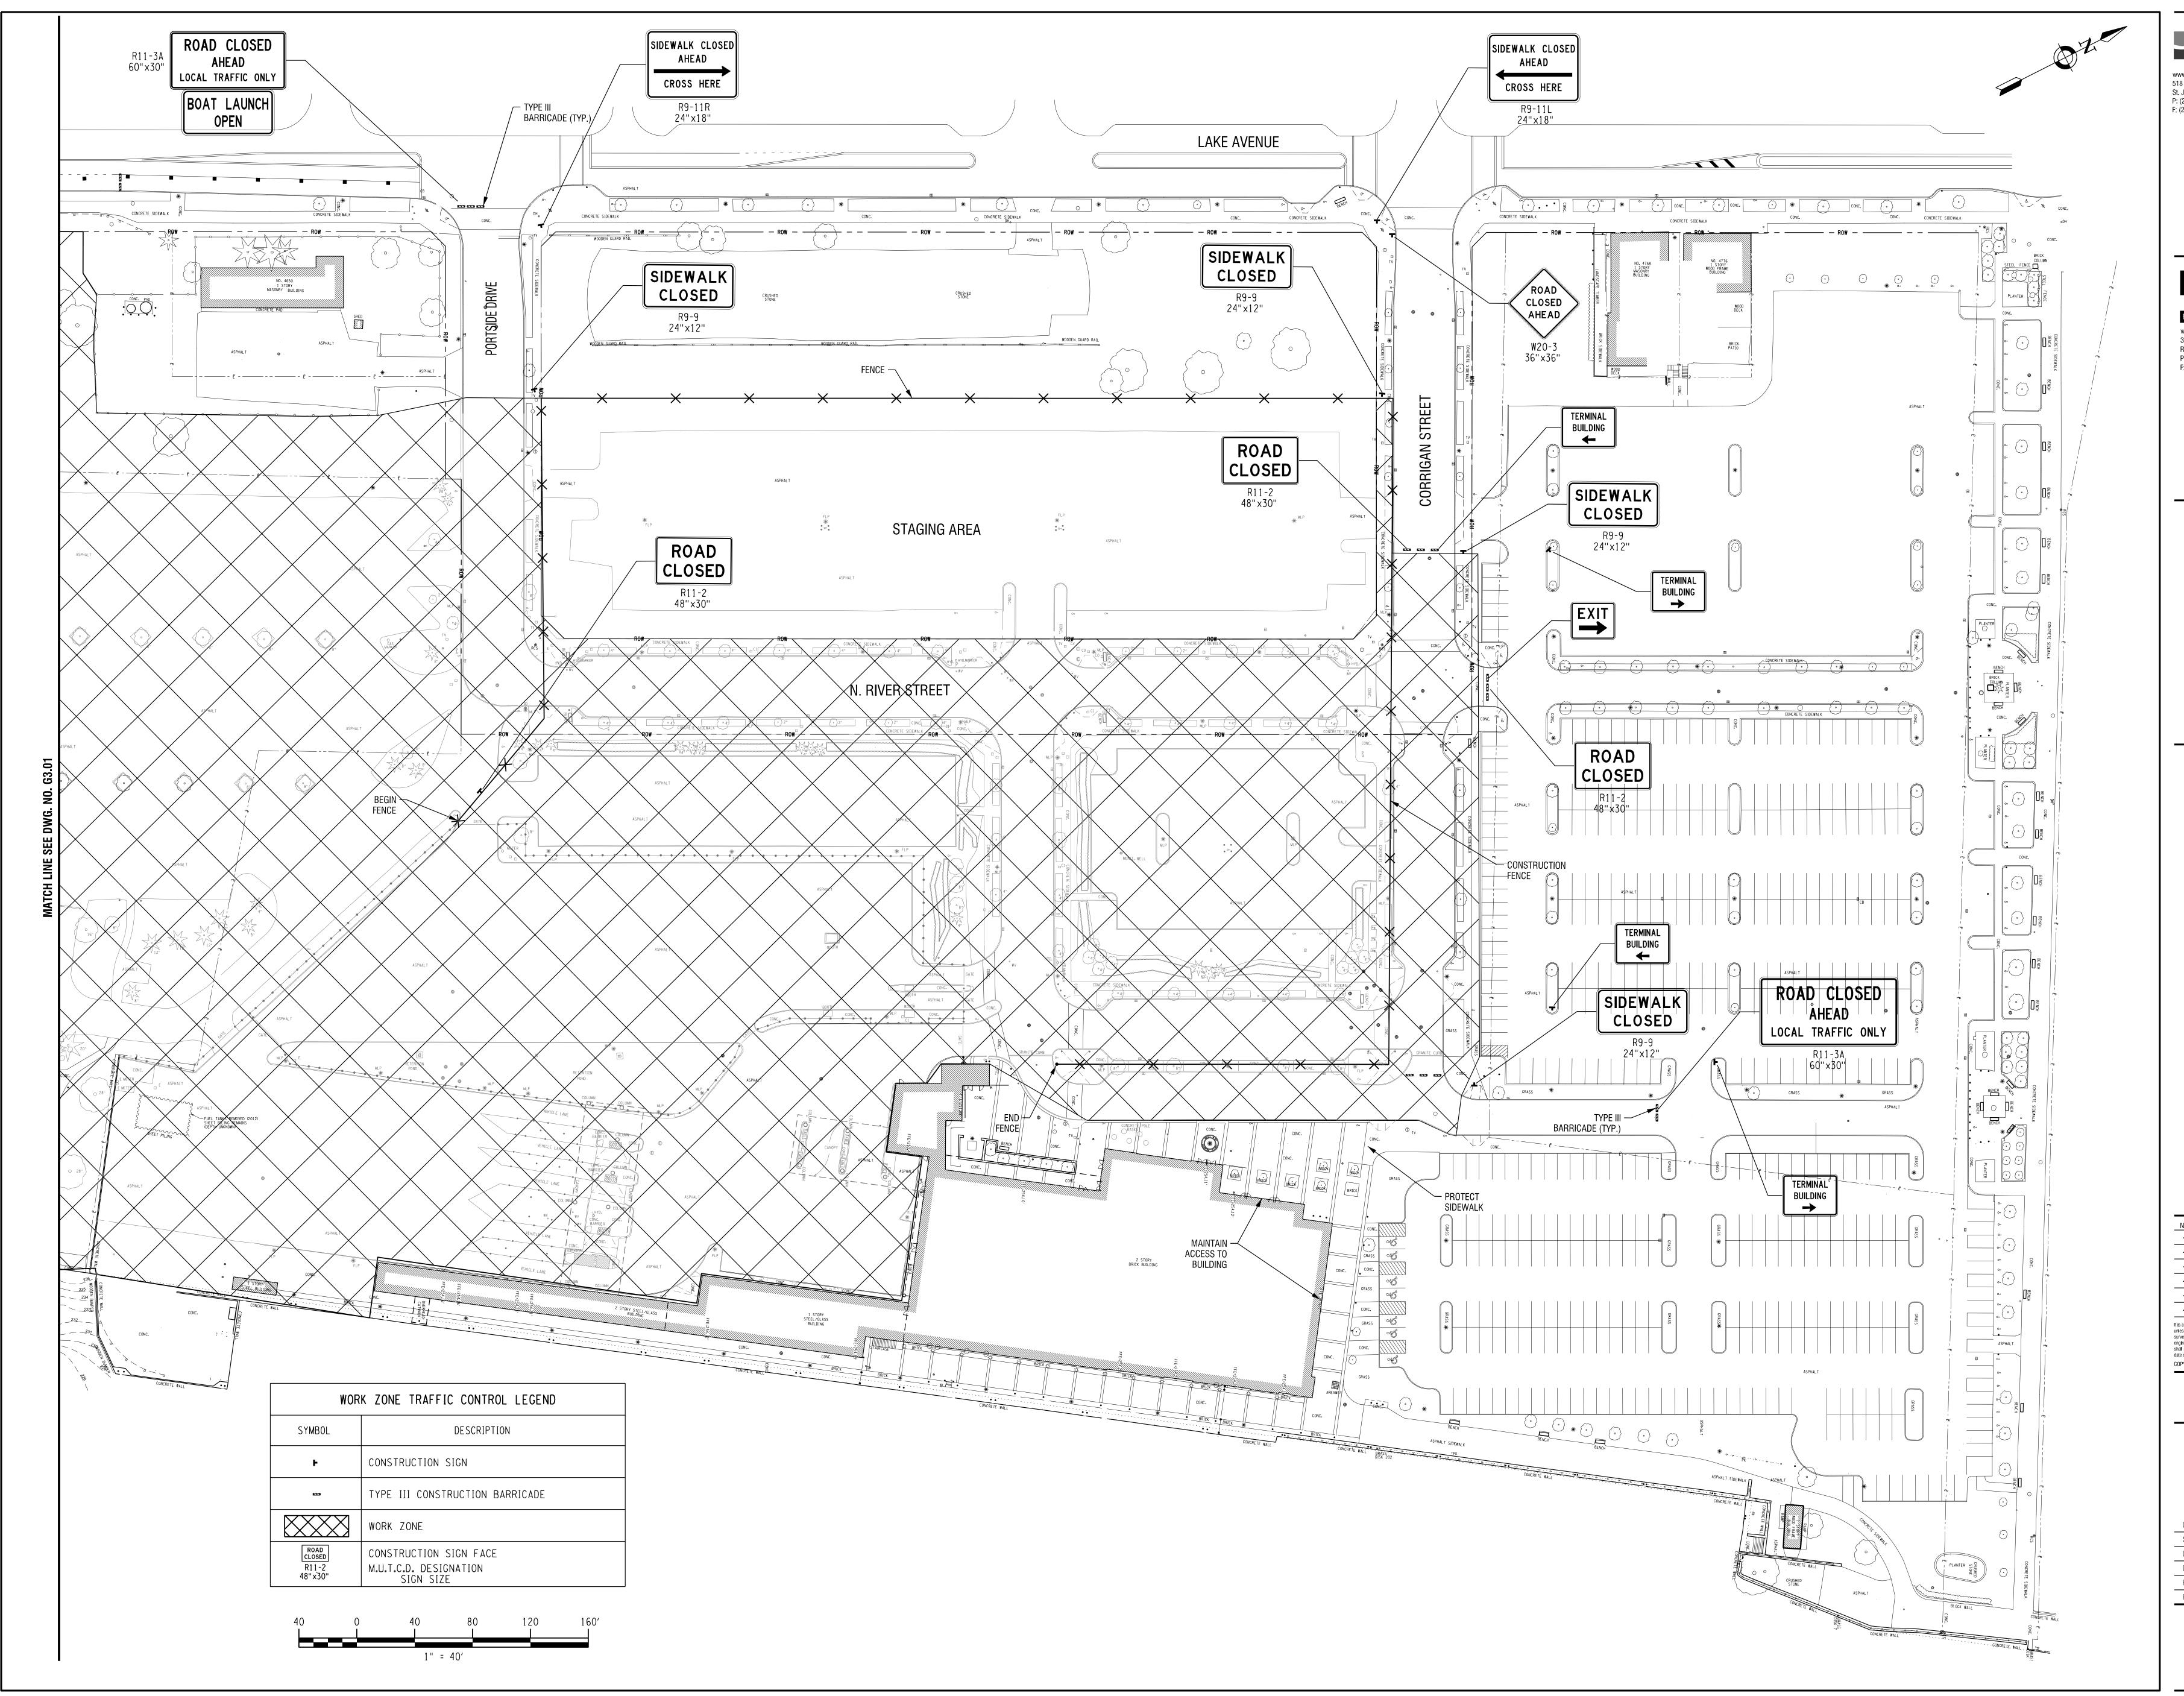

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PORT OF ROCHESTER
MARINA DEVELOPMENT
PROJECT
ROCHESTER, NY



City of Rochester

surveyor, to after an item in any way. If an item bearing the seal of an architect, engineer, or land surveyor is altered; the altering architect, engineer, or land surveyor shall affix to the item their seal and notation "aftered by followed by their signature and date of such afteration, and a specific description of the afteration.

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ISSUED FOR

BID

STAGING/MPOT
PLAN
WINTER SEASON
(SEPTEMBER - MAY)

 SCALE:
 1" = 40'


 DESIGNED BY:
 CAE

 DRAWN BY:
 CON

 REVIEWED BY:
 WDD

 PROJECT NUMBER:
 210660

G3.02

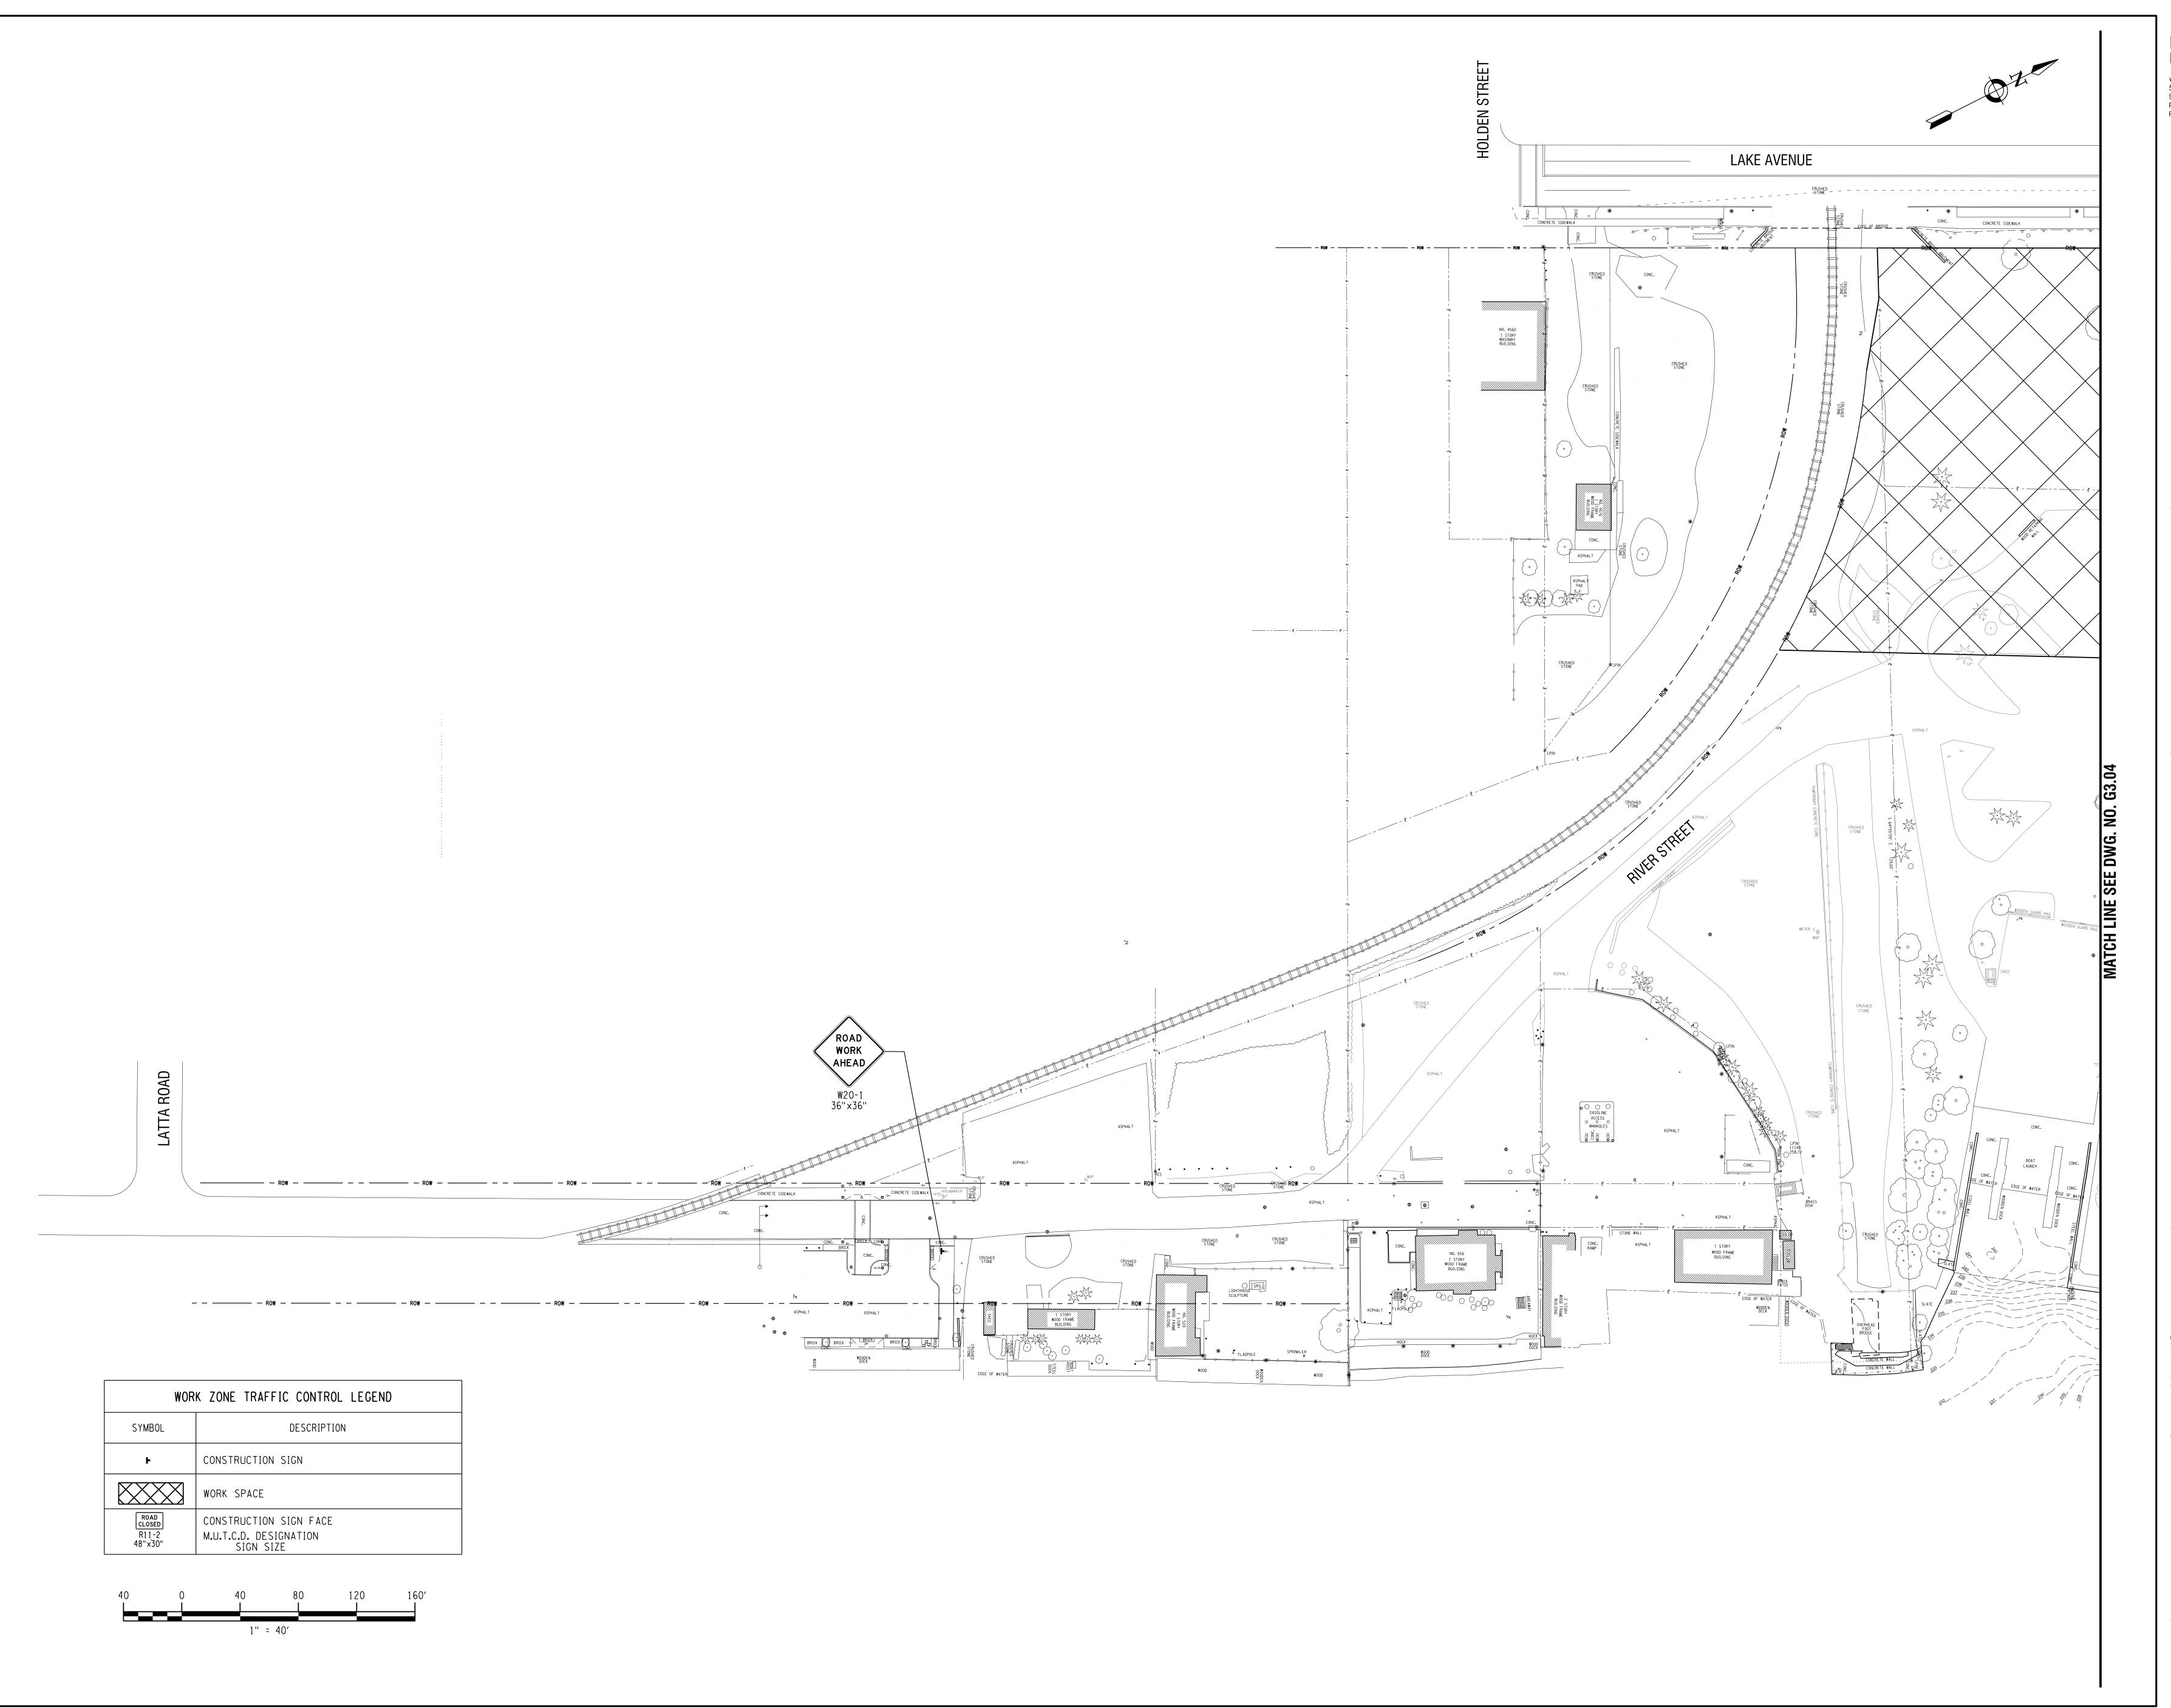


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PROJECT
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NO. DATE REVISION
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DRAWING TITLE

STAGING/MPOT

STAGING/MPOT PLAN SUMMER SEASON (MAY - SEPTEMBER)

SCALE: 1" = 40'

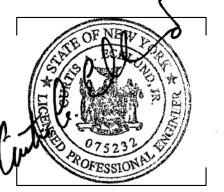DESIGNED BY: CAE


DRAWN BY: CON

REVIEWED BY: WDD

PROJECT NUMBER: 210660


DRAWING NUMBER

G3.03

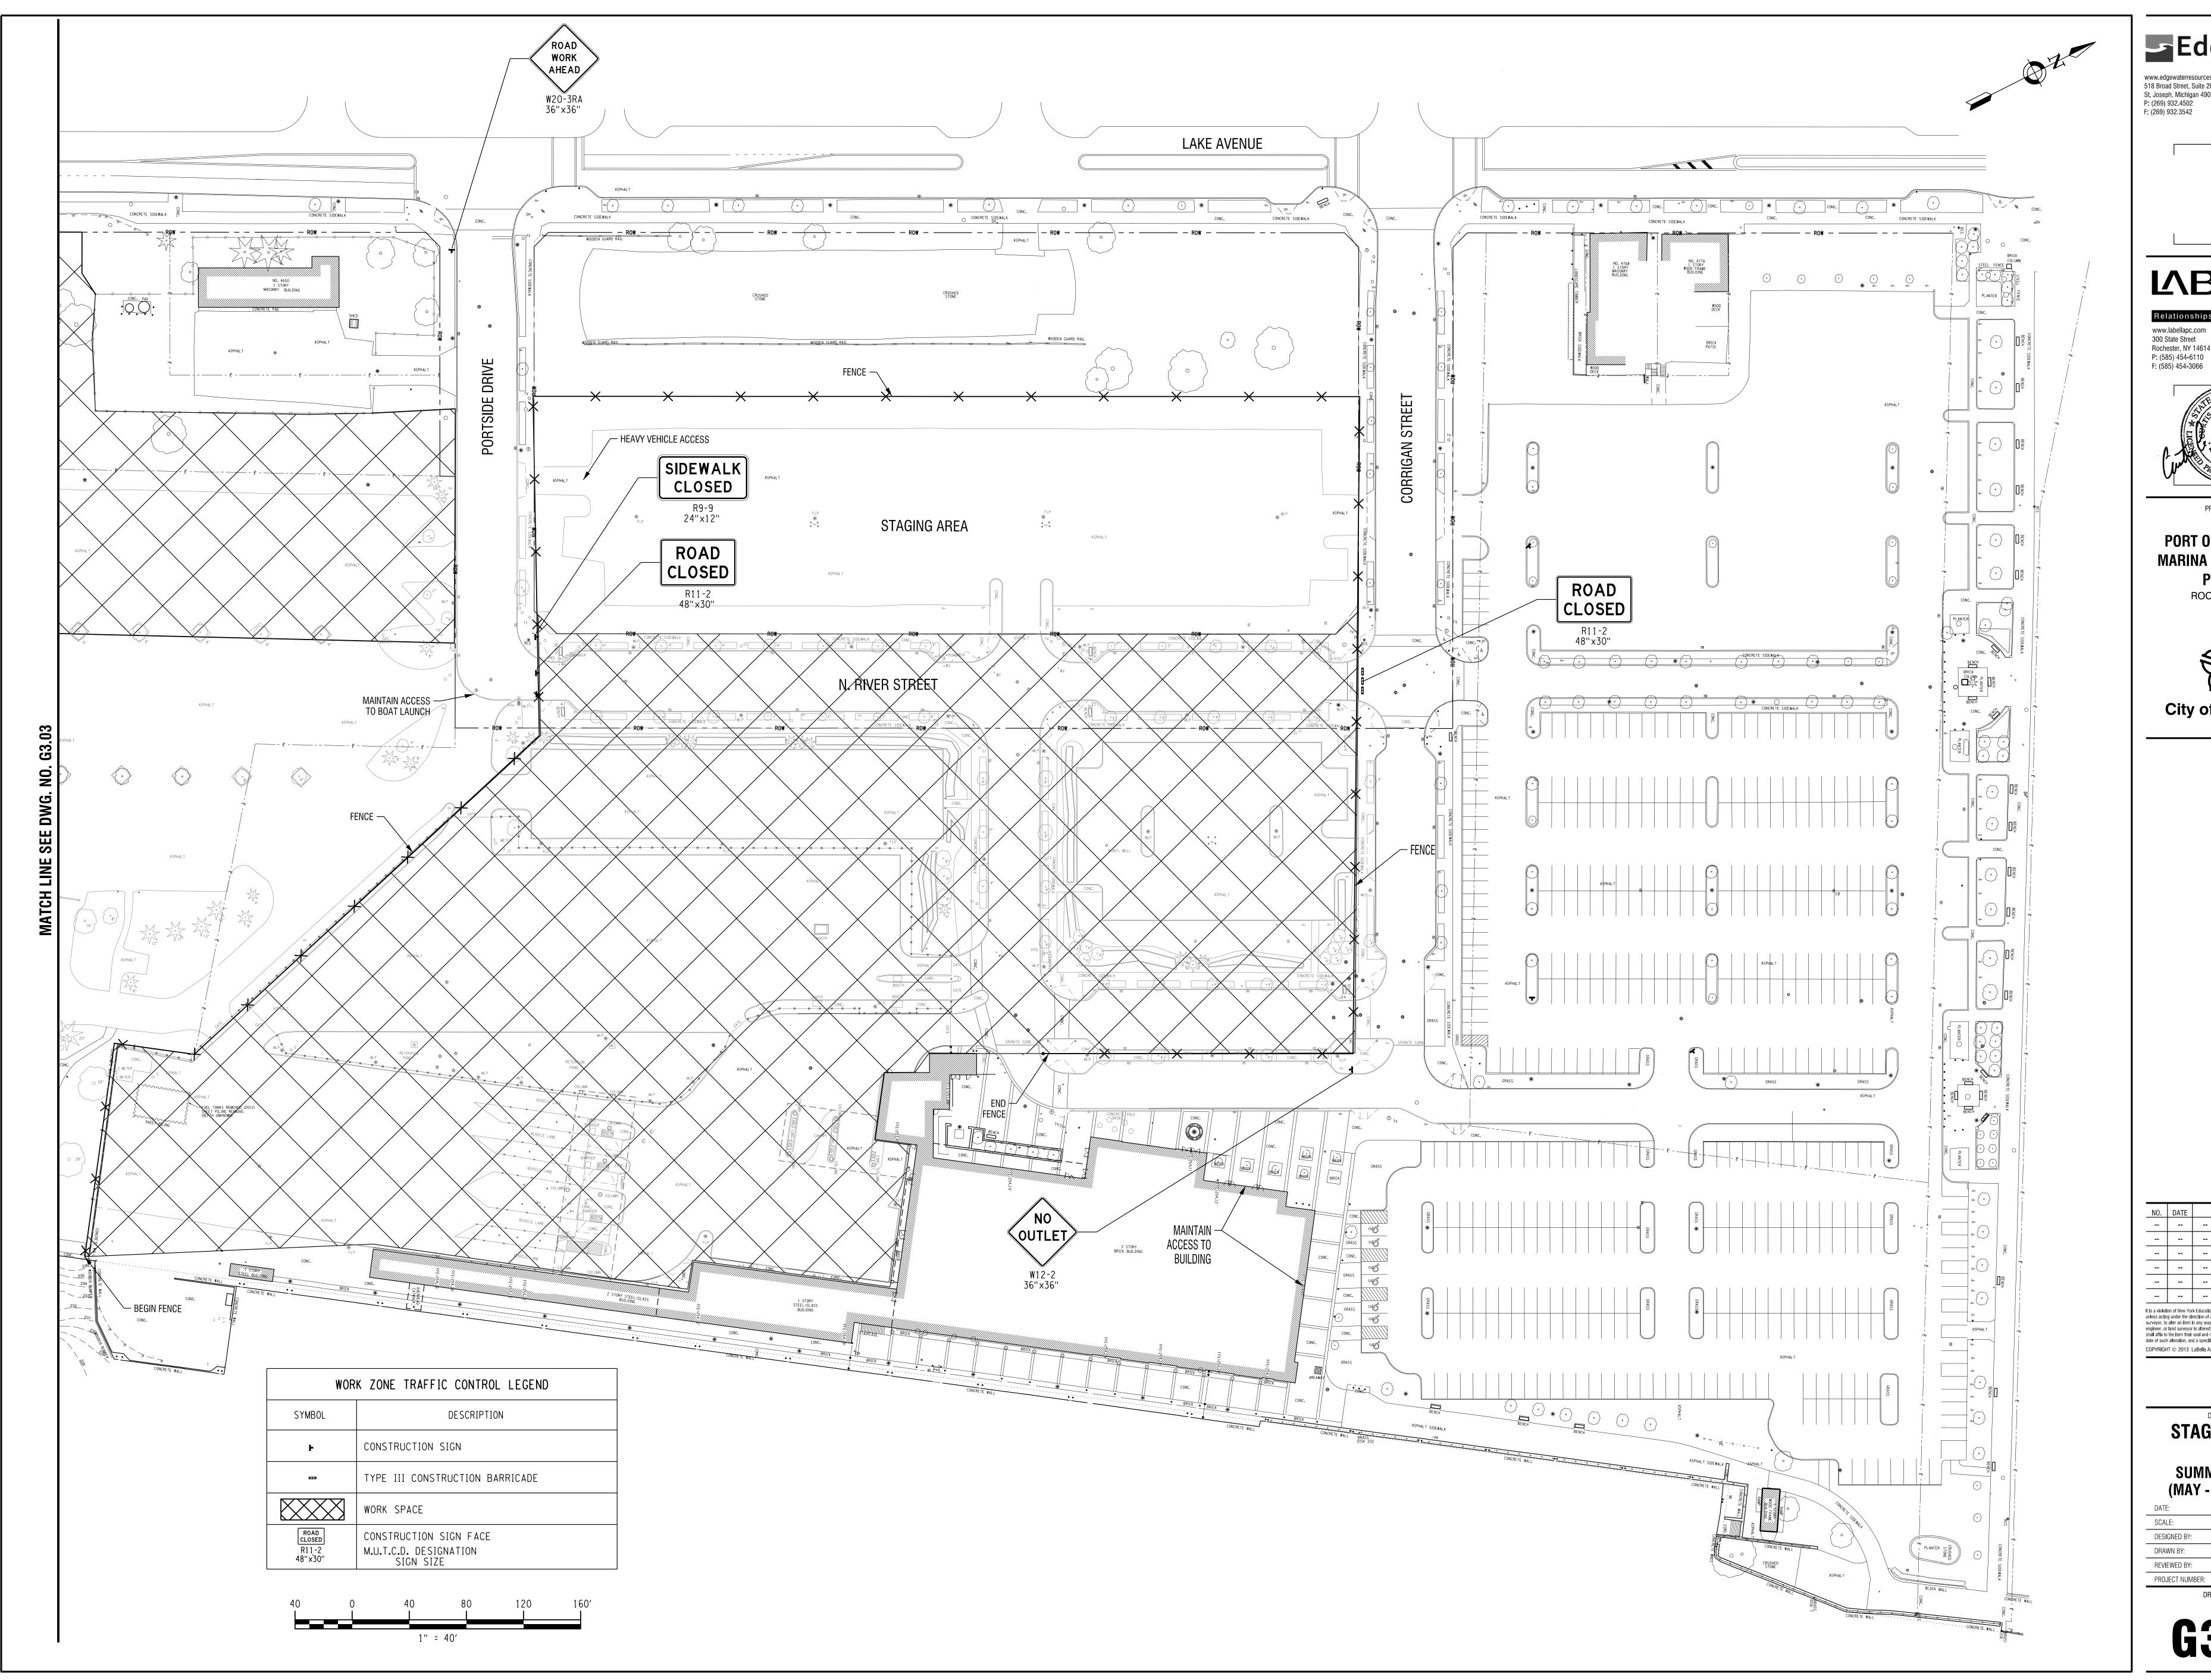

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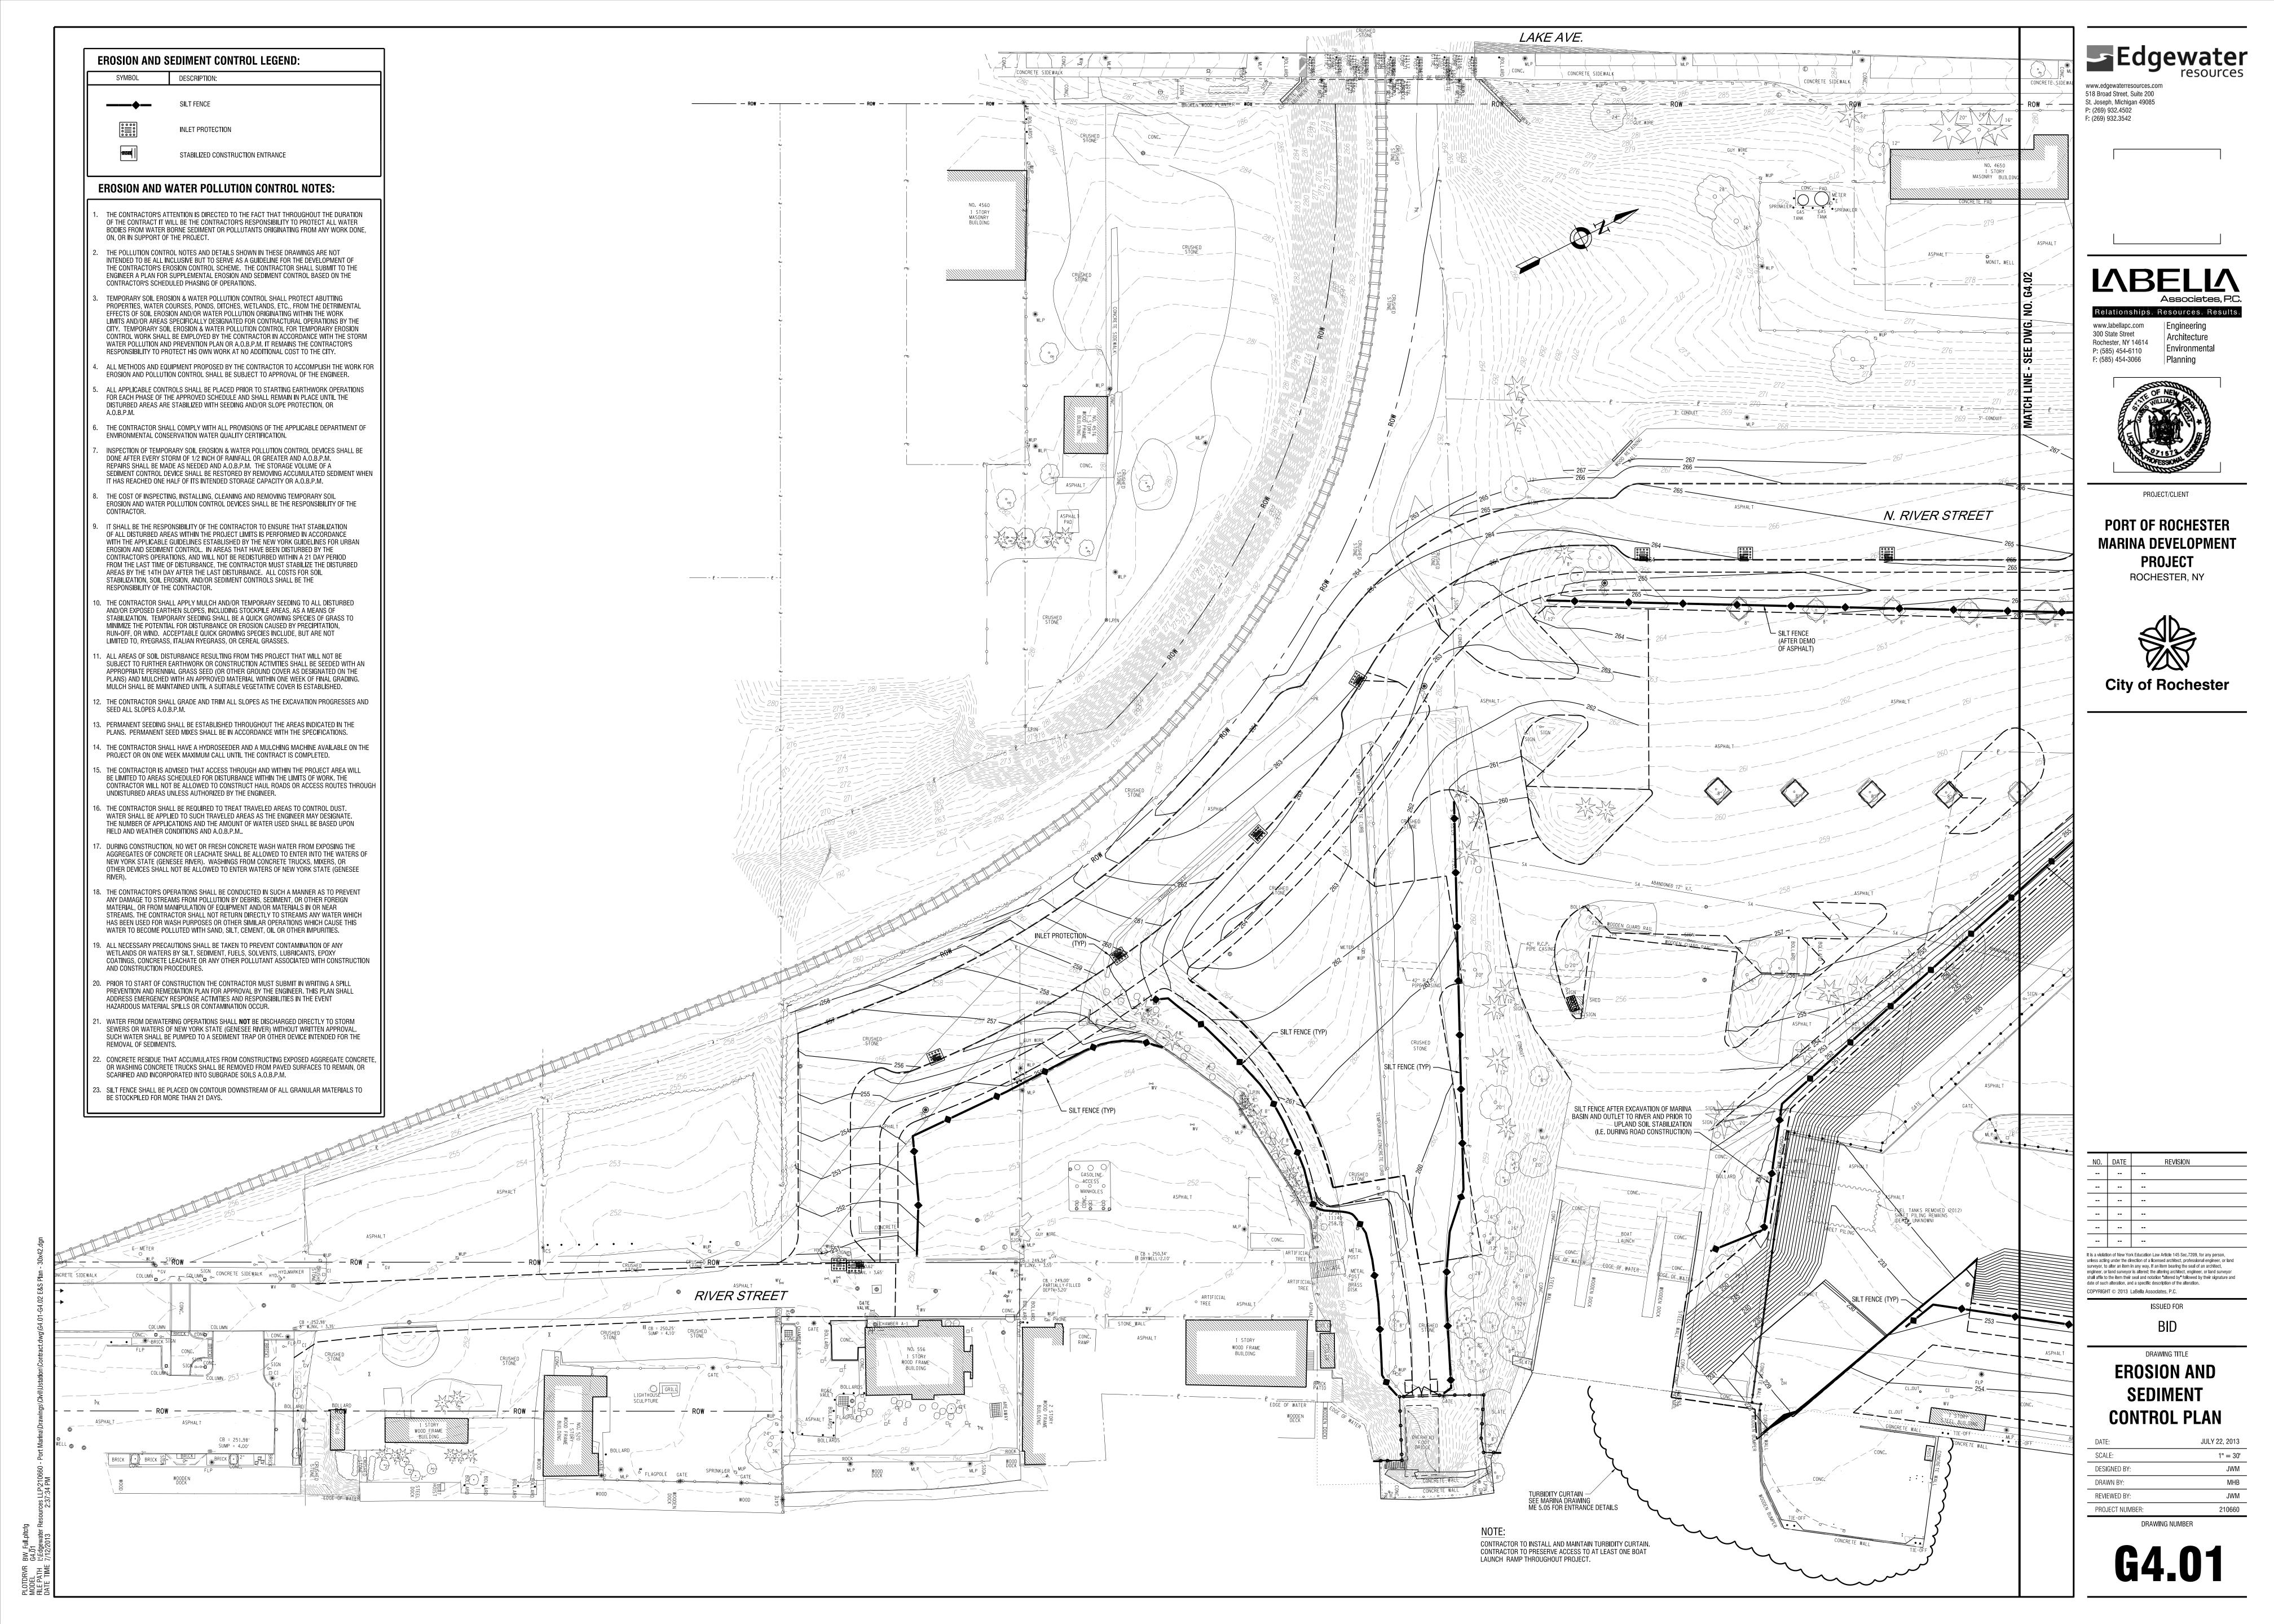
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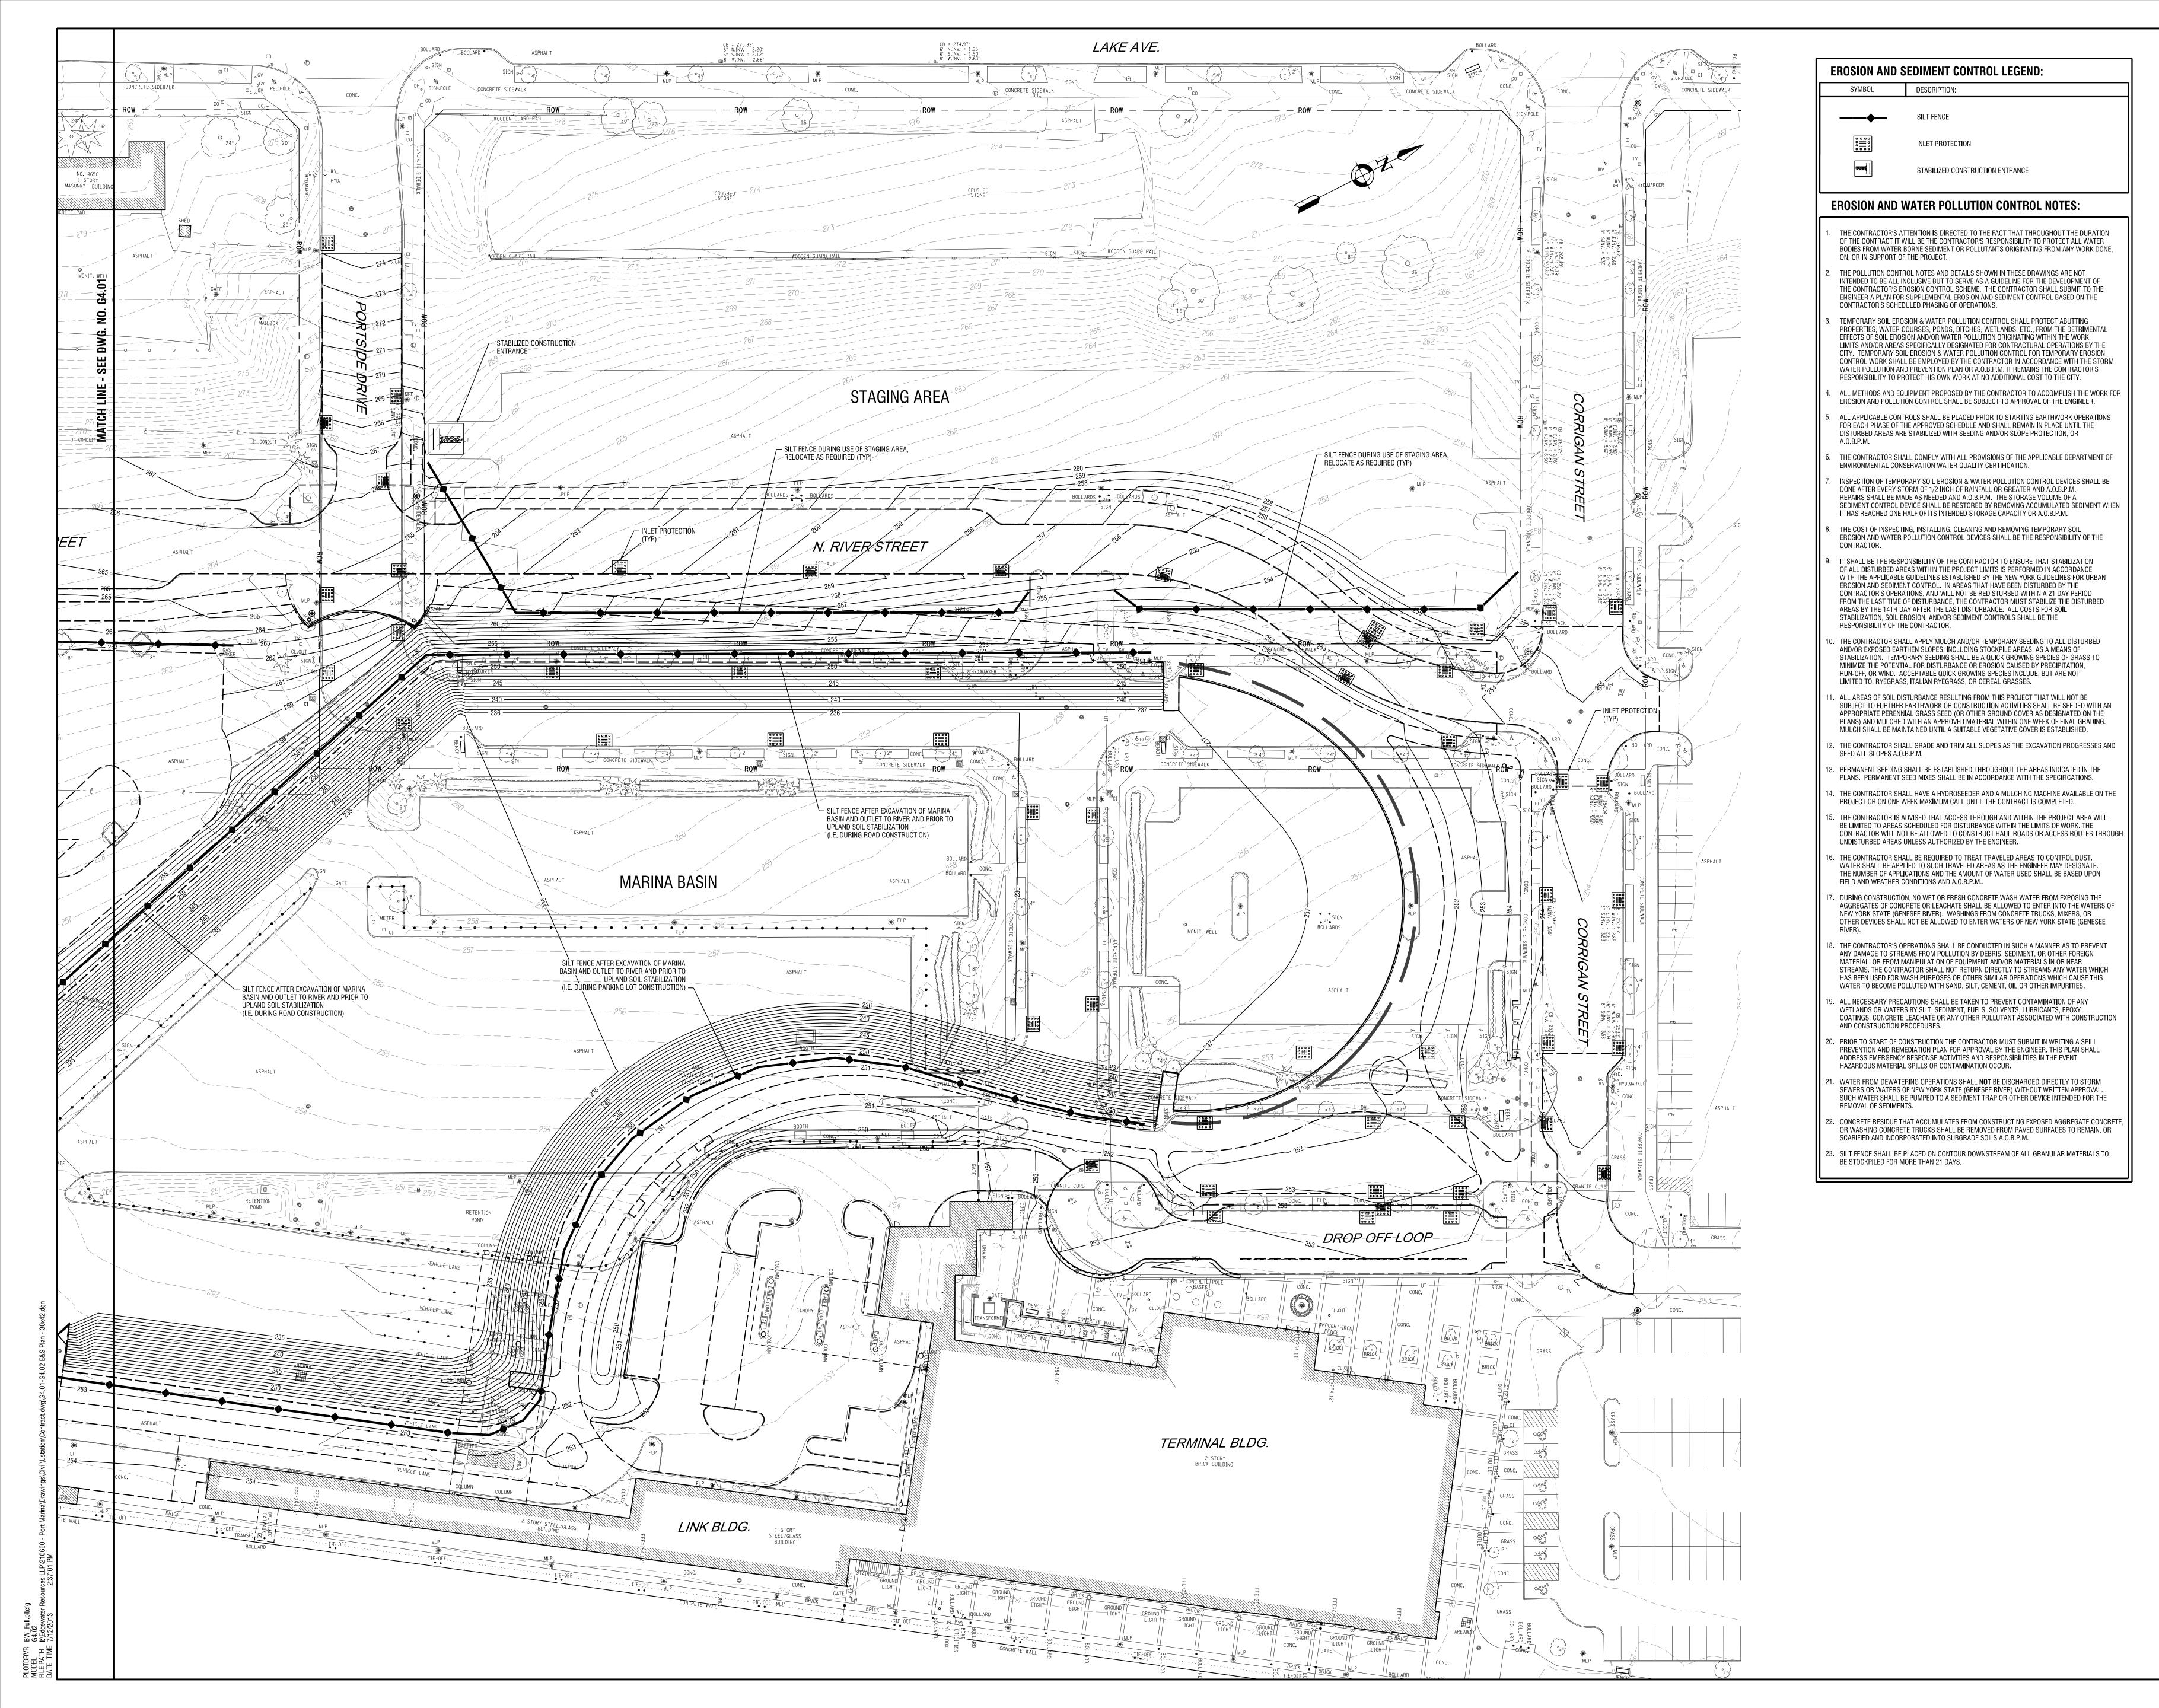


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STAGING/MPOT PLAN SUMMER SEASON (MAY - SEPTEMBER)

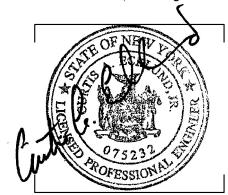G3.04





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EROSION AND
SEDIMENT
CONTROL PLAN

 DATE:
 JULY 22, 2013

 SCALE:
 1" = 30'


 DESIGNED BY:
 JWM


 DRAWN BY:
 MHB


 REVIEWED BY:
 JWM

 PROJECT NUMBER:
 210660

G4.02

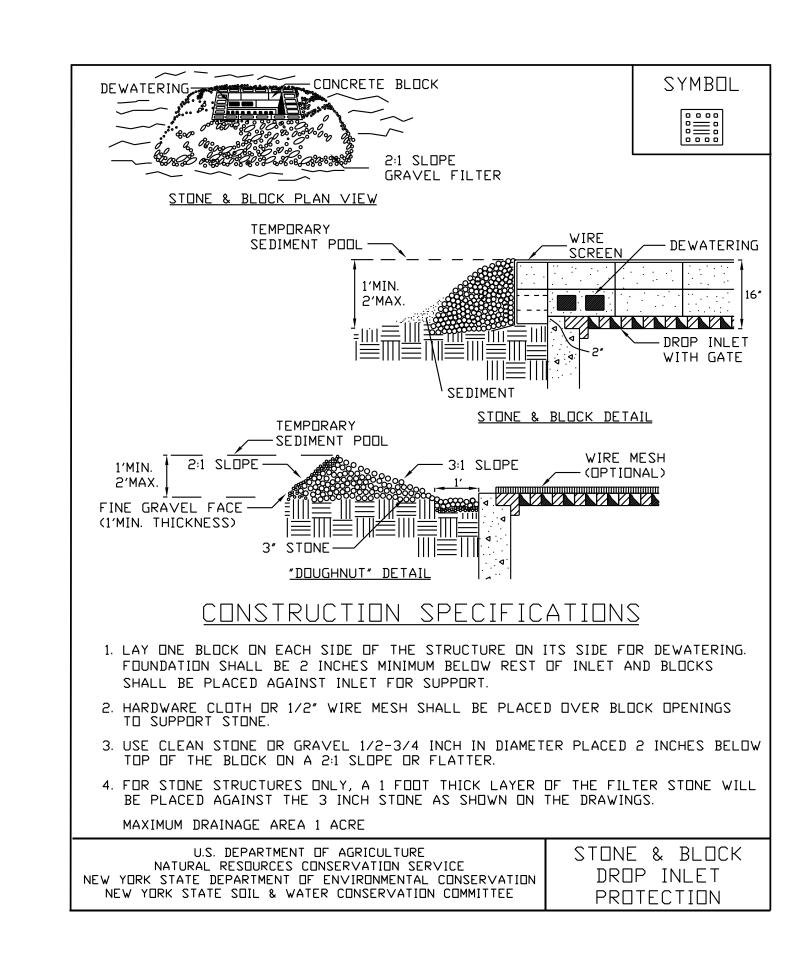

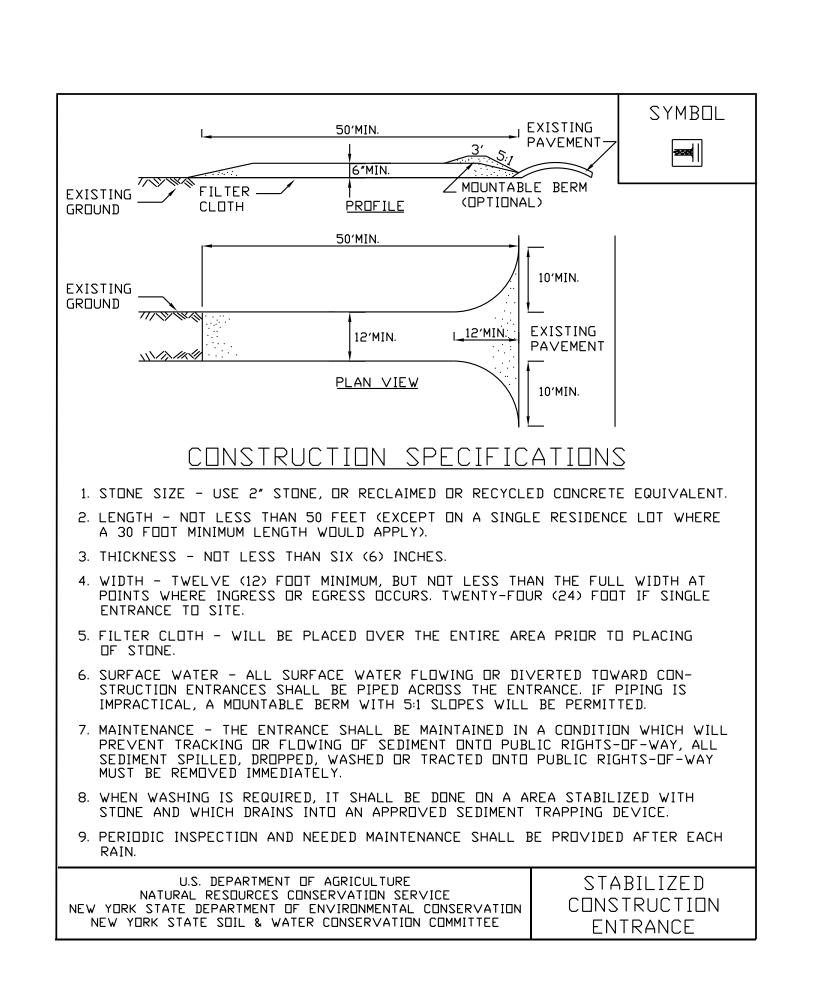

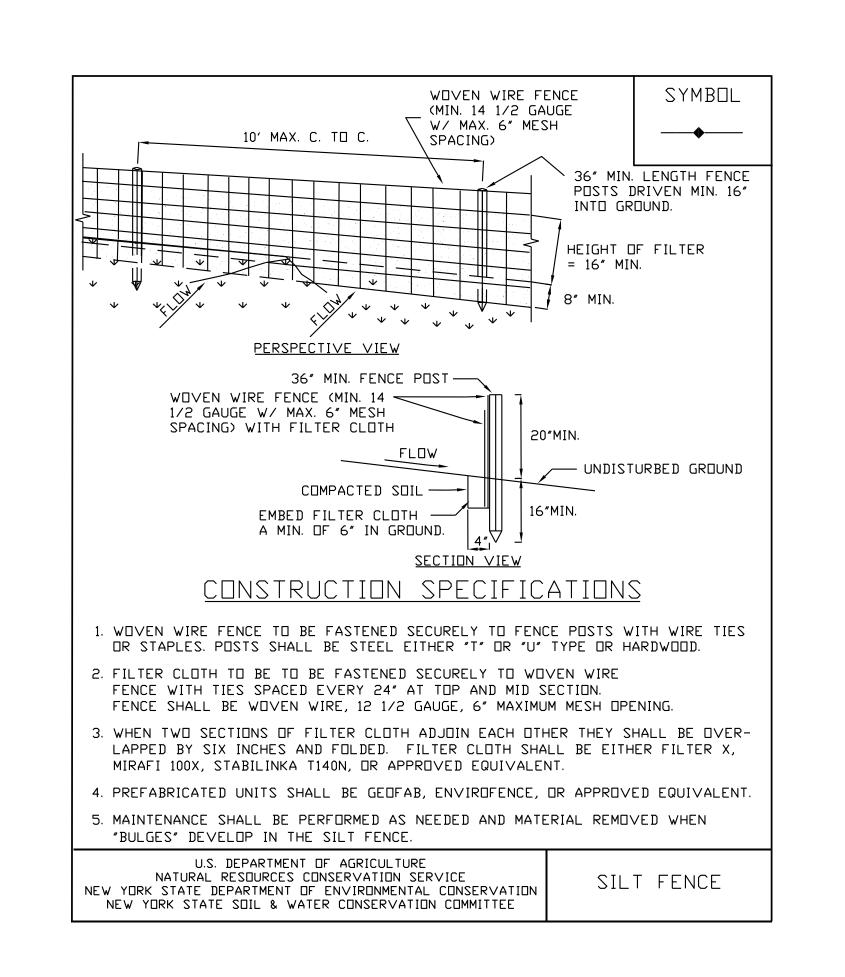



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EROSION AND
SEDIMENT
CONTROL DETAILS

DATE: JULY 22, 2013

SCALE: NTS

DESIGNED BY: MHB


DRAWN BY: MHB

REVIEWED BY: JWM

PROJECT NUMBER: 210660

**G4 03** 

DRAWING NUMBER

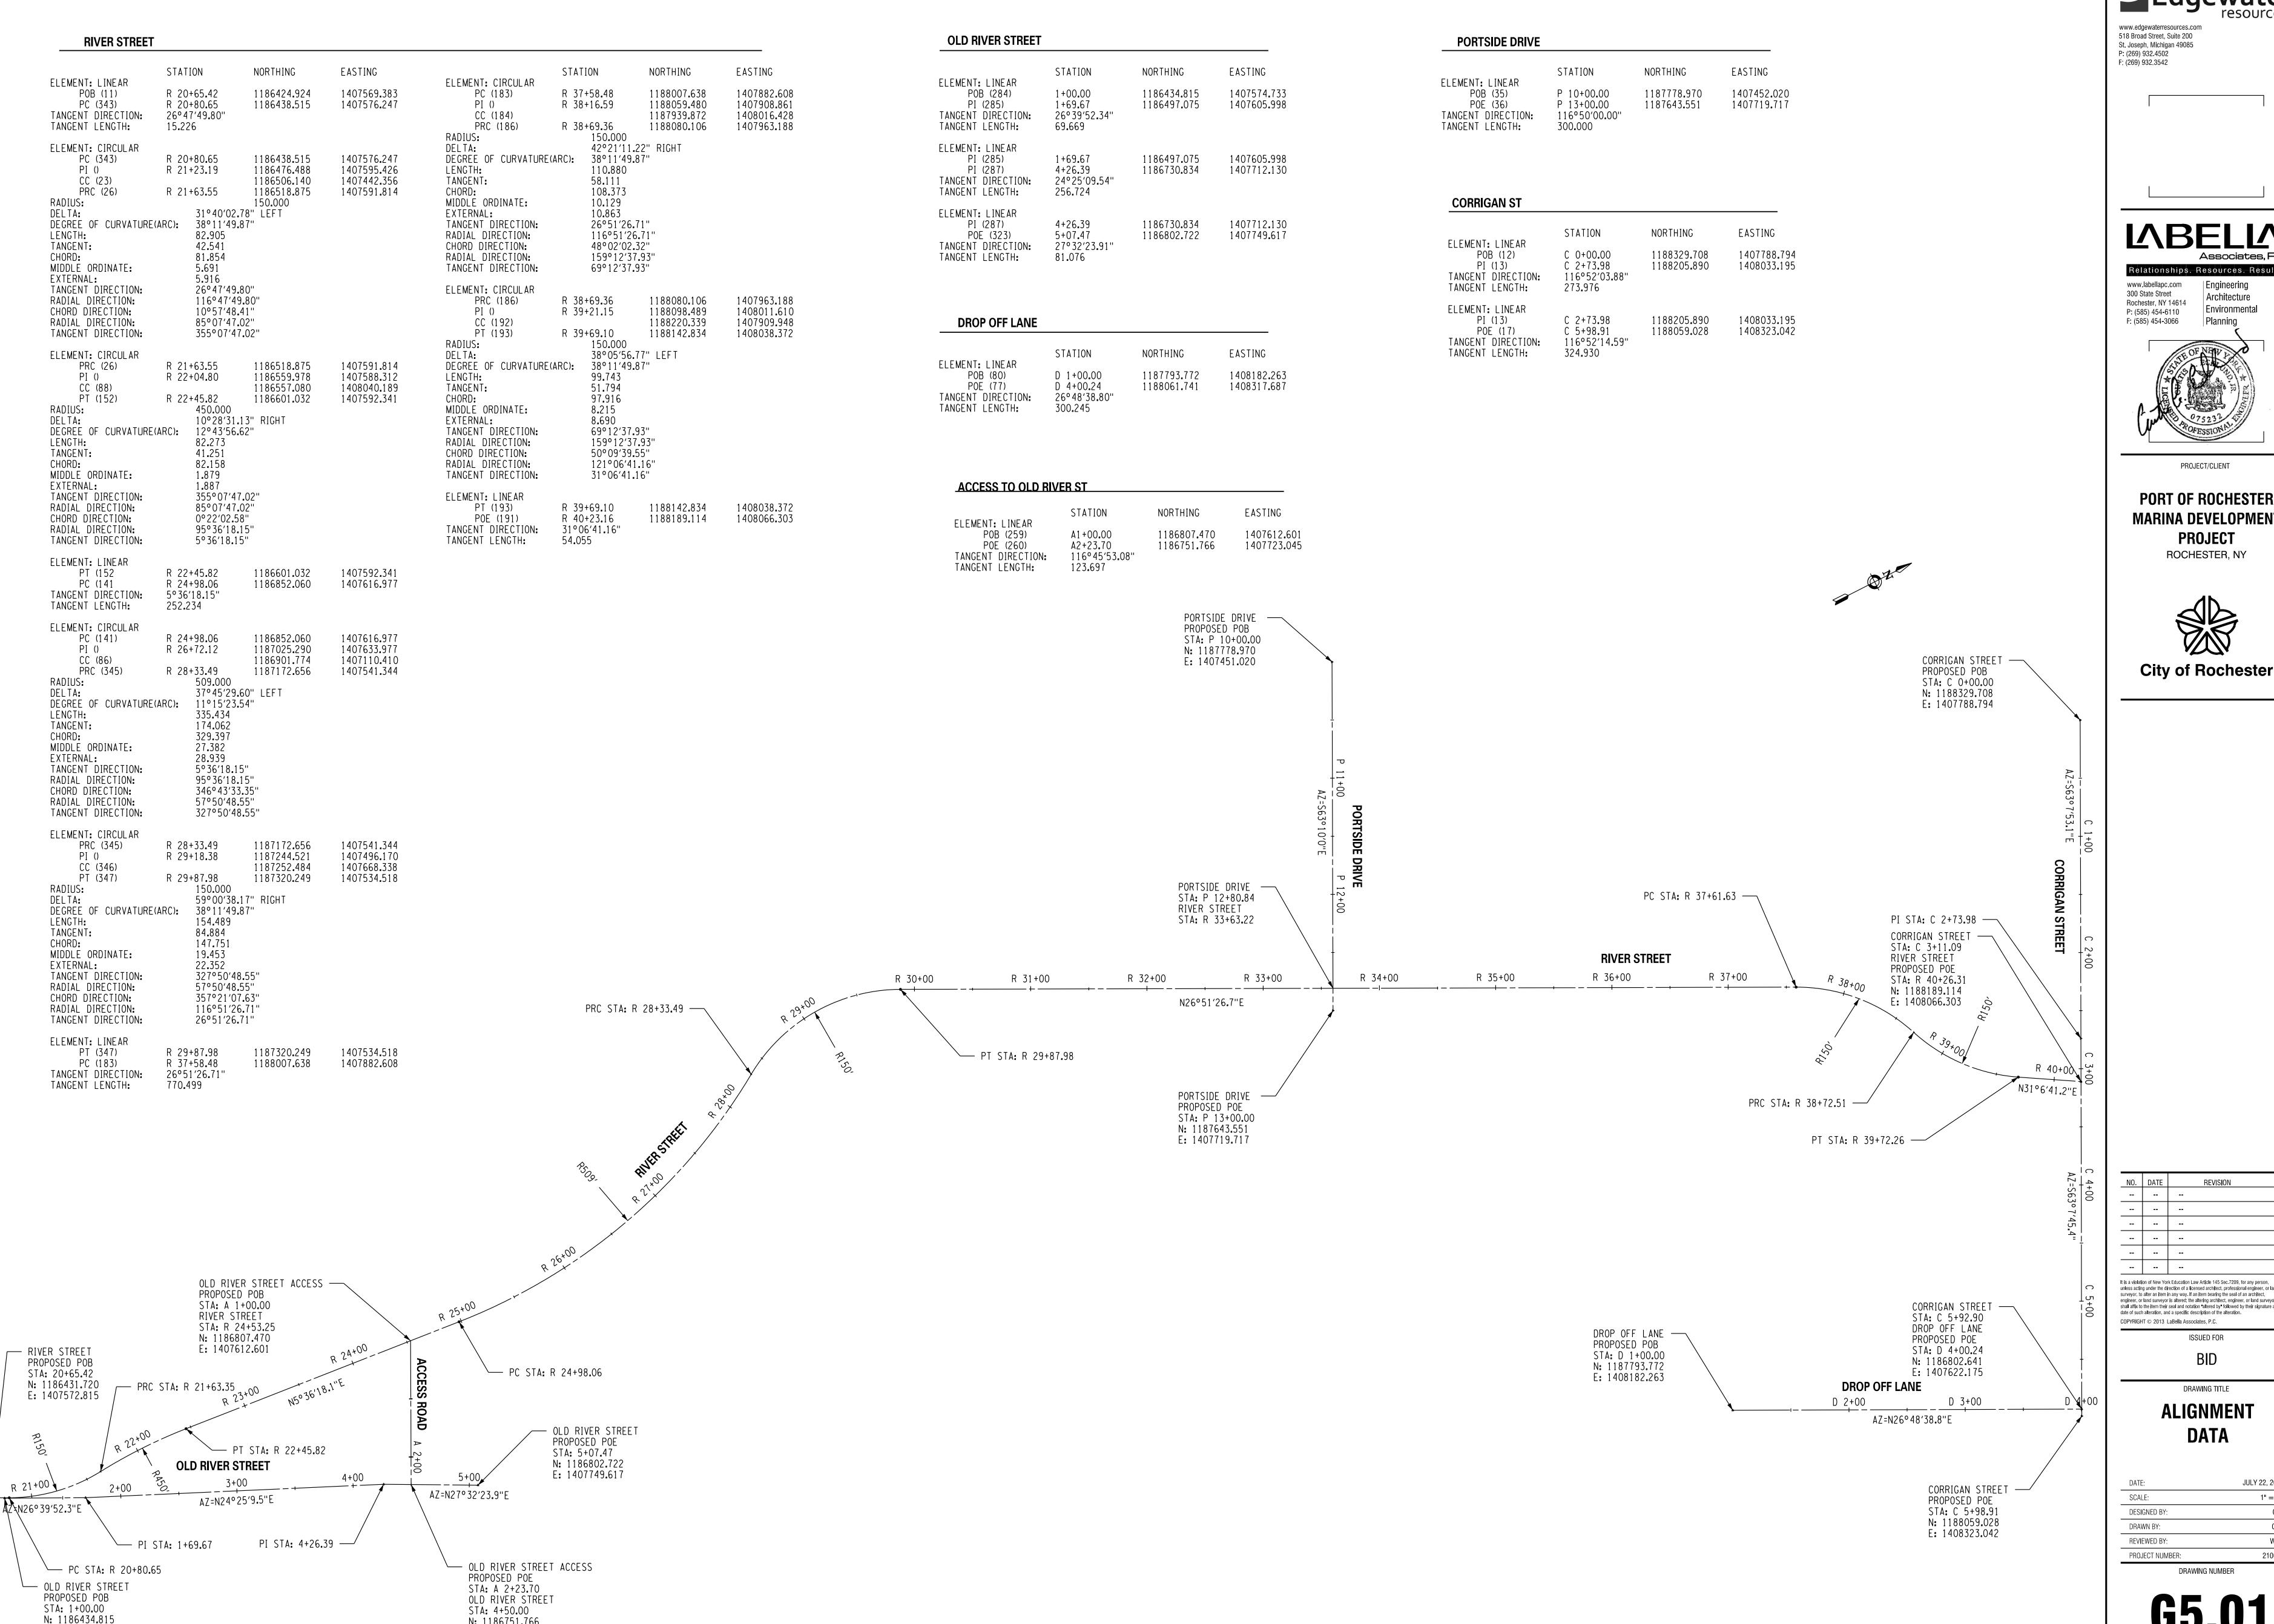

N: 1186751.766

E: 1407723.045

E: 1407574.733


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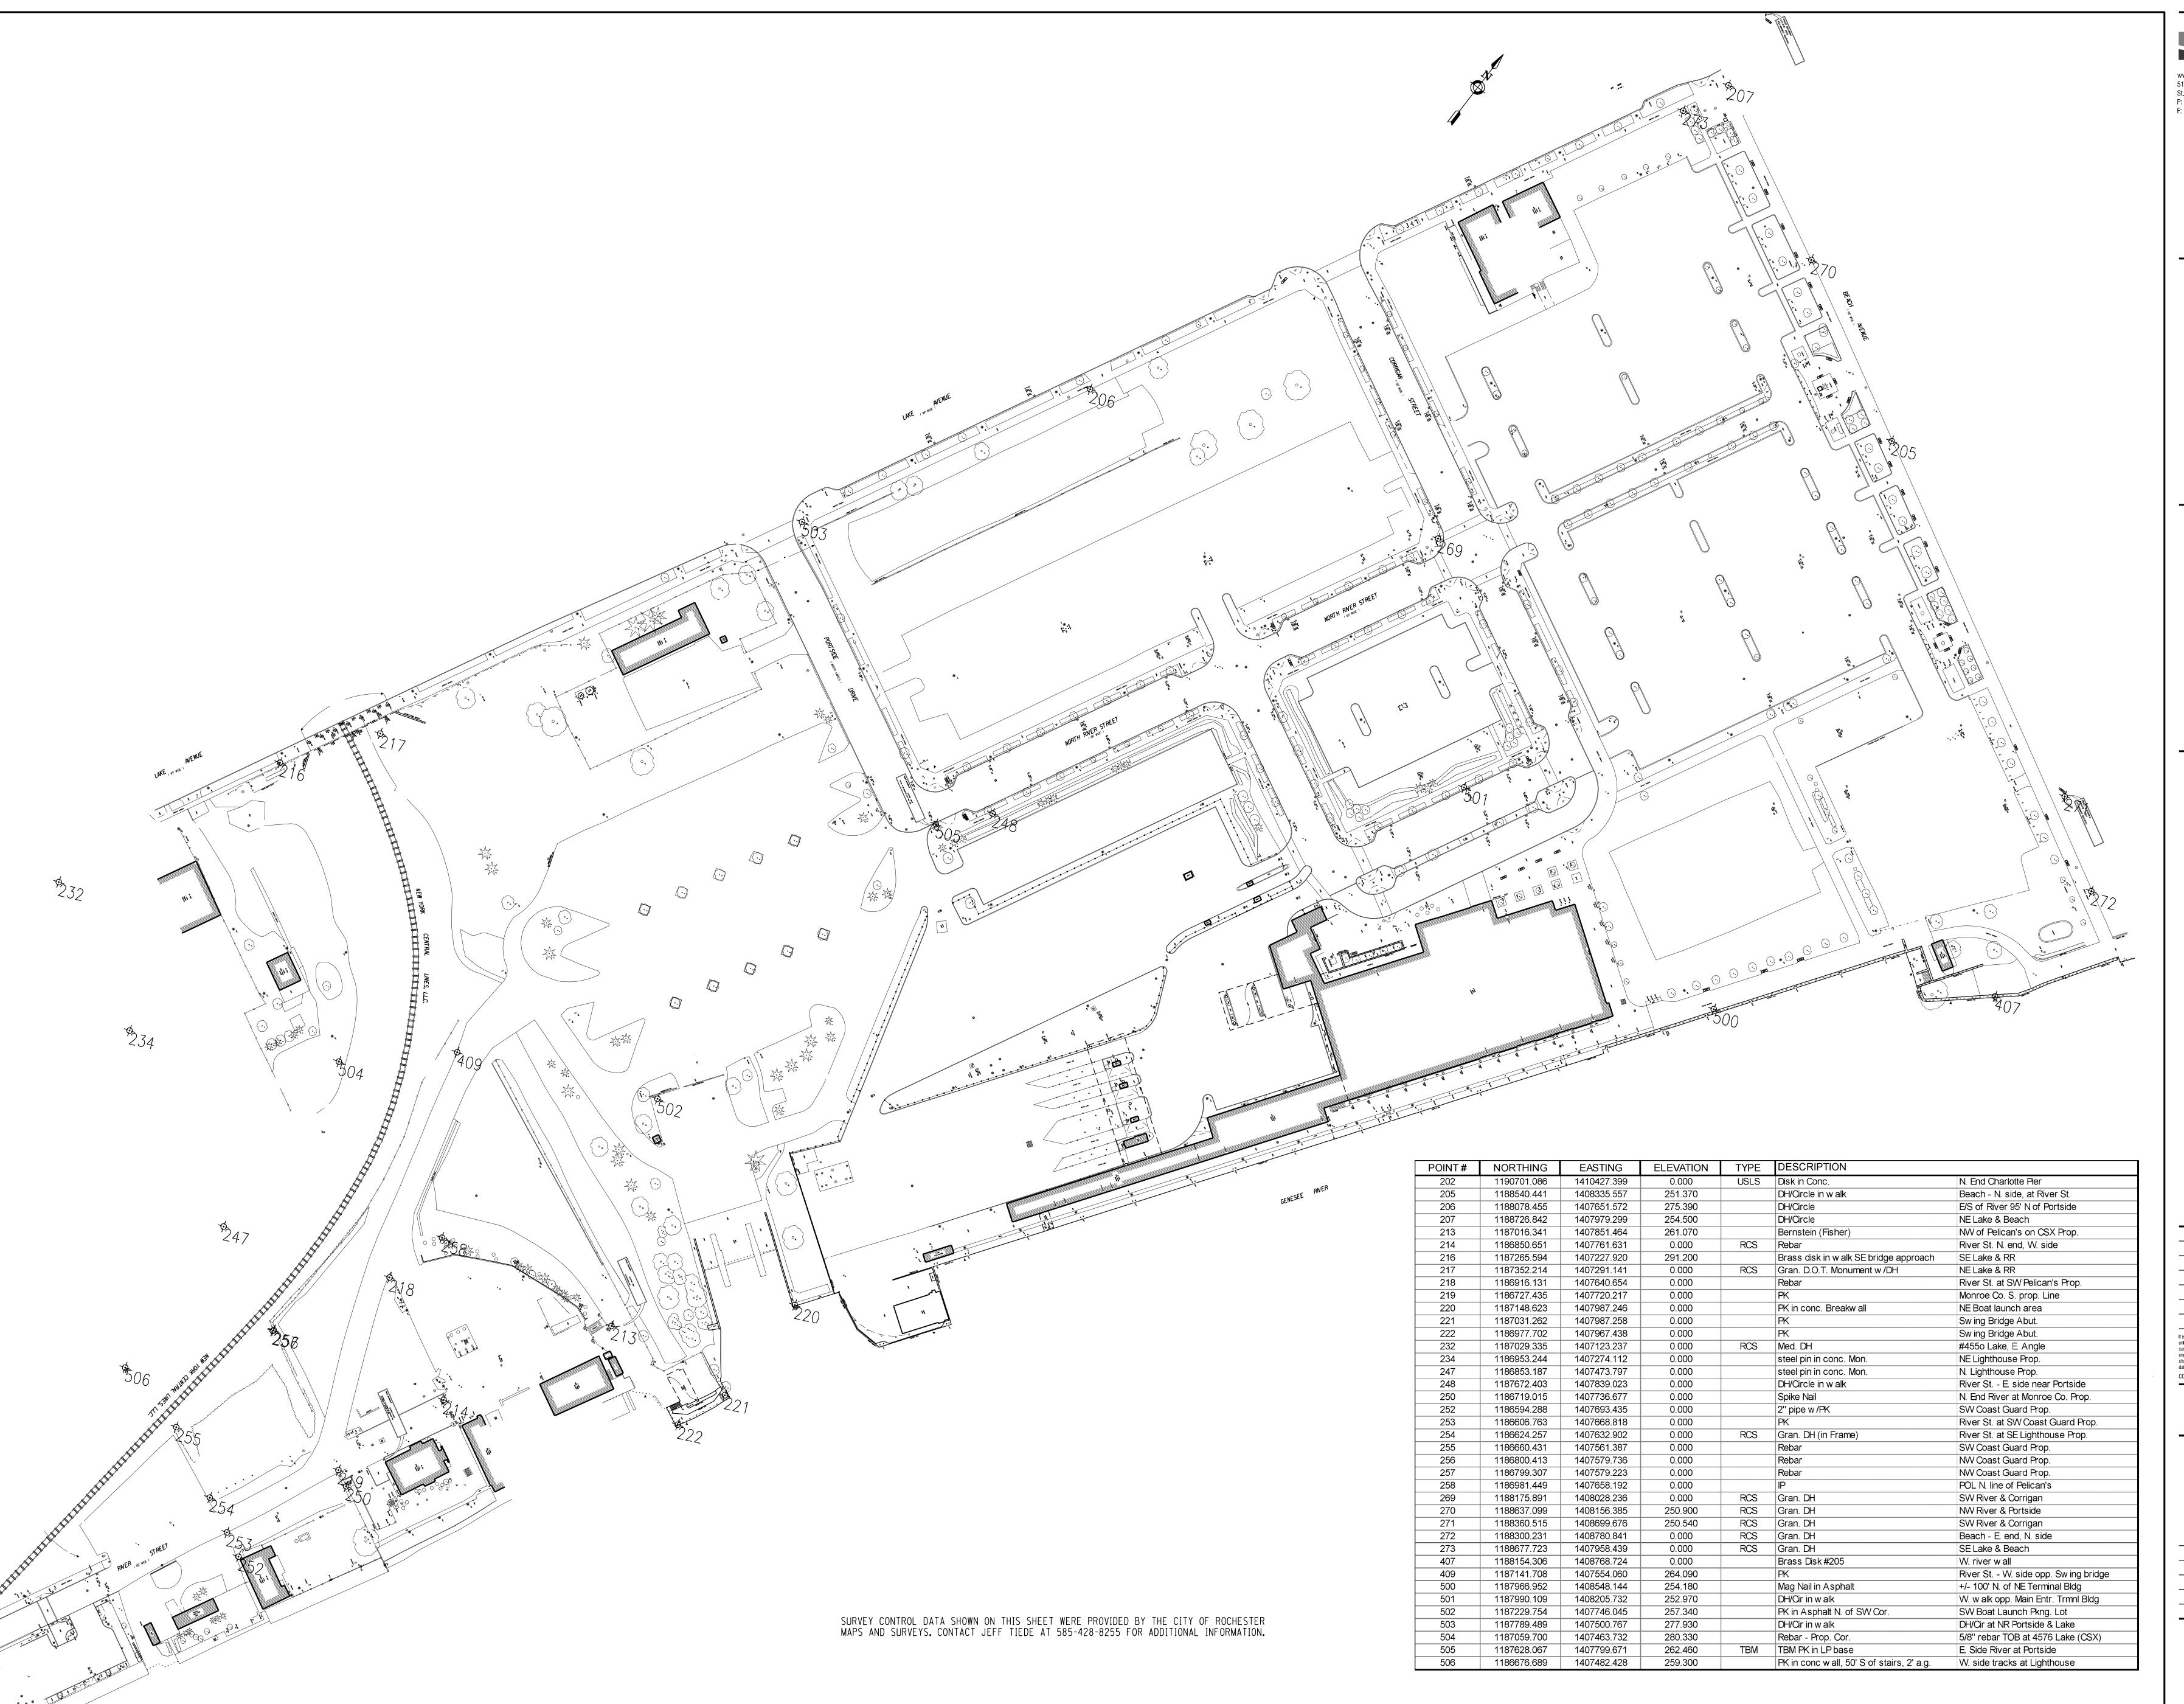
REVISION -- | -- |

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**ALIGNMENT** DATA

JULY 22, 2013 1" = 50'DESIGNED BY: REVIEWED BY: PROJECT NUMBER: DRAWING NUMBER



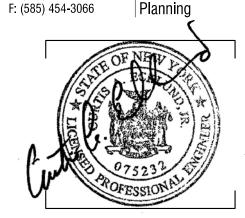

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NO.	DATE	REVISION	

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### **SURVEY CONTROL**

DATE:	JULY 22, 2013	
SCALE:	1" = 60'	
DESIGNED BY:		
DRAWN BY:	HS	
REVIEWED BY:	WDD	
PROJECT NUMBER:	210660	
DRAWING NUMBER		

G5.02

### **GENERAL NOTES:** 1. THE CONTRACTOR SHALL LOCATE, MARK, SAFEGUARD AND PRESERVE ALL SURVEY COUNTY GEODETIC SURVEY OFFICE. EROSION CONTROL DEVICES SHALL BE ESTABLISHED PRIOR COMMENCING EARTHWORK. MAINTAIN EROSION CONTROL DEVICES UNTIL UPSTREAM GROUND COVER HAS BEEN ESTABLISHED AND REMOVAL IS APPROVED IN WRITING BY THE CITY OF ROCHESTER OR THE ENVIRONMENTAL MONITOR. REPLACEMENT AT MAXIMUM INTERVALS OF ONE MONTH, REPLACEMENT WILL BE AS DIRECTED BY THE CITY OF ROCHESTER AND/OR THE ENVIRONMENTAL MONITOR. PERIOD OF CONSTRUCTION.

- CONTROL MONUMENTS AND RIGHT-OF-WAY MONUMENTS IN THE AREAS OF CONSTRUCTION. FOR DESCRIPTIVE AND SURVEY DATA ON CONTROL MONUMENTS, CALL THE MONROE
- 3. THE CONTRACTOR SHALL BE RESPONSIBLE FOR REPLACING ANY STRAW BALES THAT BECOME CLOGGED, INOPERABLE, OR DAMAGED. STRAW BALES SHALL BE INSPECTED FOR
- DRAINAGE ALONG EXISTING STREETS SHALL BE MAINTAINED THROUGHOUT THE
- THE CONTRACTOR SHALL TAKE CARE TO NOT ALLOW SILT RUNOFF INTO THE ADJOINING PROPERTIES. EFFORTS MAY INCLUDE THE USE, OF INTERCEPTOR SWALES, STRAW BALES AND CRUSHED STONE FILTERS. THE CONTRACTOR IS RESPONSIBLE FOR CLEANING OF THE ADJACENT STREETS (I.E., STREET SWEEPING) AND DOWNSTREAM AREAS AND FOR KEEPING DESILTATION BASINS CLEAN OF SILT.
- DISTURBED SLOPES GREATER THAN 3:1 SHALL BE SEEDED IMMEDIATELY UPON COMPLETION OF FINAL GRADING.
- CONTRACTOR SHALL PERFORM WORK IN ACCORDANCE WITH RECOMMENDATIONS CONTAINED IN THE NYSDEC PUBLICATION "REDUCING THE IMPACTS OF STORM WATER RUNOFF FROM NEW DEVELOPMENT" AND PER GUIDELINES CONTAINED IN THE NYSDEC GENERAL PERMIT FOR CONSTRUCTION ACTIVITIES. FINAL DESIGN OF EACH SECTION SHALL BE COMPLETED PER THESE GUIDELINES AND RECOMMENDATIONS. INCLUDING PROVIDING NECESSARY CONSTRUCTION DETAILS AND NOTES, AND A COMPLETE MAINTENANCE SCHEDULE OF EROSION CONTROL FEATURES.
- 8. THE CONTRACTOR SHALL PROVIDE THE FOLLOWING EROSION CONTROL MEASURES IN THE ORDER SHOWN:
- A. STABILIZE CONSTRUCTION ENTRANCE B. PROVIDE SILT- FENCE ALONG PERIMETER AREAS & SWALES
- C. PROVIDE SILT FENCE AROUND TOPSOIL STOCKPILE AREAS D. PROVIDE STRAW BALES OR APPROVED ALTERNATE AROUND EXISTING STORM INLETS THAT MAY BE AFFECTED BY CONSTRUCTION.
- 9. DISTURBED VEGETATED AREAS WHERE CONSTRUCTION ACTIVITIES CEASE FOR 21 DAYS SHALL BE TEMPORARILY SEEDED WITH AN ANNUAL RYE GROSS AND MULCHED IF NECESSARY NOT LATER THAN 7 DAYS FROM THE LAST CONSTRUCTION ACTIVITY IN
- 10. ALL EXISTING MONITORING WELLS ARE TO BE PROTECTED WITH PLACEMENT OF ONE OR MORE JERSEY BARRIERS ADJACENT TO WELL AND BETWEEN WORK AREA AND THE WELL. JERSEY BARRIER SHALL EXTEND AT LEAST 3 FT BEYOND WELL ON EACH SIDE. [NOTE: 3-4 ADDITIONAL WELLS, NOT SHOWN, MAY ALSO BE PRESENT AT THE TIME OF WORK AND WILL REQUIRE SAME PROTECTION AS PART OF CONTRACT (BASE BID)]. IN

THE EVENT A WELL IS DAMAGED, CONTRACTOR SHALL REPLACE WELL AT ITS OWN COST.

- 11. PROPOSED MONITORING WELL SITES ARE APPROXIMATE. EXCLUSION BOUNDARY MAY NEED TO BE ADJUSTED ACCORDINGLY TO ENCOMPASS WELL LOCATIONS.
- 12. CONTRACTOR SHALL NOT UTILIZE COLFAX STREET FOR HAULING MATERIALS TO 1655 LEXINGTON AVENUE. CONTRACTOR SHALL NOT USE MCCRACKANVILLE STREET FOR HAULING DURING THE FOLLOWING TIMES: MON - FRI: 6:30AM - 7:00AM MON, TUES, THURS, FRI: 1:30PM - 2:00PM
- 13. CONTRACTOR SHALL PROVIDE ALL SNOW REMOVAL NECESSARY TO MAINTAIN 1655 LEXINGTON AVENUE PARCEL THROUGHOUT DURATION OF PROJECT.

14. CONTRACTOR SHALL PROVIDE ALL EQUIPMENT, MATERIALS, AND LABOR TO

WEDS: 12:30PM - 1:15PM


- CONTROL DUST AS REQUIRED IN THE ENVIRONMENTAL MANAGEMENT PLAN AND AS DIRECTED BY CITY OF ROCHESTER OR THE ENVIRONMENTAL MONITOR. CONTRACTOR SHOULD NOTE THAT ENVIRONMENTAL MONITOR WILL MONITOR DUST, AND ACTION LEVELS IN EMP WILL DICTATE DUST CONTROL.
- 15. CONTRACTOR SHALL RESTORE ALL VEGETATED AREAS DISTURBED DURING PROJECT AND NOT COVERED BY SLAG MATERIAL. VEGETATION AND LANDFILL COVER REQUIRES A MINIMUM 2 FT OF SOIL AND HYDROSEED AREA. CONTRACTOR RESPONSIBLE TO MAINTAIN RESTORED AREAS UNTIL 80% VEGETATIVE COVER ESTABLISHED.
- 16. HAUL ROAD TO BE BUILT AS SHOWN AND MAINTAINED THROUGHOUT PROJECT DURATION BY CONTRACTOR. ADDITIONAL HAUL ROADS TO BE BUILT AS NEEDED TO SUPPORT PROJECT. HAUL ROADS REQUIRED WHERE ANY RUTTING INTO THE LANDFILL COVER IS OBSERVED. CONTRACTOR SHALL RESTORE ANY DISTURBANCE TO THE LANDFILL COVER/CAP IMMEDIATELY AND AS REQUIRED BY NYSDEC, CITY OF ROCHESTER OR THE ENVIRONMENTAL MONITOR.

### **CONSTRUCTION ENTRANCE NOTES:**

- 1. MODIFICATIONS MAY BE REQUIRED TO MATCH FIELD CONDITIONS.
- A 30' WASH AREA SHALL BE PROVIDED, ADDITIONAL GRADING MAY BE REQUIRED TO PROVIDE WASHING AREAS.
- THE CONTRACTOR SHALL GRADE TO PREPARE AND SMOOTH ORIGINAL GROUND FOR PLACEMENT OF 6" OF #3 CRUSHED STONE OR GRAVEL ENTRANCE MATERIAL UP TO THE EDGE OF PAVEMENT.
- PERIODIC MAINTENANCE MAY BE REQUIRED AND COST OF THIS MAINTENANCE WILL BE INCLUDED IN PRICE BID.


### **MONITORING WELL SYMBOL LEGEND**


### EXISTING MONITORING WELL

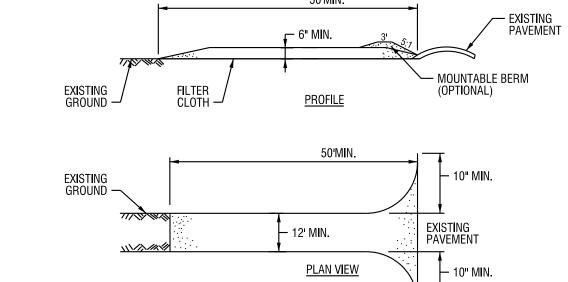

- 1. STONE SIZE USE 2" STONE, OR RECLAIMED OR RECYCLED CONCRETE EQUIVALENT. 2. LENGTH - NOT LESS THAN 50 FEET (EXCEPT ON A SINGLE RESIDENCE LOT WHERE A 30 FOOT MINIMUM LENGTH WOULD APPLY).
- 3. THICKNESS NOT LESS THAN SIX (6) INCHES.
- WIDTH TWELVE (12) FOOT MINIMUM, BUT NOT LESS THAN THE FULL WIDTH AT POINTS WHERE INGRESS OR EGRESS OCCURS. TWENTY-FOUR (24) FOOT IF SINGLE
- 5. FILTER CLOTH WILL BE PLACED OVER THE ENTIRE AREA PRIOR TO PLACING OF
- 6. SURFACE WATER ALL SURFACE WATER FLOWING OR DIVERTED TOWARD CONSTRUCTION ENTRANCES SHALL BE PIPED ACROSS THE ENTRANCE. IF PIPING IS
- IMPRACTICAL, A MOUNTABLE BERM WITH 5:1 SLOPES WILL BE PERMITTED. MAINTENANCE - THE ENTRANCE SHALL BE MAINTAINED IN A CONDITION WHICH WILL PREVENT TRACKING OR FLOWING OF SEDIMENT ONTO PUBLIC RIGHTS-OF-WAY, ALL SEDIMENT SPILLED, DROPPED, WASHED OR TRACTED ONTO PUBLIC RIGHTS-OF-WAY
- 8. WHEN WASHING IS REQUIRED, IT SHALL BE DONE ON A AREA STABILIZED WITH STONE AND WHICH DRAINS INTO AN APPROVED SEDIMENT TRAPPING DEVICE.
- 9. PERIODIC INSPECTION AND NEEDED MAINTENANCE SHALL BE PROVIDED AFTER EACH

### STABILIZED CONSTRUCTION ENTRANCE

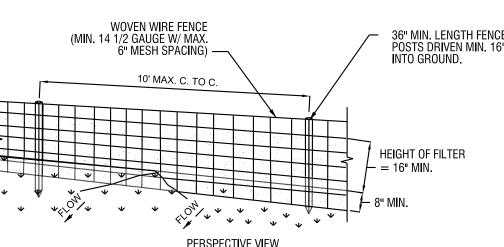


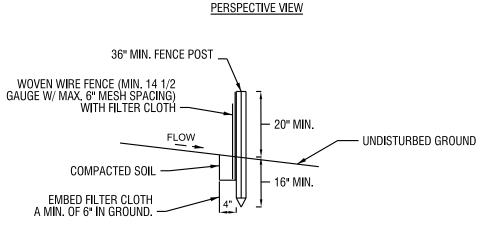




- WOVEN WIRE FENCE TO BE FASTENED SECURELY TO FENCE POSTS WITH WIRE TIES OR STAPLES. POSTS SHALL BE STEEL EITHER "T" OR "U" TYPE OR
- 2. FILTER CLOTH TO BE TO BE FASTENED SECURELY TO WOVEN WIRE FENCE WITH TIES SPACED EVERY 24" AT TOP AND MID SECTION. FENCE SHALL BE WOVEN WIRE, 12 1/2 GAUGE, 6" MAXIMUM MESH OPENING. WHEN TWO SECTIONS OF FILTER CLOTH ADJOIN EACH OTHER THEY SHALL BE OVERLAPPED BY SIX INCHES AND FOLDED. FILTER CLOTH SHALL BE EITHER FILTER X, MIRAFI 100X, STABILINKA T140N, OR APPROVED
- 4. PREFABRICATED UNITS SHALL BE GEOFAB, ENVIROFENCE, OR APPROVED
- MAINTENANCE SHALL BE PERFORMED AS NEEDED AND MATERIAL REMOVED WHEN "BULGES" DEVELOP IN THE SILT FENCE.

### SILT FENCE NOT TO SCALE

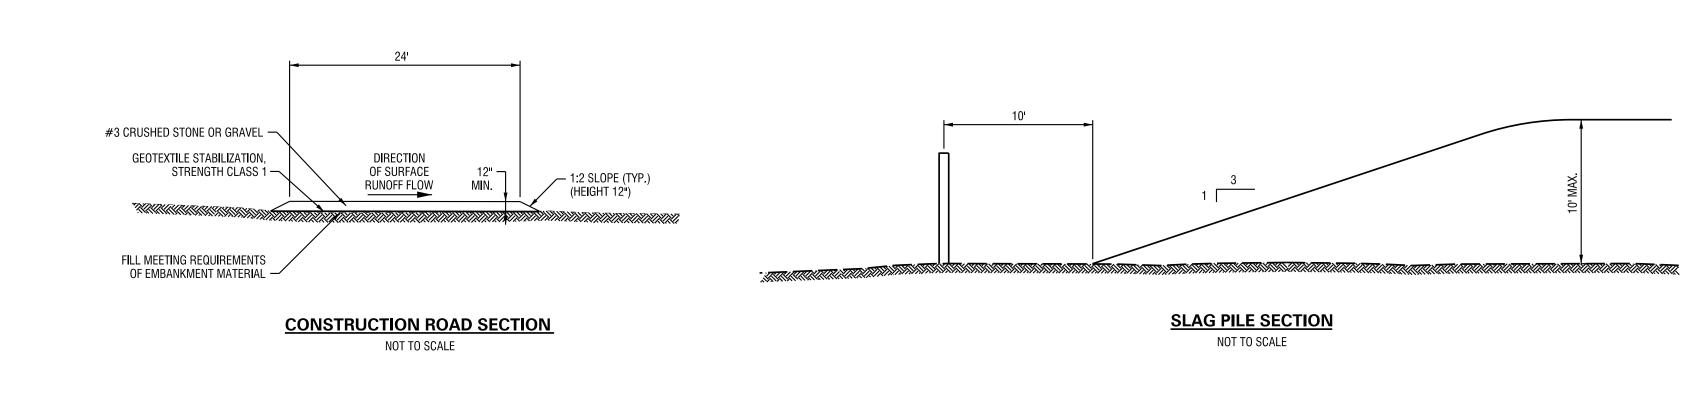

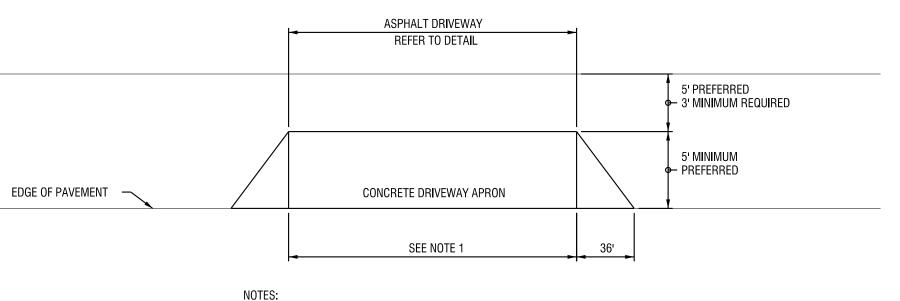

PER CITY DRIVEWAY MIX 3" 19 F9 BINDER COURSE HMA, 80 SERIES COMPACTION └─ 12" SUBBASE COURSE TYPE 2

- 1-1/2" ASPHALT TOP COURSE

1. DRIVEWAY WIDTH SHALL BE EQUAL TO THE EXISTING DRIVEWAY WIDTH T THE R.O.W. LINE. MINIMUM DRIVEWAY WIDTH FOR ALL DRIVEWAYS SHALL BE 10'-0". MAXIMUM WIDTH SHALL NOT EXCEED 15'-0" FOR RESIDENTIAL DRIVEWAYS OR 30'-0" FOR COMMERCIAL DRIVEWAYS.

2. SEE HEAVY DUTY ASPHALT DRIVEWAY SECTION.

**CURB CUT DETAIL** NOT TO SCALE

**HEAVY DUTY ASPHALT DRIVEWAY SECTION** NOT TO SCALE

PORT OF ROCHESTER **MARINA DEVELOPMENT PROJECT** ROCHESTER, NY

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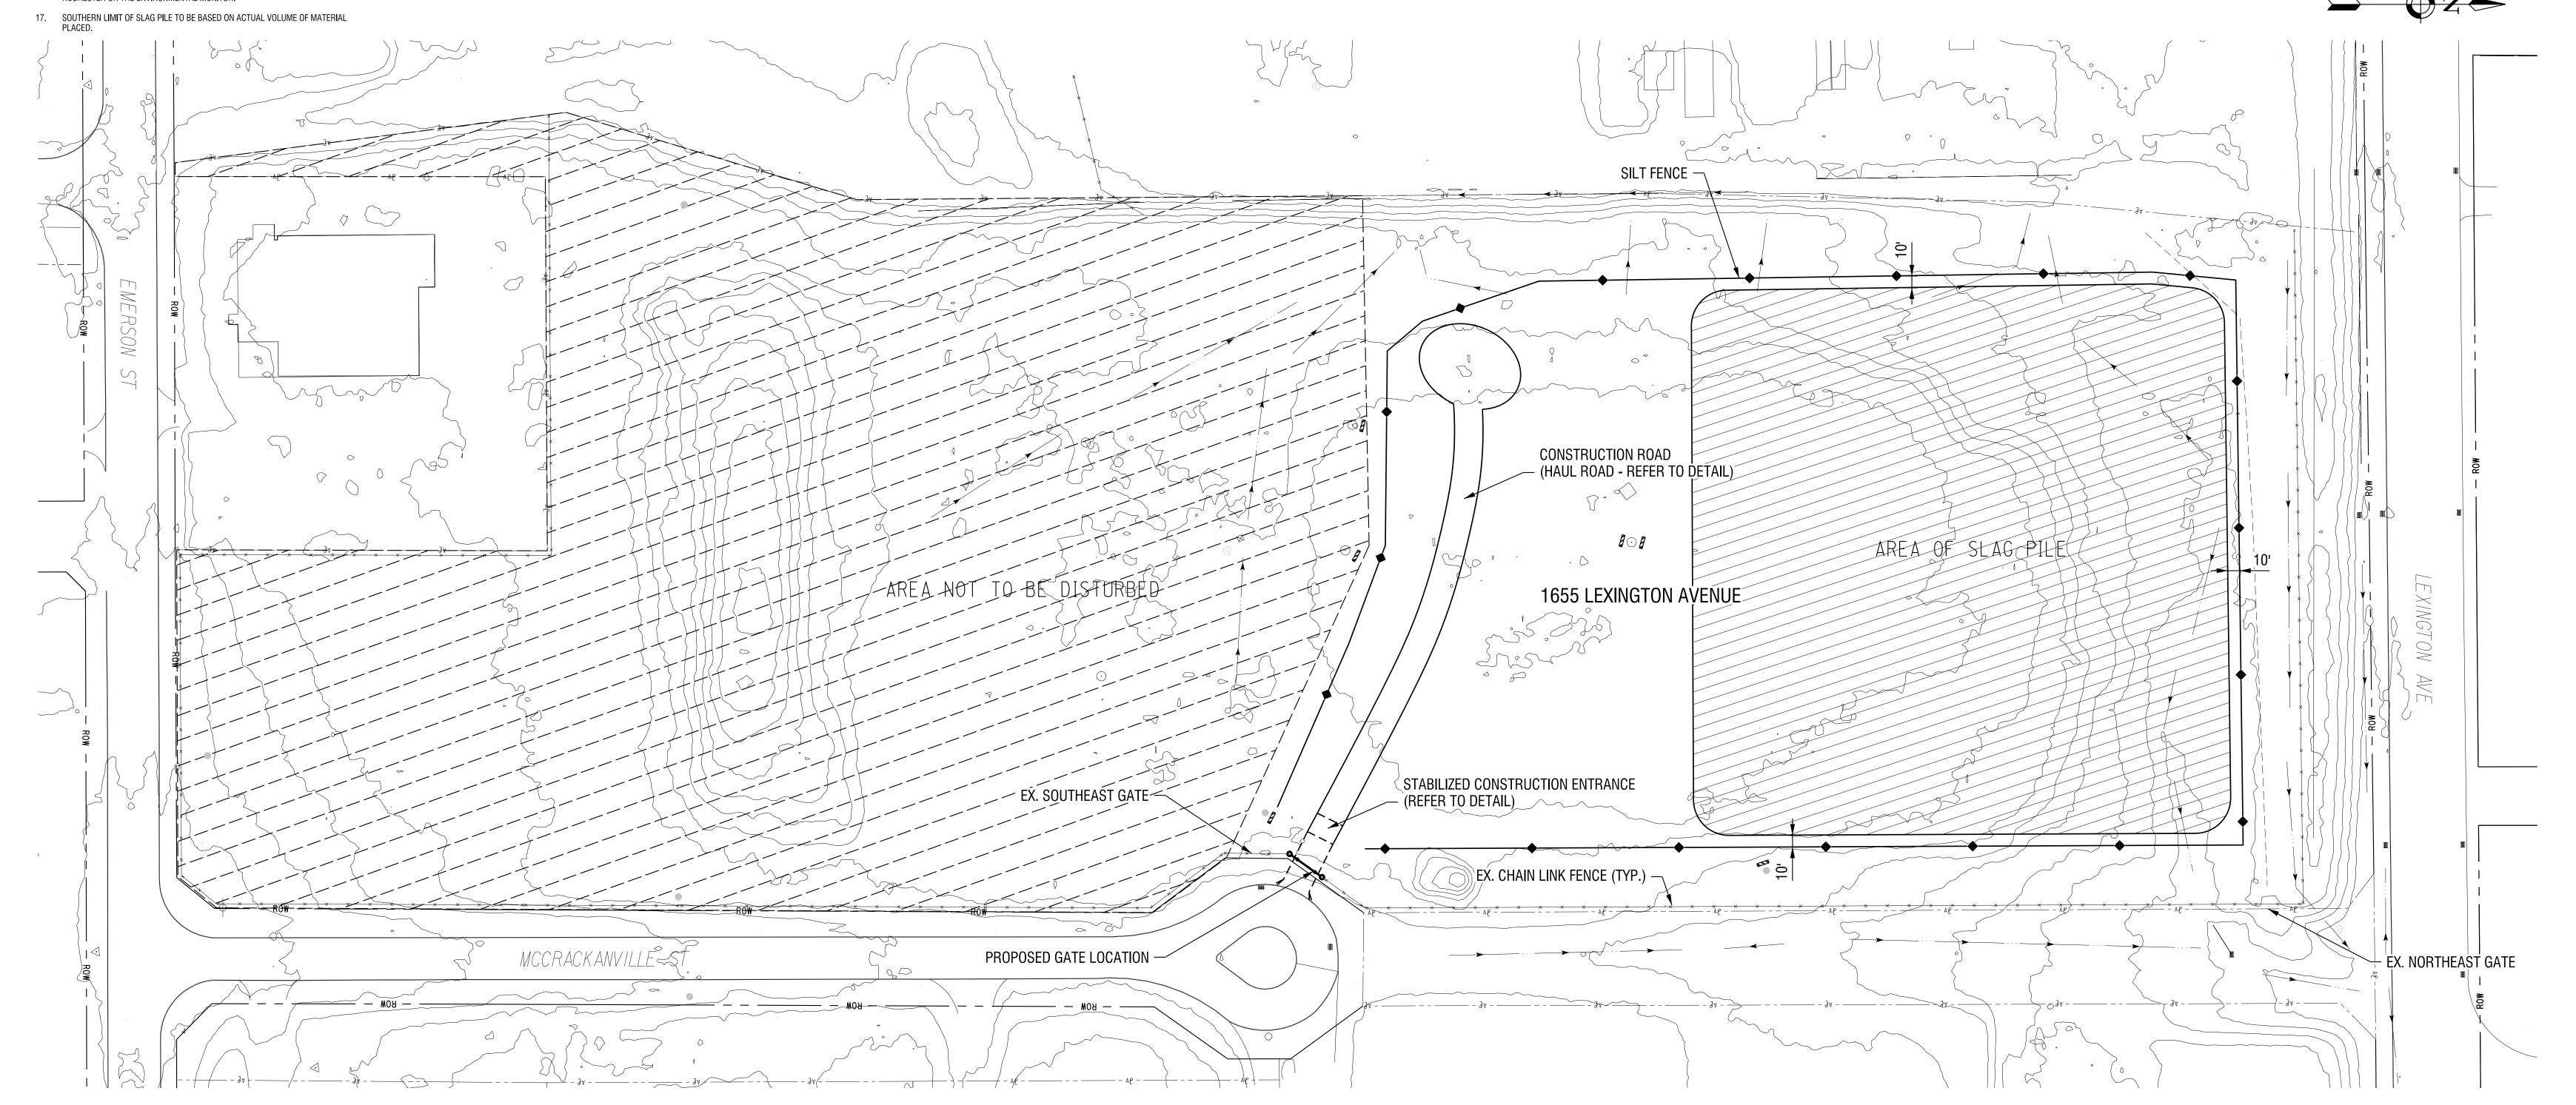
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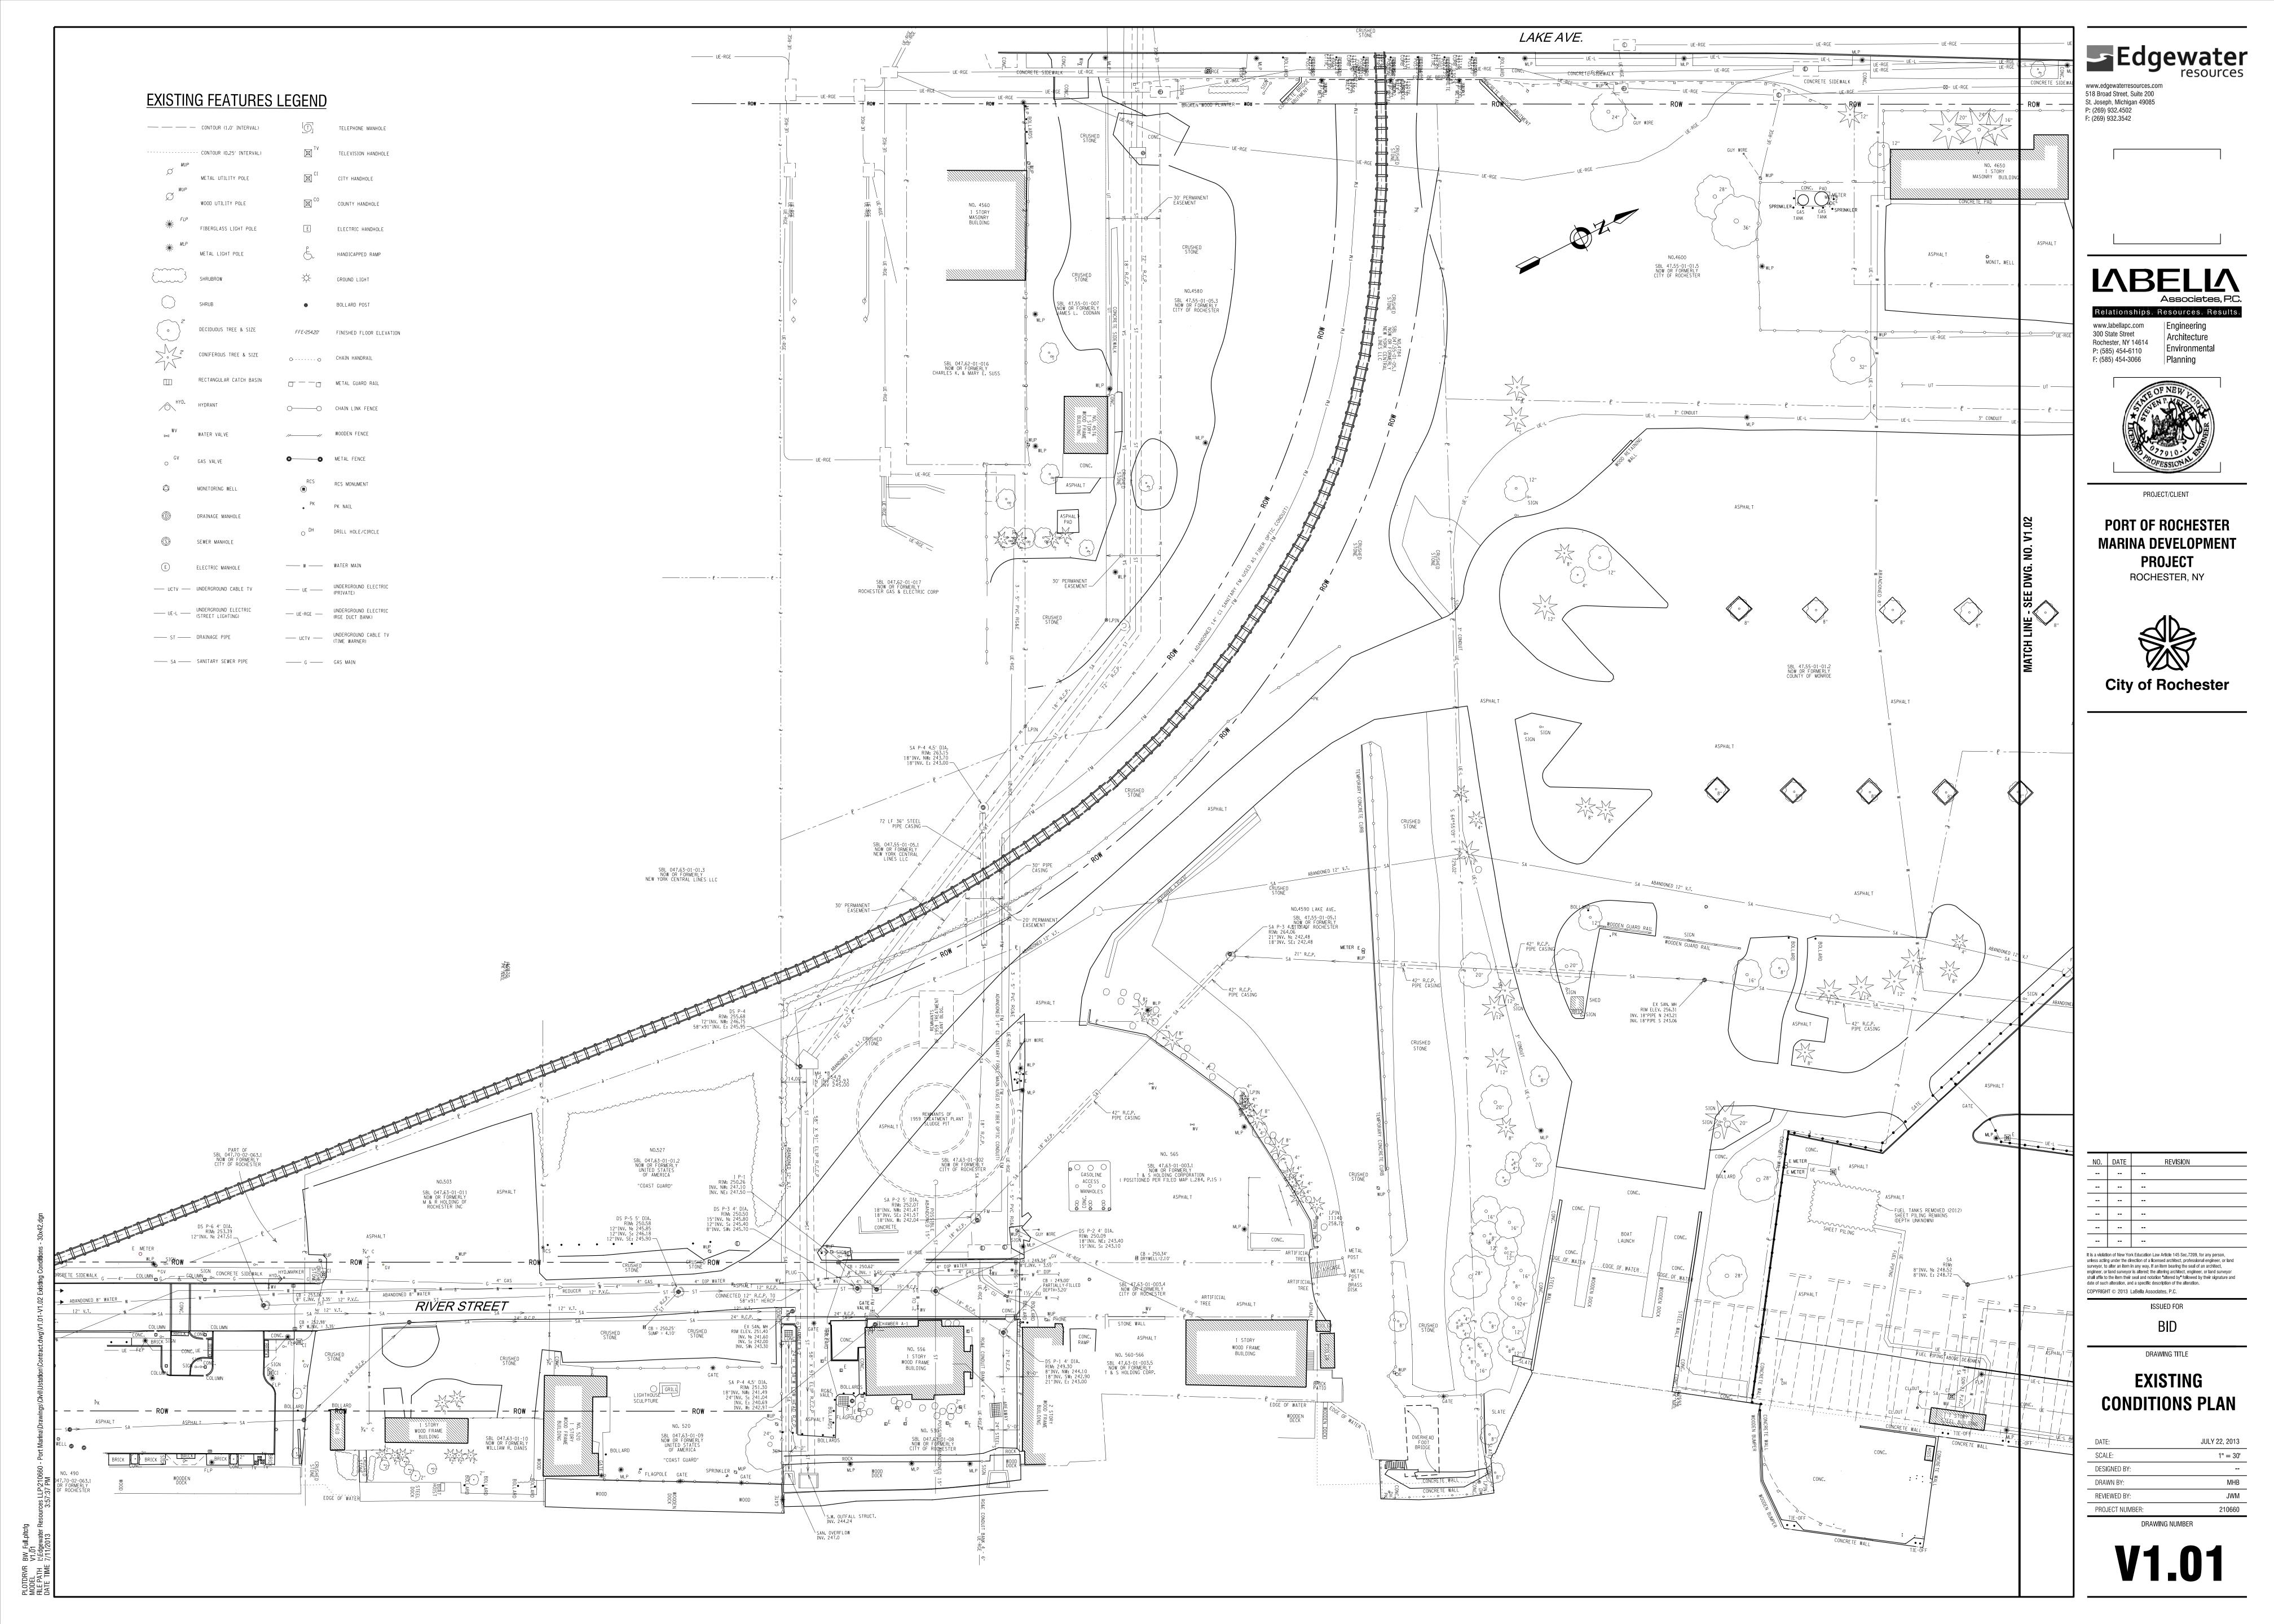
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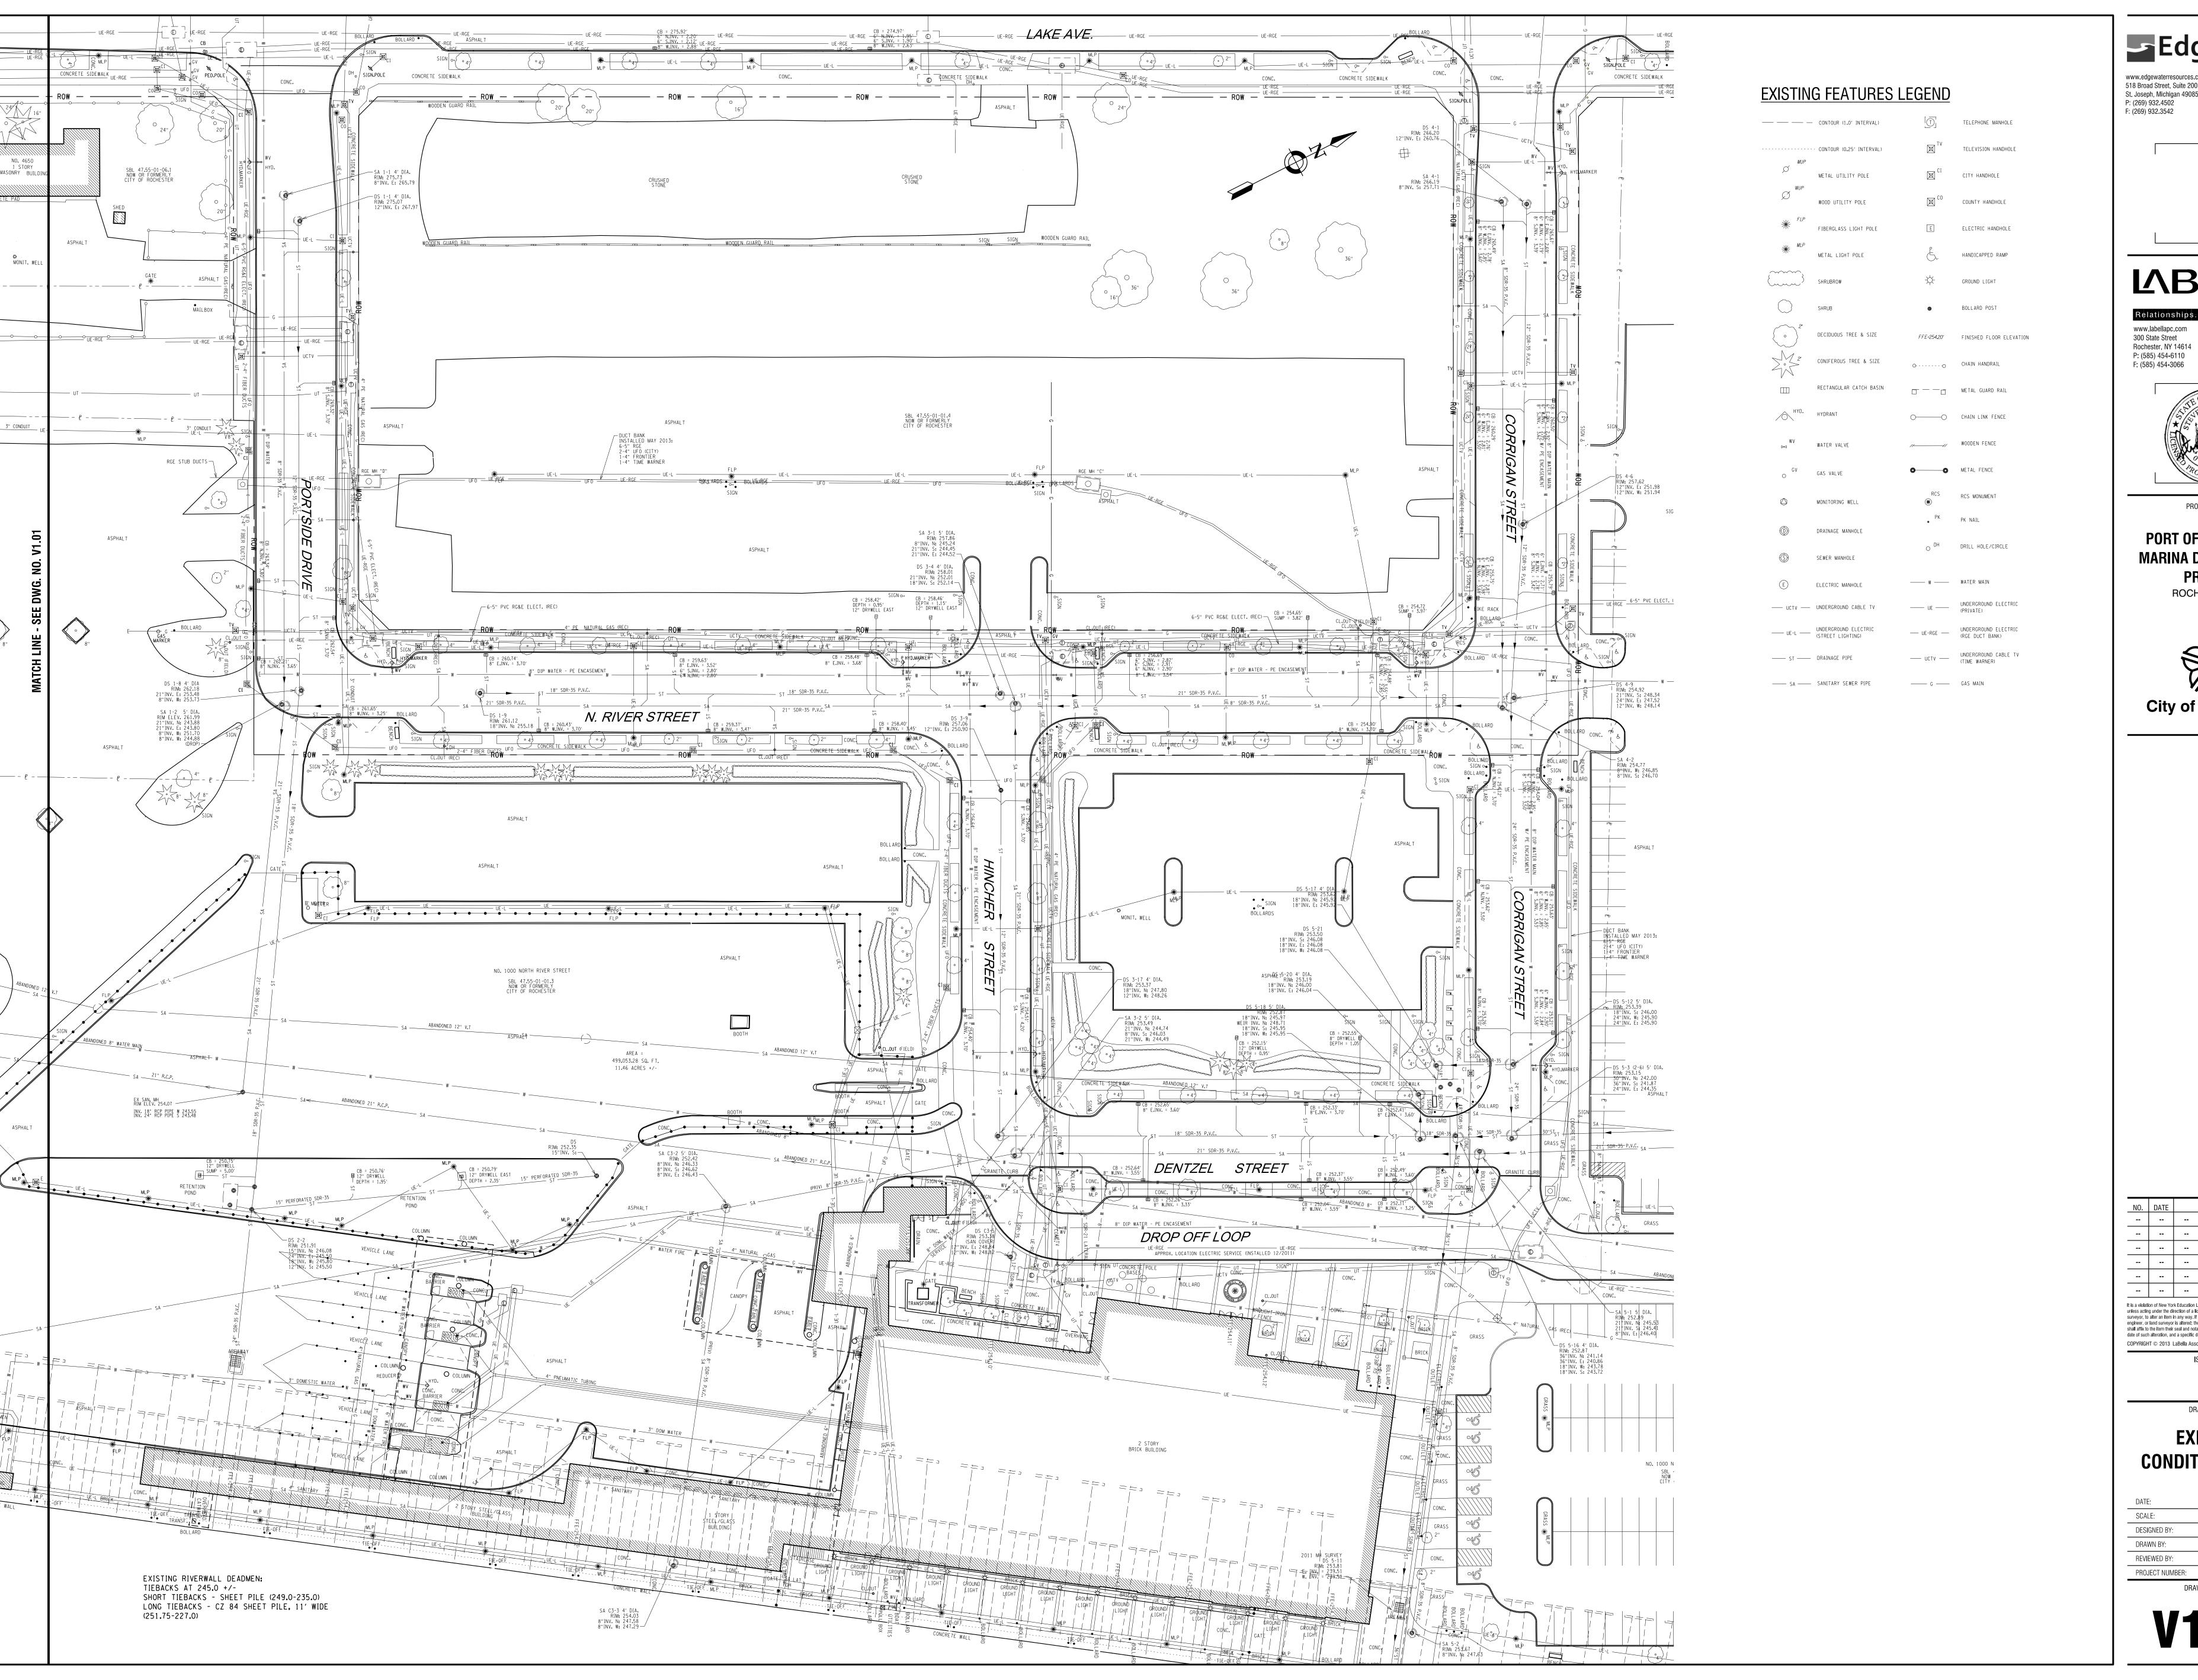
engineer, or land surveyor is altered; the altering architect, engineer, or land surveyor shall affix to the item their seal and notation "altered by" followed by their signature and date of such alteration, and a specific description of the alteration. COPYRIGHT © 2013 LaBella Associates, P.C.

**CITY STORAGE SITE** 

**1655 LEXINGTON AVE.** 

G6.01





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**EXISTING CONDITIONS PLAN** 

1" = 30' DESIGNED BY: REVIEWED BY: PROJECT NUMBER:

DRAWING NUMBER