# BUILDING B

# KONAR PROPERTIES

30 ADVENTURE PLACE, ROCHESTER, NEW YORK
14607
05/08/20
PERMIT SET

PROJECT #1709





PERMIT SET

SHEET NUMBER	SHEET NAME
0	COVER SHEET
CIVIL	
C001	GENERAL NOTES AND LEGEND
C101	EXISTING CONDITIONS AND DEMOLITION PLAN
C201	SITE PLAN
C301	UTILITY PLAN
C401	GRADING AND EROSION CONTROL PLAN
C501	CONSTRUCTION DETAILS
C502	CONSTRUCTION DETAILS
C503	CONSTRUCTION DETAILS
C504	CONSTRUCTION DETAILS
C505	CONSTRUCTION DETAILS
C506	CONSTRUCTION DETAILS
CODE REVIEW	
LS-01	LIFE SAFETY
LS-02	LIFE SAFETY
ARCHITECTURAL	<del>-</del>
A001	SYMBOLS, ABBREVIATIONS & GEN. NOTES
A100	GRADE FLOOR PLAN
A101	FIRST FLOOR PLAN
A102	SECOND FLOOR PLAN
A103	THIRD FLOOR PLAN
A104	FOURTH FLOOR PLAN
A105	ROOF PLAN
A106	FIRST FLOOR RAISED PATIO PLAN
A200	ELEVATIONS
A201	ELEVATIONS
A203	DETAIL ELEVATIONS
A204	INTERIOR ELEVATIONS
A205	INTERIOR ELEVATIONS
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A250	BUILDING SECTIONS
A251	BUILDING SECTIONS
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A300	STAIR A ENLARGED PLANS
A301	STAIR A VERTICAL CIRCULATON
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A400	FIRST FLOOR REFLECTED CEILING PLAN
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A500	WALL SECTIONS
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A505	BALCONY & CANOPY DETAILS
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A802	CURTAINWALL ELEVATIONS
A803	STOREFRONT TYPICAL DETAILS
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S220	SHEAR WALL FLOOR PLANS
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S510	FIRST FLOOR FRAMING DETAILS
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B-E1.1	BLDG. B - DETAILS, ELEVATIONS, & WIRING DIAGRAMS
B-E1.2	BLDG. B - DETAILS & SPECIFICATIONS
B-E2.0	BLDG. B - SITE LIGHTING & POWER PLAN
B-E3.0	BLDG. B - GROUND FLOOR PLANS - LIGHTING & POWER
B-E3.0	BLDG. B - GROUND FLOOR FLANS - LIGHTING & FOWER  BLDG. B - FIRST FLOOR PLANS - LIGHTING & POWER
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R-F8 1	BLDG B - TYPICAL APARTMENT PLANS

SUITE 201
ROCHESTER,
NY
www.labellapc.
com





<u>OWNER</u>



ARCHITECT



B-E8.1 BLDG. B - TYPICAL APARTMENT PLANS

DEVELOPER



CONSTRUCTION MANAGER



### MCDPH STANDARD WATER MAIN EXTENSION NOTES RWB WATER MAIN AND SERVICE NOTES

- 1. THE WATER MAIN AND TEMPORARY BYPASS PIPE SHALL BE DISINFECTED EQUAL TO AWWA STANDARD FOR DISINFECTING WATER MAINS, DESIGNATION C651, BY USING THE CONTINUOUS FEED METHOD. FOLLOWING DISINFECTION, THE WATER MAIN AND BYPASS PIPE SHALL BE FLUSHED UNTIL THE CHLORINE CONCENTRATION IN THE WATER LEAVING THE MAIN IS NO HIGHER THAN THAT GENERALLY PREVAILING IN THE SYSTEM. THE INTERIOR OF ALL WATER MAIN PIPE, VALVES, FITTINGS AND SERVICES FOUR (4) INCHES AND LARGER, INCLUDING NEW HYDRANT BRANCHES CONNECTED TO EXISTING WATER MAINS, NOT RECEIVING 24-HOUR CHLORINE DISINFECTION CONTACT TIME MUST BE SPRAY OR SWAB DISINFECTED WITH A MINIMUM 1% - 5% SOLUTION OF CHLORINE NO MORE THAN 30-MINUTES PRIOR TO INSTALLATION. ADDITIONALLY, THE EXTERIOR SURFACES OF EXISTING PIPE AND FITTINGS THAT NEW PIPE AND FITTINGS WILL BE CONNECTED TO MUST BE THOROUGHLY CLEANED AND DISINFECTED. THE MAXIMUM DISTANCE BETWEEN DISINFECTION/SAMPLING TAPS ON NEW WATER MAIN AND BYPASS PIPE SHALL BE 1,000 FEET. THE SAMPLING POINT(S) MUST BE DECONTAMINATED BY FLAMING. FIRE HYDRANTS ARE NOT ACCEPTABLE SAMPLING POINTS. THE MONROE COUNTY DEPARTMENT OF PUBLIC HEALTH MUST RECEIVE AT LEAST 48-HOUR ADVANCE NOTIFICATION REQUESTING SAMPLING SERVICES. THE CONTRACTOR SHALL CALL 585-753-5057 TO ARRANGE FOR SAMPLING SERVICES AND IS RESPONSIBLE FOR PAYING ALL MCDPH SAMPLING FEES. SAMPLING WILL NOT BE PERFORMED PRIOR TO RECEIPT FROM A NEW YORK STATE LICENSED OR REGISTERED DESIGN PROFESSIONAL (ENGINEER ARCHITECT OR LAND SURVEYOR WITH A SPECIAL EXEMPTION UNDER SECTION 7208(N) OF THE EDUCATION LAW) CERTIFYING THAT THE WATER SUPPLY IMPROVEMENTS, TESTING AND DISINFECTION PROCEDURES WERE COMPLETED IN ACCORDANCE WITH THE APPROVED PLANS, REPORTS, SPECIFICATIONS AND ANY APPROVED AMENDMENTS. THE DEPARTMENT WILL COLLECT SAMPLES FOR FREE CHLORINE RESIDUAL, TOTAL COLIFORM, ESCHERICHIA COLI (E. COLI) AND TURBIDITY. THE WATER MAIN AND BYPASS PIPE SHALL NOT BE PLACED INTO SERVICE UNTIL SO AUTHORIZED BY THE MONROE COUNTY DEPARTMENT OF PUBLIC HEALTH.
- 2. UNLESS OTHERWISE NOTED OR SHOWN ON THE APPROVED PLANS, THE MINIMUM VERTICAL SEPARATION BETWEEN WATER MAINS AND SEWER PIPE LINES SHALL BE 18-INCHES MEASURED FROM THE OUTSIDE OF THE PIPES AT THE POINT OF CROSSING. ONE FULL STANDARD LAYING LENGTH OF WATER MAIN SHALL BE CENTERED UNDER OR OVER THE SEWER SO THAT BOTH JOINTS WILL BE AS FAR FROM THE SEWER AS POSSIBLE. IN ADDITION, WHEN THE WATER MAIN PASSES UNDER A SEWER, ADEQUATE STRUCTURAL SUPPORT (COMPACTED SELECTED FILL) SHALL BE PROVIDED FOR THE SEWER TO PREVENT EXCESSIVE DEFLECTION OF JOINTS AND SETTLING OF THE SEWER ON THE WATER MAIN. UNLESS OTHERWISE NOTED OR SHOWN ON THE APPROVED PLANS. THE MINIMUM HORIZONTAL SEPARATION BETWEEN PARALLEL WATER MAINS AND SEWER PIPES (INCLUDING MANHOLES AND VAULTS) SHALL BE 10-FEET MEASURED FROM THE OUTSIDE OF THE PIPES, MANHOLES OR VAULTS.
- 3. WHEN INSTALLING FIRE HYDRANTS, SHOULD GROUND WATER BE ENCOUNTERED WITHIN SEVEN (7) FEET OF FINISHED GRADE, FIRE HYDRANT WEEP HOLES (DRAINS) SHALL BE
- 4. THE NEW WATER MAINS AND SERVICES 4-INCH AND GREATER SHALL BE PRESSURE/LEAKAGE TESTED IN ACCORDANCE WITH THE MINIMUM REQUIREMENTS OF THE AWWA STANDARD C600 (LATEST REVISION) OR IN ACCORDANCE WITH MORE STRINGENT REQUIREMENTS IMPOSED BY THE SUPPLIER OF WATER. FOR CITY OF ROCHESTER WATER MAINS, PRESSURE/LEAKAGE TESTING SHALL BE PERFORMED IN ACCORDANCE WITH SUBSECTION 3.05 OF CITY OF ROCHESTER WATER BUREAU SPECIFICATION S900 - GENERAL WATER PROVISIONS.

- 1. WATER MAINS AND APPURTENANCES TO BE CONSTRUCTED IN ACCORDANCE WITH THE REGULATIONS AND SPECIFICATIONS OF THE ROCHESTER WATER BUREAU, ALL PIPE PRODUCTS, FITTINGS AND ACCESSORIES SHALL CONFORM TO THE LATEST ROCHESTER WATER BUREAU (RWB) APPROVED PRODUCTS LIST WHICH CAN BE FOUND ON THE CITY WEB SITE: HTTP://WWW.CITYOFROCHESTER.GOV/WATERDOCUMENTS/.
- 2. ALL NEW WATER MAINS AND SERVICES SHALL BE INSTALLED WITH A MINIMUM COVER DEPTH FROM PROPOSED FINISHED GRADE OF 4.5 FEET FOR DOMESTIC MAINS AND 5.0 FEET FOR HOLLY MAINS.
- 3. THE ROCHESTER WATER BUREAU REQUIRES THAT A HYDRANT USE PERMIT BE OBTAINED BY THE CONTRACTOR PRIOR TO USING ANY HYDRANT AS A SOURCE OF WATER SUPPLY. THE PERMIT REQUIRES THE USE OF A WATER METER AND A BACKFLOW PREVENTER. THE WATER BUREAU WILL SUPPLY A WATER METER AND BACKFLOW PREVENTER WITH THE PERMIT. THE PERMIT FEE INCLUDES A REFUNDABLE DEPOSIT FOR THE USE OF THE WATER METER AND BACKFLOW PREVENTER.
- 4. FOR EXISTING VALVES AND CURB STOPS THAT ARE LOCATED ON WATER MAINS AND WATER SERVICES WHICH ARE TO BE RETAINED, THE EXISTING VALVE AND CURB BOXES SHALL BE ADJUSTED TO GRADE OR REPLACED AS SHOWN ON THE PLANS OR DIRECTED BY THE PROJECT MANAGER.
- 5. THE CONTRACTOR SHALL EXERCISE CAUTION WHEN WORKING NEAR WATER MAINS WHICH ARE TO BE RETAINED. NO VIBRATORY EQUIPMENT IS TO BE USED OVER OR ADJACENT TO EXISTING WATER MAINS.
- 6. APPROPRIATE MEASURES SHALL BE TAKEN TO PREVENT DIRT, DEBRIS, SURFACE AND GROUND WATER FROM CONTAMINATING THE WATER MAIN AND WATER SERVICE. THE WATER LEVEL IN THE EXCAVATION AT OPEN PIPE ENDS SHALL NEVER BE LESS THAN 12 INCHES BELOW THE INVERT OF THE WATER MAIN. WHENEVER AN OPEN PIPE END IS LEFT UNATTENDED, IT SHALL BE COVERED IN A WATER TIGHT MANNER.
- 7. ALL SERVICE TAPS ON PVC/PVCO WATER MAIN REQUIRE SERVICE SADDLES.
- 8. STAINLESS STEEL INSERTS ARE REQUIRED ON ALL POLYETHYLENE (PE) SERVICE
- 9. TRACER WIRE IS REQUIRED ON ALL BURIED NON-METALLIC WATER MAINS AND WATER
- 10. A PRECONSTRUCTION MEETING IS REQUIRED WITH THE ROCHESTER WATER BUREAU AFTER THE ISSUING OF A PERMIT. BUT BEFORE CONSTRUCTION OF THE WATER MAIN OR SERVICE BEGIN. CONTACT THE ROCHESTER WATER BUREAU AT (585) 428-7500 AND REQUEST TO SPEAK TO WATER ENGINEERING TO SCHEDULE THE MEETING.

## MCPW - ROCHESTER PURE WATERS DISTRICT SEWER NOTES FOR SEWER LATERAL

#### CONNECTIONS

- 1. THIS PLAN REQUIRES APPROVAL AND ISSUANCE OF A PLUMBING PERMIT FROM THE CITY OF ROCHESTER PLUMBING DEPARTMENT
- 2. PRIOR TO CONSTRUCTION, A SEWER CONNECTION PERMIT MUST BE OBTAINED FROM THE MONROE COUNTY PURE WATERS (MCPW) PERMIT OFFICE AT 145 PAUL ROAD,

BUILDING 11, ROCHESTER, NEW YORK 14624, PHONE # 753-7600 (OPT. 5).

- 3. SEWER CONNECTION PERMIT(S) CAN ONLY BE ISSUED TO A PLUMBER LICENSED IN THE CITY OF ROCHESTER AND WHO IS FULLY INSURED AND BONDED IN THE ROCHESTER PURE WATERS DISTRICT (RPWD). PAYMENT (CHECK OR MONEY ORDER TO "RPWD") OF ALL APPLICABLE PERMIT FEES MUST BE PAID PRIOR TO PERMIT ISSUANCE.
- 4. THE RPWD SHALL BE NOTIFIED **FORTY-EIGHT HOURS** IN ADVANCE OF A CONNECTION OR TAP. [753-7600 (OPT. 5)]. THE CONTRACTOR SHALL MAKE ALL REQUIRED TAPS TO THE RPWD SEWERS. ALL TAPS AND CONNECTIONS TO DISTRICT UTILITIES MUST BE WITNESSED BY A DISTRICT INSPECTOR.
- 5. SANITARY/STORM/COMBINATION SEWER LATERAL(S) AND APPURTENANCES SHALL BE CONSTRUCTED IN CONFORMANCE WITH THE REQUIREMENTS OF THE ROCHESTER PURE WATERS DISTRICT. ALL NEW CONNECTIONS SHALL BE INSPECTED BY A
- 6. CLEANOUTS SHALL BE INSTALLED ON ALL 4" AND 6" DIAMETER SEWER LATERALS AT THE RIGHT-OF-WAY (ROW) LINE. OR THE SEWER EASEMENT LINE WHERE APPLICABLE. (THE SEWER EASEMENT, RIGHT-OF-WAY AND/OR PROPERTY LINE MUST BE STAKED OUT PRIOR TO INSTALLATION OF LOT LINE CLEANOUTS TO ENSURE PROPER LOCATION OF THE CLEANOUTS. [REFER TO CLEANOUT DETAIL FOR PROPER INSTALLATION]).
- IF AN EXISTING LATERAL IS TO BE UTILIZED, THE PLUMBER/CONTRACTOR MUST ENSURE THAT THE LATERAL IS IN GOOD CONDITION AND IS FREE OF DEBRIS (DIRT, MUD, STONE, ROOTS FTC ) VIA A VIDEO TAPED INSPECTION PERFORMED BY THE PLUMBER/CONTRACTOR OR HIS/HER/THEIR AGENT. PRIOR TO CONNECTION, THE VIDEO TAPED INSPECTION OF THE EXISTING LATERAL MUST BE PRESENTED TO THE DISTRICT FOR REVIEW AND APPROVAL TO UTILIZE AN EXISTING LATERAL. IT IS THE RESPONSIBILITY OF THE BUILDER OR THEIR AGENT TO CLEAN AND/OR REPLACE THE
- PIPE/LATERAL AS NEEDED. 8. ANY NEW PORTION OF A SEWER LATERAL INSTALLED WITHIN THE PUBLIC RIGHT-OF-WAY AND SEWER EASEMENT MUST BE SDR-21 PVC.
- 9. ANY EXISTING LATERALS NOT UTILIZED MUST BE ABANDONED TO MONROE COUNTY PURE WATERS (MCPW) STANDARDS AT THE PROPERTY LINE OR, WHERE APPLICABLE, THE SEWER EASEMENT LINE.
- 10. FLOOR DRAINS IF CONSTRUCTED, SHALL BE CONNECTED TO THE SANITARY/COMBINATION SEWER. FLOOR DRAINS DO NOT INCLUDE FOUNDATION/FOOTER DRAINS. NOTE: ALL DISCHARGES TO THE SANITARY/COMBINATION SEWER MUST COMPLY WITH THE EFFLUENT LIMITS OF THE LOCAL AND/OR MONROE COUNTY SEWER
- 11. ANY PORTION OF A SEWER/LATERAL WITH LESS THAN FOUR-FEET (4') OF COVER WILL REQUIRE CONCRETE ENCASEMENT. SEWERS/LATERALS WITH LESS THAN THREE-FEET (3') OF COVER ARE NOT ALLOWED.
- 12. THE REQUIREMENTS OF THE HIGHWAY/PROPERTY OWNER SHALL BE ADHERED TO FOR ITEMS ABOVE THE PIPE BEDDING, INCLUDING, BUT NOT LIMITED TO, MAINTENANCE AND PROTECTION OF TRAFFIC, BACKFILL MATERIAL AND SURFACE RESTORATION.
- 13. ALL EXISTING AND/OR PROPOSED EASEMENTS AND/OR RIGHT-OF-WAYS (ROW) ARE TO BE STAKED OUT IN THE FIELD BY AN ENGINEER/SURVEYOR PRIOR TO THE START OF ANY SITE CONSTRUCTION/EXCAVATION AND MAINTAINED DURING COURSE OF THE PROJECT TO ENSURE THE PURE WATERS LOT LINE CLEAN OUTS ON THE BUILDING LATERALS ARE PROPERLY PLACED AND THAT NO PERMANENT AND/OR NONPERMANENT STRUCTURES ARE INSTALLED WITHIN EASEMENTS AND/OR ROW. IT IS THE OWNER'S OR THEIR AGENT'S RESPONSIBILITY TO STAKE OUT ALL EASEMENTS. THIS WILL NOT BE THE RESPONSIBILITY OF THE RPWD.

### **DEMOLITION NOTES**

- 1. CONTRACTOR SHALL FIELD VERIFY ALL EXISTING CONDITIONS PRIOR TO BID. NO ALLOWANCE WILL BE MADE FOR ADDITIONAL COSTS DUE TO CONTRACTOR'S FAILURE TO VERIFY EXISTING CONDITIONS AND DIMENSIONS.
- 2. PRIOR TO THE START OF CONSTRUCTION, THE CONTRACTOR SHALL TO NOTIFY DIG SAFELY NEW YORK AT 811 TO REQUEST UTILITY STAKEOUT OF ALL PUBLIC UTILITIES.
- WORK ASSOCIATED WITH THIS CONTRACT WILL OCCUR AT AN ACTIVE AND FUNCTIONAL FACILITY. CONTRACTOR SHALL COORDINATE WITH THE OWNER TO MINIMIZE DISRUPTION TO THE OPERATIONS OF THE FACILITY. CONTRACTOR SHALL BE SOLELY RESPONSIBLE TO PROVIDE A SAFE WORK SITE AND TO PROTECT THE PUBLIC, VISITORS AND EMPLOYEES FROM HARM AS A RESULT OF HIS CONSTRUCTION ACTIVITIES.
- 4. THE HORIZONTAL AND VERTICAL LOCATION OF ALL EXISTING ABOVE GROUND AND BELOW GROUND UTILITIES, STRUCTURES, AND APPURTENANCES SHOWN ON THE PLANS ARE APPROXIMATE AND ARE NOT GUARANTEED. THE CONTRACTOR SHALL BE RESPONSIBLE FOR DETERMINING THE EXACT HORIZONTAL AND VERTICAL LOCATION OF ALL UTILITIES, STRUCTURES, AND APPURTENANCES IN THE PATH OF AND ADJACENT TO THE PROPOSED WORK.
- 5. SITE DRAINAGE, INCLUDING THE PROJECT SITE AND ADJACENT ROADWAYS, DRIVES, PARKING AREAS OR PROPERTIES SHALL BE MAINTAINED THROUGHOUT THE CONSTRUCTION PERIOD.
- 6. CONTRACTOR SHALL PROTECT AND SUPPORT ALL EXISTING UTILITIES DESIGNATED TO REMAIN FOR THE DURATION OF THE CONTRACT.
- 7. THE CONTRACTOR SHALL NOTIFY THE LOCAL GOVERNMENT AND LOCAL FIRE DEPARTMENT AS NECESSARY AND SHALL OBTAIN ANY REQUIRED PERMITS PRIOR TO BEGINNING WORK. COPIES OF ANY REQUIRED PERMITS SHALL BE PROVIDED TO THE OWNER PRIOR TO BEGINNING THE WORK.
- 8. CONTRACTOR SHALL REMOVE FROM SITE, MATERIALS NOT INDICATED TO BE SALVAGED INCLUDING ALL DEBRIS. ALL REMOVED MATERIALS SHALL BECOME THE PROPERTY OF CONTRACTOR WHO SHALL LEGALLY DISPOSE OF SAME.
- 9. ALL TREES. SHRUBS AND PLANTS DESIGNATED TO REMAIN AND DISTURBED BY CONSTRUCTION OPERATIONS, SHALL BE REPLACED IN-KIND AS DIRECTED BY THE ARCHITECT/ENGINEER AND/OR OWNER'S DESIGNATED REPRESENTATIVE AT NO ADDITIONAL COST TO THE OWNER
- 10. THE CONTRACTOR SHALL MAINTAIN SAFE VEHICULAR AND PEDESTRIAN ACCESS TO ADJACENT EXISTING BUILDINGS FOR THE DURATION OF THE CONTRACT.
- 11. WHEN EXISTING CONSTRUCTION WHICH IS TO REMAIN IS DAMAGED DURING THE COURSE OF CONSTRUCTION AS A RESULT OF CONTRACTORS WORK, IT SHALL BE REPAIRED AND/OR REPLACED WITH SIMILAR OR LIKE MATERIALS AS MUCH AS POSSIBLE. AT NO COST TO THE OWNER. ALL REPAIRS AND/OR REPLACEMENTS WILL BE SUBJECT TO OWNERS APPROVAL
- 12. COORDINATE LOCATION OF TEMPORARY CONSTRUCTION FENCE AND TEMPORARY STONE STAGING AREA WITH OWNER'S REPRESENTATIVE AND / OR CONSTRUCTION MANAGER.

#### GENERAL NOTES

- 1. THE CONTRACTOR ALONE SHALL BE RESPONSIBLE TO LOCATE UTILITIES OUTSIDE THE RIGHT-OF-WAY.
- 2. SITE DRAINAGE, INCLUDING THE PROJECT SITE AND ADJACENT ROADWAYS, DRIVES, PARKING AREAS OR PROPERTIES SHALL BE MAINTAINED THROUGHOUT THE CONSTRUCTION PERIOD
- 3. THE CONTRACTOR SHALL BE RESPONSIBLE FOR SUPPLYING ALL MATERIALS, TOOLS AND EQUIPMENT, INCLUDING SPECIAL CUTTING DEVICES, NECESSARY TO PERFORM THE WORK CONTAINED IN THIS CONTRACT.
- 4. THE SIZES AND MATERIAL OF CONSTRUCTION OF WATER MAINS, SANITARY SEWERS AND STORM SEWERS TO REMAIN ARE REPUTED. THE CONTRACTOR SHALL VERIFY SIZES OF ALL UTILITIES WHERE CONNECTIONS TO SAID EXISTING UTILITIES ARE REQUIRED. EXCAVATION TO VERIFY THESE UTILITIES SHALL BE MADE AT NO ADDITIONAL COST TO THE OWNER.
- 5. THE CONTRACTOR SHALL PROTECT ALL EXISTING SITE AMENITIES NOT DESIGNATED FOR
- 6. UNLESS OTHERWISE INDICATED ON THE PLANS OR DIRECTED BY THE ARCHITECT/ENGINEER. THE CONTRACTOR IS RESPONSIBLE FOR PRESERVING AND PROTECTING FROM DAMAGE ALL TREES. SHRUBS AND PLANTS IN THE VICINITY OF THE PROPOSED WORK.
- 7. THE CONTRACTOR SHALL PROTECT AND SUPPORT ALL EXISTING UTILITIES DESIGNATED TO REMAIN FOR THE DURATION OF THE CONTRACT.
- ANY SITE AMENITY, UTILITY, STREET APPURTENANCE, OR OTHER ITEM WHICH BECOMES DAMAGED AS A RESULT OF THE CONTRACTOR'S OPERATIONS SHALL BE REPAIRED OR REPLACED IN-KIND BY THE CONTRACTOR AS DETERMINED BY THE PROJECT MANAGER OR ARCHITECT/ENGINEER AND AT NO ADDITIONAL COST TO THE OWNER.

#### SURVEY NOTES

- 1. CONTRACTOR SHALL FIELD VERIFY ALL EXISTING CONDITIONS PRIOR TO BID. NO ALLOWANCE WILL BE MADE FOR ADDITIONAL COSTS DUE TO CONTRACTOR'S FAILURE TO VERIFY EXISTING CONDITIONS,
- 2. THE CONTRACTOR SHALL LOCATE, MARK, SAFEGUARD AND PRESERVE ALL SURVEY MARKERS AND RIGHT-OF-WAY MARKERS IN THE AREA OF CONSTRUCTION.
- ANY IRON PINS, MONUMENTS OR OTHER ITEMS DEFINING PROPERTY LINES WHICH ARE DISTURBED BY CONSTRUCTION OPERATIONS SHALL BE PROPERLY TIED AND ACCURATELY RESET BY A NYS LICENSED SURVEYOR UPON COMPLETION OF THE WORK.
- HORIZONTAL DATUM BASED OFF NAD83 NY-W. ELEVATIONS BASED OFF CITY OF ROCHESTER

#### SITE NOTES

- WELL COMPACTED SUBGRADE SHALL BE UTILIZED UNDERNEATH CONSTRUCTION OF PAVEMENT AND CONCRETE BASES
- 2. ALL STAKEOUT FOR THE PROPOSED SITE IMPROVEMENTS SHALL BE COMPLETED BY A NEW YORK STATE LICENSED LAND SURVEYOR.
- 3. IF ANY DISCREPANCIES ARE NOTED BETWEEN THESE CONSTRUCTION DOCUMENTS AND INFORMATION PROVIDED OR AN ERROR IS SUSPECT, IT SHALL BE IMMEDIATELY REPORTED TO THE CONSTRUCTION MANAGER AND LABELLA ASSOCIATES PROJECT
- ANY PROOF-ROLLING OF EXPOSED SUBBASE BY A MINIMUM 10 TON SMOOTH DRUM ROLLER SHALL BE DONE UNDER THE GUIDANCE OF, AND OBSERVED BY, QUALIFIED ENGINEERING PERSONNEL PRIOR TO PLACEMENT OF SUBBASE MATERIAL. THE ROLLER SHOULD BE OPERATED IN THE STATIC MODE AND COMPLETE AT LEAST TWO (2) PASSES OVER THE EXPOSED SUBGRADES.

#### **GRADING NOTES**

- 1. THE CONTRACTOR SHALL CONFORM TO THE REQUIREMENTS OF OSHA, AND ANY OTHER AGENCY HAVING JURISDICTION WITH REGARD TO SAFETY PRECAUTIONS WITH TRENCHING OPERATIONS. THE REQUIREMENTS SET FORTH HEREIN ARE INTENDED TO SUPPLEMENT REQUIREMENTS ESTABLISHED BY THESE AGENCIES. IN THE CASE OF A CONFLICT BETWEEN REQUIREMENTS OF OTHER JURISDICTIONAL AGENCIES AND THESE DOCUMENTS, THE MORE STRINGENT REQUIREMENT ON THE CONTRACTOR SHALL APPLY.
- 2. SHEETING, IF REQUIRED DURING CONSTRUCTION, IS CONSIDERED TO BE PART OF THIS CONTRACT AND SHALL BE PROVIDED AT NO ADDITIONAL COST TO THE OWNER.
- 3. ALL TRENCHES THROUGH PAVEMENT SHALL BE SAW CUT PRIOR TO EXCAVATION AND AGAIN PRIOR TO PAVEMENT RESTORATION.
- 4. CONTRACTOR SHALL ADJUST THE RIMS OF ALL MANHOLES, CATCH BASINS, VALVE BOXES AND OTHER UTILITY SITE STRUCTURES TO MEET FINISHED GRADE IN AREAS REQUIRING REPAVING OR REGRADING AS PART OF THE WORK, INCLUDING THOSE THAT MAY NOT BE SHOWN ON THE PLANS.
- VOIDS LEFT BY UTILITY OR STRUCTURE REMOVAL OR GRUBBING OPERATIONS SHALL BE BACKFILLED AND PROPERLY COMPACTED WITH STRUCTURAL FILL (NYSDOT ITEM 304.12) IN AREAS UNDER AND WITHIN 5 FEET HORIZONTALLY OF ALL STRUCTURES, BUILDINGS AND PAVEMENTS. IN GRASSED AREAS, VOIDS LEFT SHALL BE FILLED AND PROPERLY COMPACTED WITH SUITABLE ON-SITE OR IMPORTED EARTHEN BACKFILL. ALL DISTURBED AREAS SHALL BE RESTORED.
- 6. THE CONTRACTOR SHALL DEWATER ALL EXCAVATIONS TO PREVENT THE INTRODUCTION OF GROUNDWATER INTO THE TRENCHES/EXCAVATIONS. PROVIDE ALL EQUIPMENT NECESSARY TO MAINTAIN THE GROUNDWATER LEVEL AS NECESSARY.
- 7. THE CONTRACTOR SHALL PLACE AT MINIMUM 6 INCHES OF CLEANED SCREENED TOPSOIL IN ALL DISTURBED AREAS PRIOR TO SEEDING

#### EROSION AND SEDIMENT CONTROL NOTES

- 1. ALL EROSION CONTROL MEASURES SHALL BE IN ACCORDANCE WITH NEW YORK STANDARDS AND SPECIFICATIONS FOR EROSION AND SEDIMENT CONTROL, AND LOCAL GOVERNING SOIL AND WATER CONSERVATION AGENCY RECOMMENDATIONS AND STANDARDS CONTRACTOR SHALL SURMIT PROPOSED FROSION CONTROL PLAN INCLUDING SEQUENCING OF WORK TO THE ENGINEER FOR REVIEW PRIOR TO START OF
- 2. UTILIZE CONSTRUCTION METHODS/TECHNIQUES, WHICH WILL LIMIT THE EXPOSED EARTHEN AREAS AND MINIMIZE THE EFFECT OF EARTH DISTURBANCE ACTIVITIES ON SOIL
- 3. ALL SEDIMENTATION BARRIERS AND OTHER TEMPORARY OR PERMANENT MEASURES SHALL BE IN PLACE PRIOR TO THE START OF CONSTRUCTION. PLANS SHOW THE SUGGESTED MINIMUM MEASURES REQUIRED.
- 4. REMOVAL OF ALL TEMPORARY EROSION AND SEDIMENTATION CONTROL MEASURES SHALL BE COMPLETED AT THE APPROVAL OF THE OWNER AND ENGINEER. THE COST OF REMOVING THESE MEASURES SHALL ALSO BE INCLUDED IN THE BID PRICE.
- FOR THE DURATION OF THE PROJECT. THE CONTRACTOR SHALL PROTECT ALL ON-SITE. ADJACENT AND/OR DOWNSTREAM STORM/SANITARY SEWERS, AND/OR OTHER WATER COURSES FROM CONTAMINATION BY WATER BORNE SILTS, SEDIMENTS, FUELS, SOLVENTS, LUBRICANTS OR OTHER POLLUTANTS ORIGINATING FROM ANY WORK DONE ON, OR IN SUPPORT OF THIS PROJECT.
- 6. DURING CONSTRUCTION NO WET OR FRESH CONCRETE OR LEACHATE SHALL BE ALLOWED TO ESCAPE INTO STORM/SANITARY SEWERS, DITCHES OR OTHER WATERS OF NEW YORK STATE, NOR SHALL WASHINGS FROM CONCRETE TRUCKS, MIXERS OR OTHER DEVICES BE ALLOWED TO ENTER ANY STORM/SANITARY SEWERS, DITCHES, RIVERS, OR WATER COURSES.
- 7. ALL EXCAVATED OR IMPORTED EARTHEN STOCKPILES SHALL BE SUITABLY STABILIZED AND PROTECTED BY SILT FENCE SO THAT IT CANNOT REASONABLY ENTER ANY WATER BODY, OR STORM OR SANITARY SEWER.
- 8. ALL METHODS AND EQUIPMENT PROPOSED BY THE CONTRACTOR TO ACCOMPLISH THE WORK FOR EROSION AND POLLUTION CONTROL SHALL BE SUBJECT TO APPROVAL OF THE ENGINEER.
- 9. THE CONTRACTOR SHALL BE REQUIRED TO TREAT TRAVELED AREAS TO CONTROL DUST. WATER SHALL BE APPLIED TO SUCH TRAVELED AREAS AS THE ARCHITECT/ENGINEER OR OWNER'S DESIGNATED REPRESENTATIVE MAY DESIGNATE. THE NUMBER OF APPLICATIONS AND THE AMOUNT OF WATER SHALL BE BASED UPON FIELD AND WEATHER CONDITIONS.
- 10. ALL AREAS OF SOIL DISTURBANCE RESULTING FROM THIS PROJECT WHICH WILL NOT BE SUBJECT TO FURTHER EARTHWORK OR CONSTRUCTION ACTIVITIES SHALL BE PERMANENTLY SEEDED TO ESTABLISH GRASS, AND MULCHED WITH HAY OR STRAW WITHIN ONE WEEK OF FINAL DISTURBANCE. MULCH SHALL BE MAINTAINED UNTIL A SUITABLE VEGETATIVE COVER IS ESTABLISHED.
- 11. CONTRACTOR STAGING AREAS AND CONSTRUCTION ENTRANCE LOCATIONS SHALL BE COORDINATED WITH THE OWNER PRIOR TO START OF CONSTRUCTION. STABILIZED CONSTRUCTION ENTRANCE(S), AS SHOWN ON THE PLANS SHALL BE PROVIDED. ALL DISTURBED AREAS SHALL BE RESTORED.
- 12. ALL CATCH BASINS/DRAINAGE INLETS SHALL HAVE STONED INLET PROTECTION AROUND THEM AND GEOTEXTILE FABRIC OVER THE GRATE TO PREVENT SEDIMENTATION FROM ENTERING THE STORM SYSTEM.
- 13. TILL ALL COMPACTED SOILS LOCATED IN LAWN AREAS TO RESTORE THE ORIGINAL PROPERTIES OF THE SOIL PRIOR TO SEEDING.

### **LEGEND**

<b>EXISTING</b>	<b>PROPOSED</b>	<b>DESCRIPTION</b>
		REMOVE AND DISPOSE OF APSHALT
		REMOVE AND DISPOSE OF CONCRET SIDEWALKS AND CURBS
	Ø	OBJECT REMOVAL
	Ø	TREE REMOVAL
		SAWCUT
		TREE PROTECTION
		ASPHALT PAVEMENT
		CONCRETE
0	•	BOLLARD
þ	•	SIGN
<del></del>	<del>-</del> X	CHAIN LINK FENCE
€~}	Ø	DECIDUOUS TREE
*	**	CONIFEROUS TREE
γήν\ 	~~~~~~	TREE/VEGITATION LIMIT
BLDG	BLDG	BUILDING/STRUCTURE
<u> </u>	<u> </u>	PROPERTY LINE
- — РЕ — - — — РЕ — - — —	—— — PE —— —	EASEMENTS
	— — <i>ROW.</i> — — —	RIGHT-OF-WAY
0-	•=	LIGHT POLE
MH HH	МН НН	STRUCTURE/ HANDHOLE
	ш	CATCH BASIN
	<b>(iii)</b>	INLET MANHOLE
		MANHOLE (SOLID COVER)
ST CO <sub>o</sub>	ST CO	CLEAN OUT
DS <sub>o</sub>	DS	DOWN SPOUT
$\triangle$		HYDRANT
$\bowtie$	H	VALVE
—	стvстv	CATV
-соммсомм	сомм	COMMUNICATIONS
F0F0	F0F0	FIBER OPTICS
SIG		SIGNAL LINE
тт	тт	TELEPHONE LINE
UE		UNDERGROUND ELECTRIC
		GAS LINE
SA	SA	SANITARY LINE
ST	ST	STORM LINE
FS	FS-	HOLLY LINE
w		DOMESTIC WATER LINE
	<b>←</b> 510 <b>←</b>	MAJOR CONTOUR
— <i>–509</i> – — –	• 509 · •	MINOR CONTOUR
505		EROSION FENCE
	<b>→</b>	
		TEMPORARY INLET PROTECTION TEMPORARY STABILIZED CONSTRUCTION ENTRANCE

#### DRAWING INDEX

#### COO1 GENERAL NOTES, LEGEND, AND DRAWING INDEX

CONSTRUCTION ENTRANCE

C101 EXISTING CONDITIONS PLAN

C201 SITE PLAN

C202 SITE PLAN

C301 UTILITY PLAN

C401 GRADING AND EROSION CONTROL PLAN

C501 CONSTRUCTION DETAILS

C502 CONSTRUCTION DETAILS

C503 CONSTRUCTION DETAILS

C504 CONSTRUCTION DETAILS

C505 CONSTRUCTION DETAILS

C506 CONSTRUCTION DETAILS





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**VIDA - BUILDINGS** A AND B

> 2 ADVENTURE PLACE ROCHESTER, NEW YORK

> > 14607


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GENERAL NOTES, LEGEND AND DRAWING INDEX

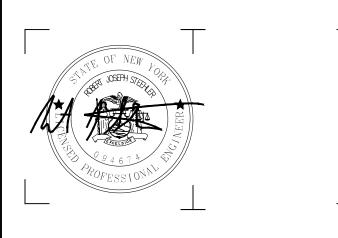

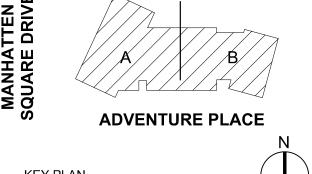

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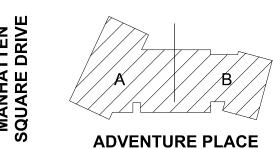


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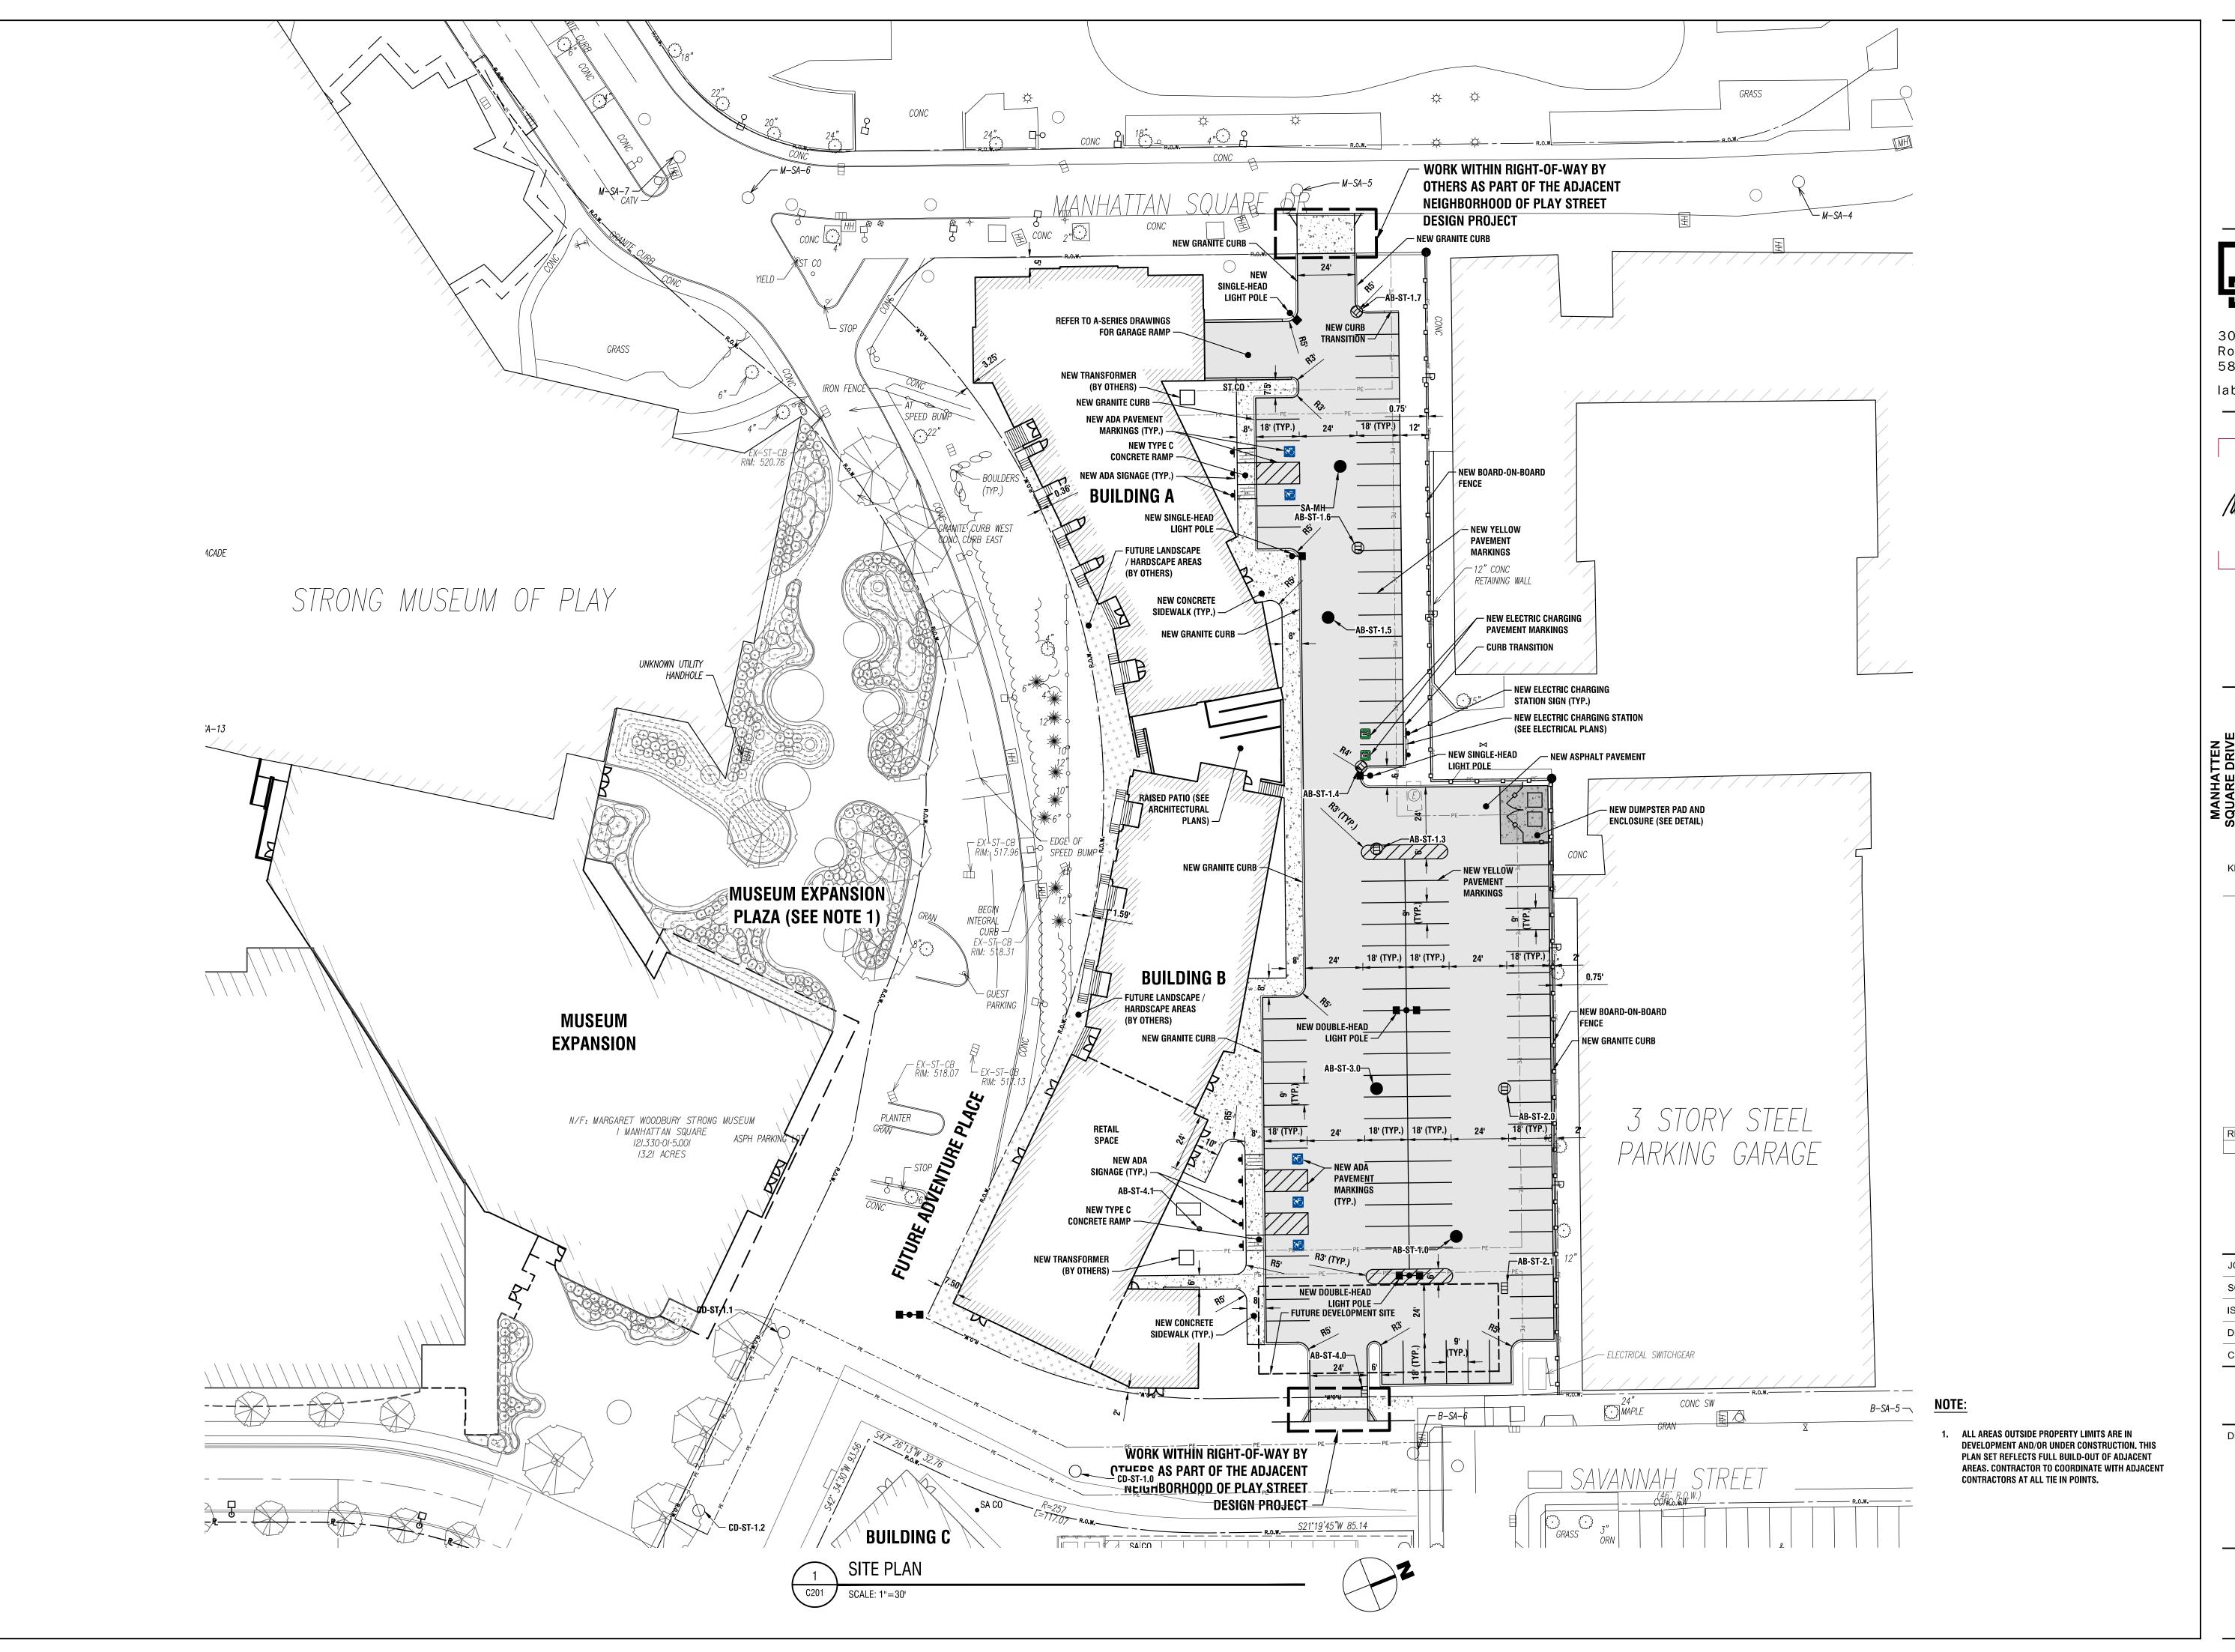
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EXISTING
CONDITIONS AND
DEMOLITION PLAN

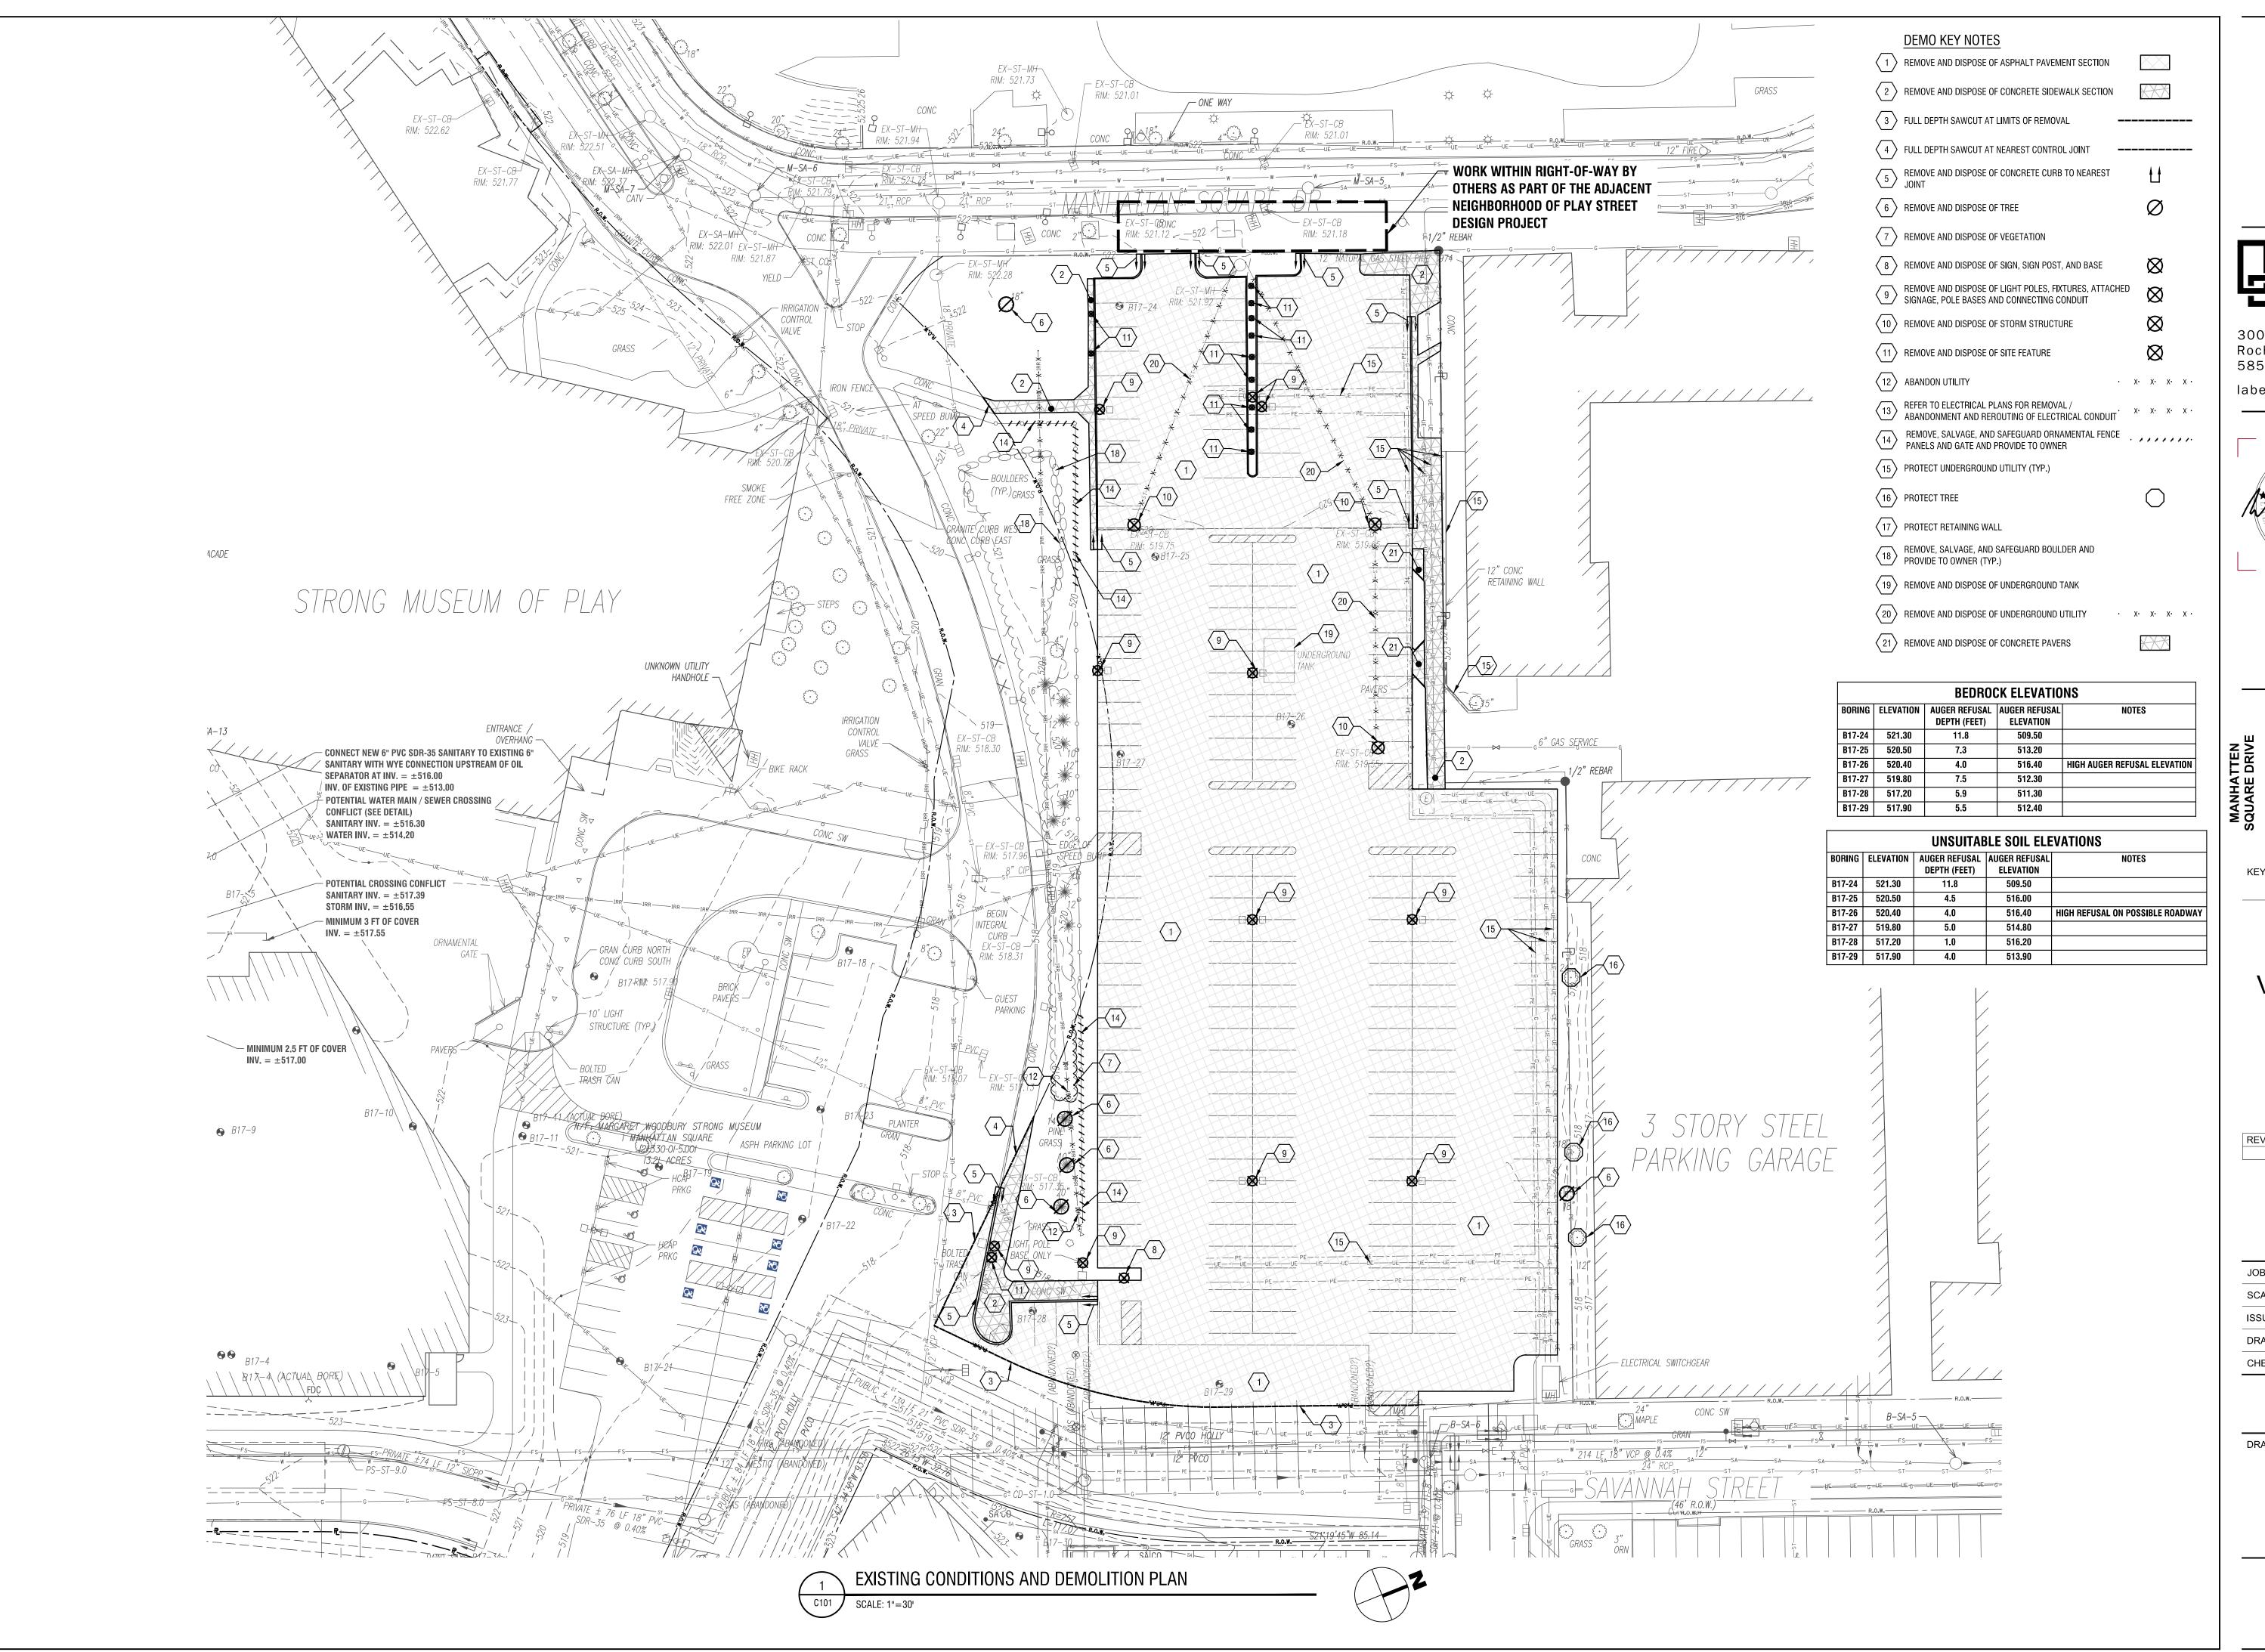C101








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KEY PLAN

KONAR PROPERTIES

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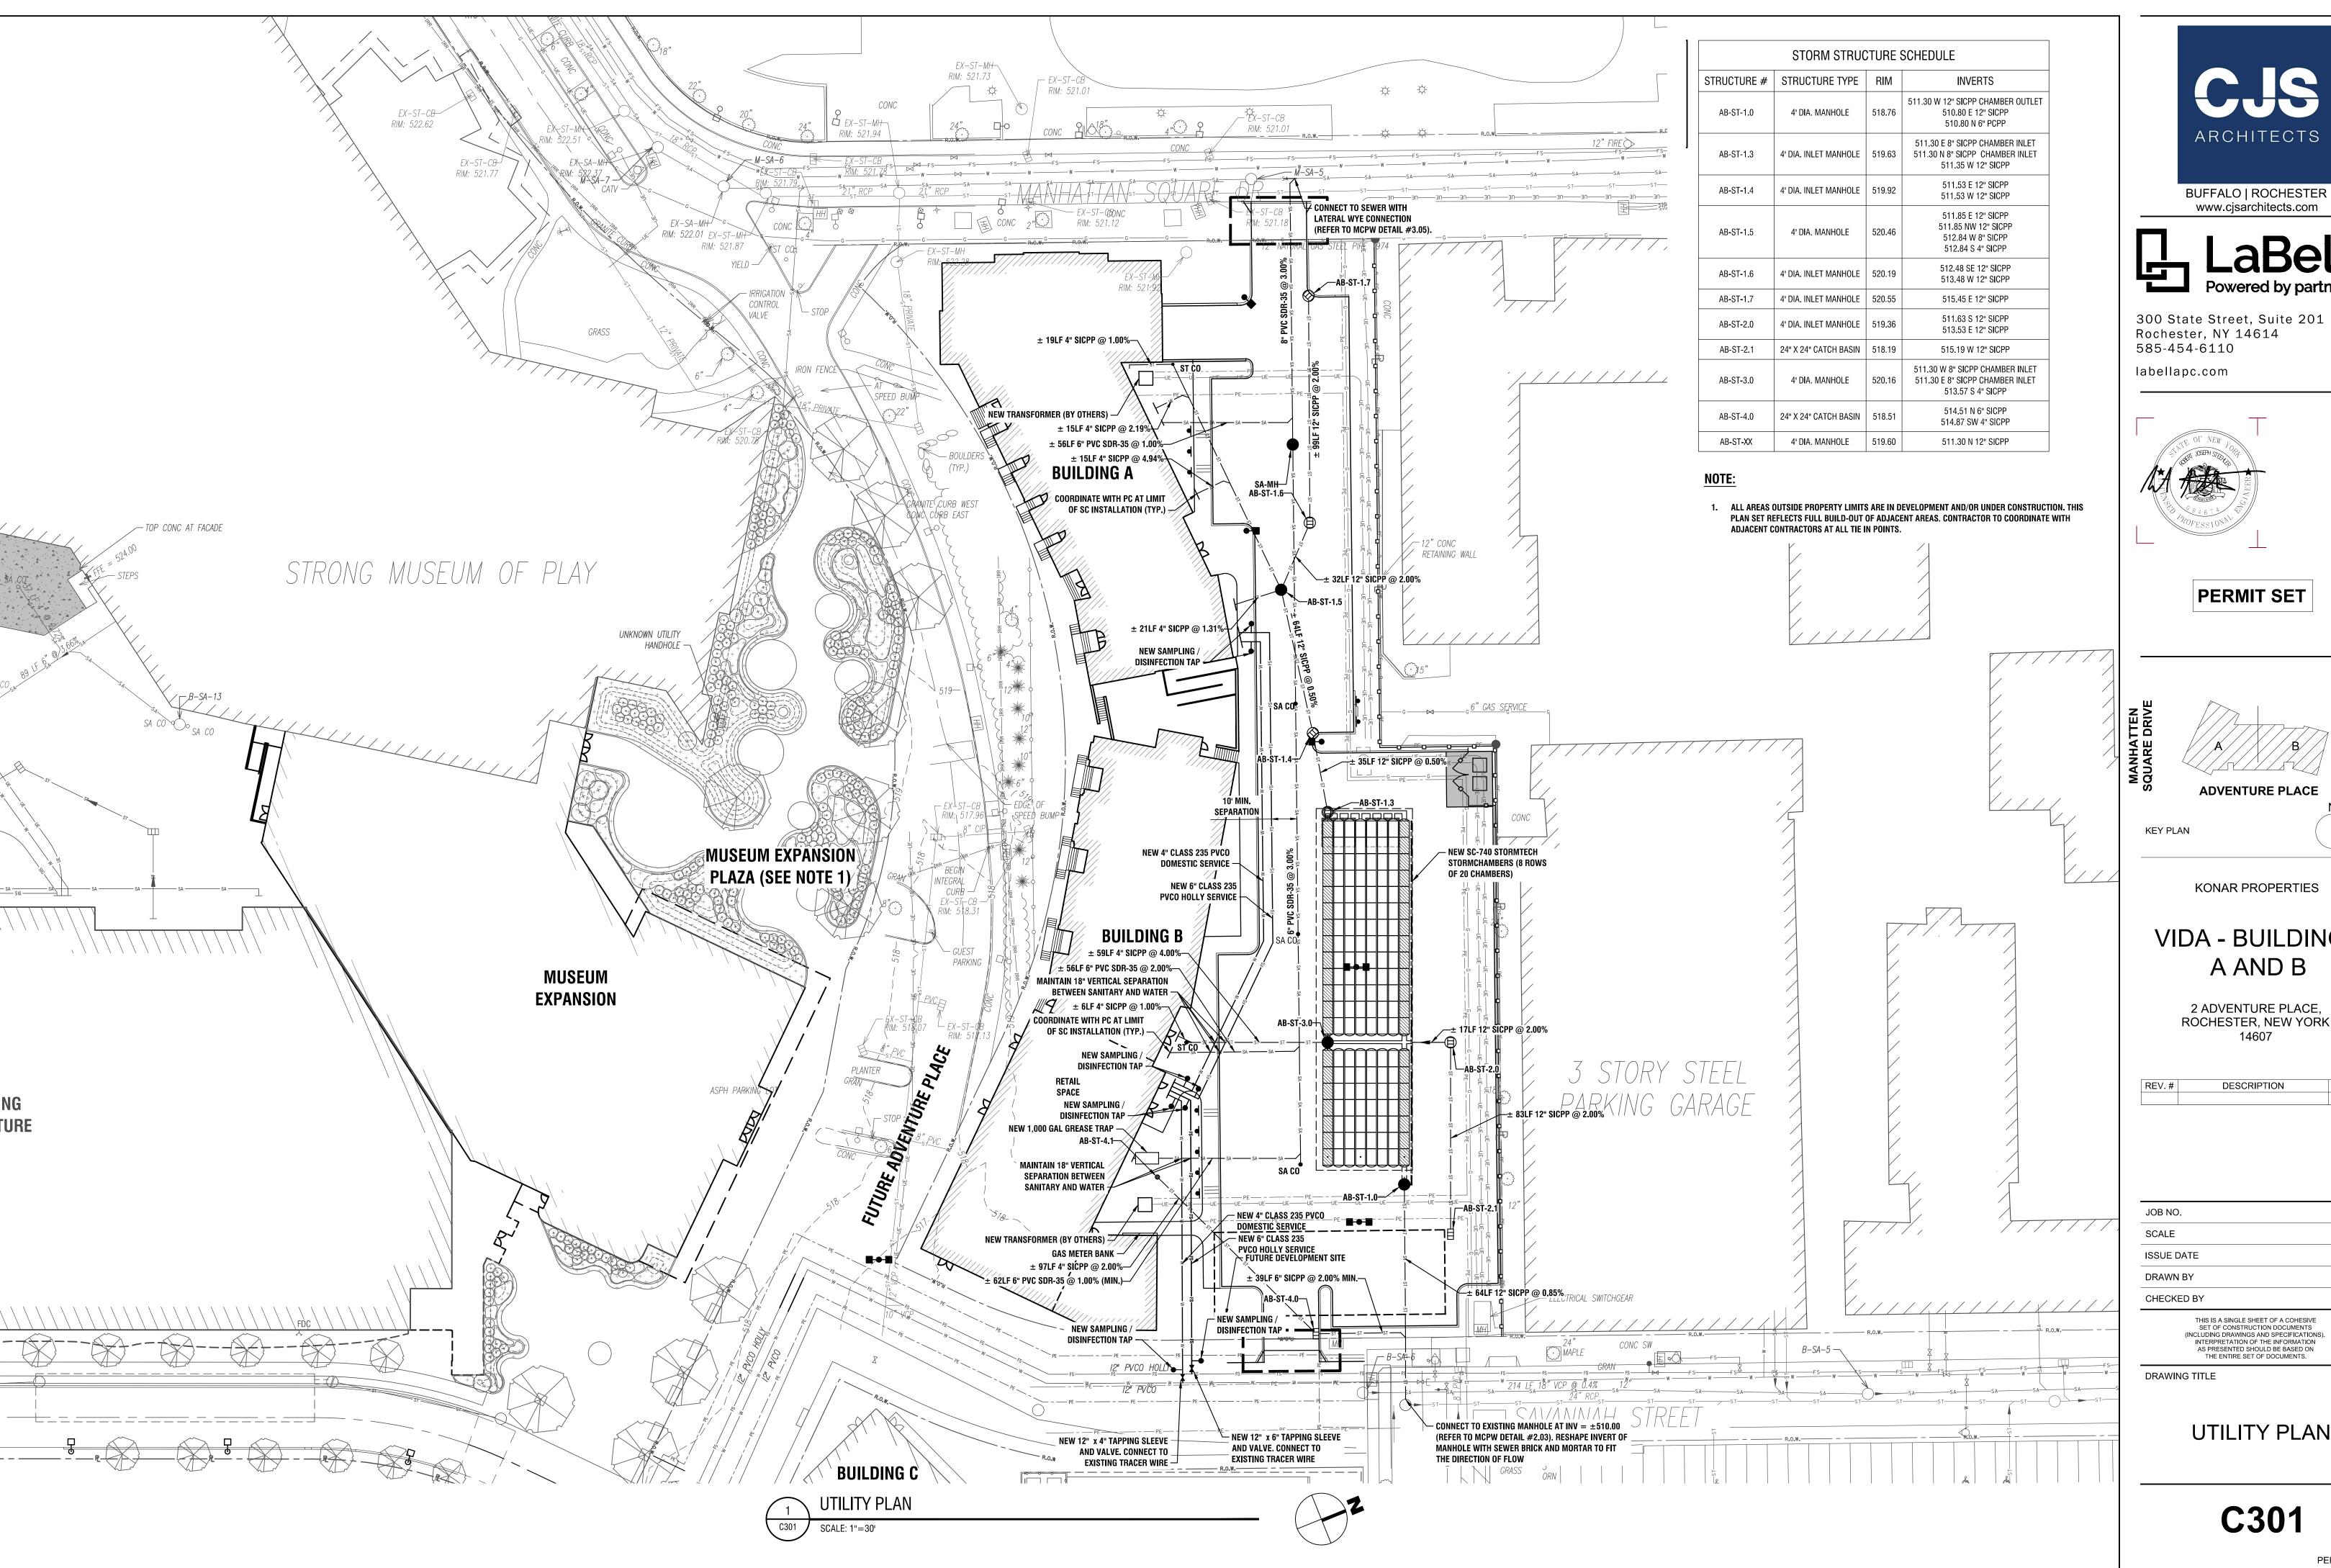
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SCALE	
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CHECKED BY	RJS


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DRAWING TITLE

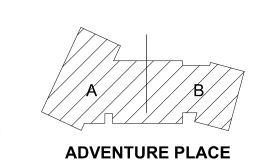SITE PLAN

C201



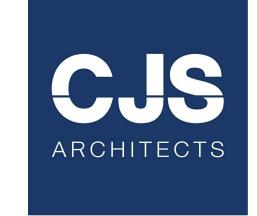

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ADVENTURE PLACE

**KONAR PROPERTIES** 

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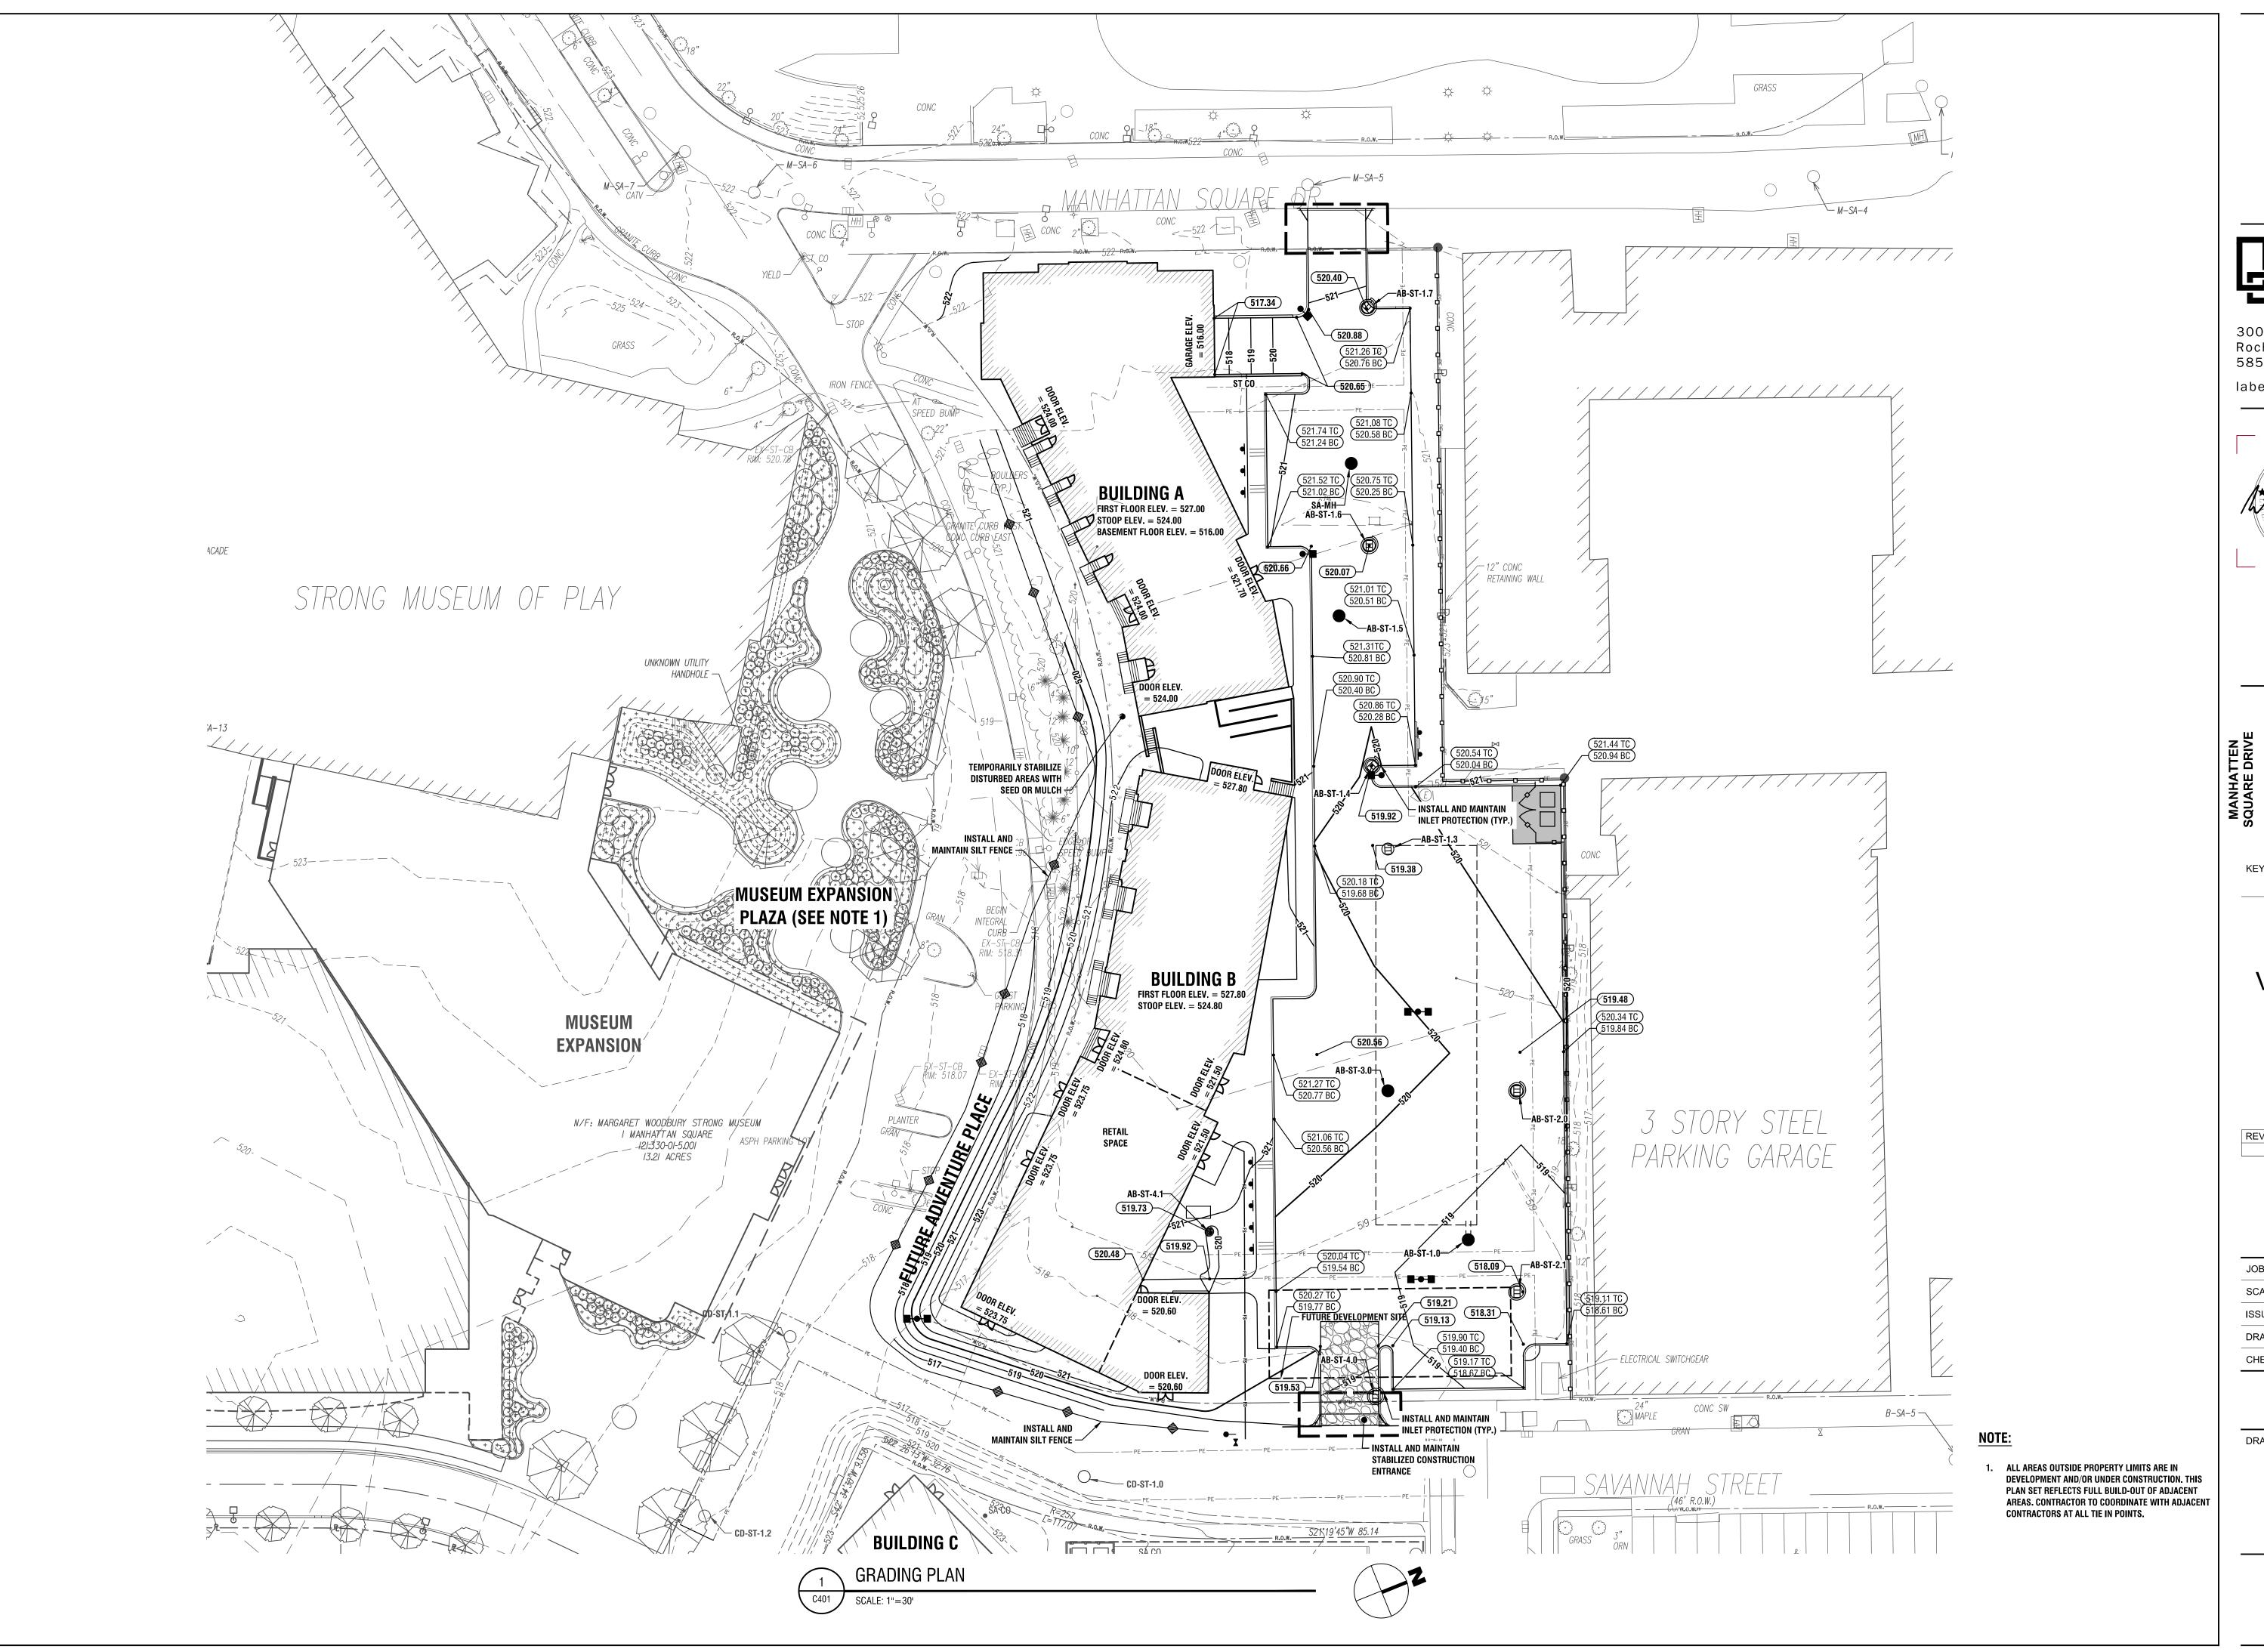
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**UTILITY PLAN** 

C301








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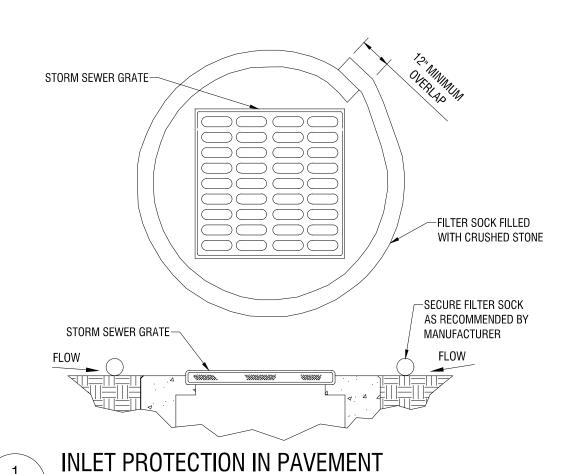
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**GRADING PLAN** 

C401



C501 N.T.S.

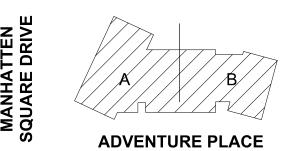SECTION B-B  $\frac{1}{8}$ " DIA. STEEL WIRE\_ STAPLE DETAIL BINDING WIRE-(2 PER BALE) STRAW BALE -IMPERMEABLE SHEETING - -IMPERMEABLE STRAW BALE SHEETING-WOOD OR-(TYP.) METAL STAKES (2 PER BALE) CAN BE TWO STACKED BALES OR PARTIALLY EXCAVATED TO

CONCRETE WASHOUT AREA WITH STRAW BALES

#### CONSTRUCTION SPECIFICATIONS

- 1. LOCATE WASHOUT STRUCTURE AS DIRECTED BY OWNER'S REPRESENTATIVE AND / OR CONSTRUCTION
- 2. SIZE WASHOUT STRUCTURE FOR VOLUME NECESSARY TO CONTAIN WASH WATER AND SOLIDS AND MAINTAIN AT LEAST 4 INCHES OF FREEBOARD. TYPICAL DIMENSIONS ARE 10 FEET X 10 FEET X 3 FEET
- FOR LINER. USE 10 MIL OR THICKER UV RESISTANT. IMPERMEABLE SHEETING, FREE OF HOLES AND TEARS
- PROVIDE A SIGN FOR THE WASHOUT IN CLOSE PROXIMITY TO THE FACILITY LIQUIDS THAT HAVE NOT EVAPORATED AND DISPOSE OF IN AN APPROVED MANNER. PRIOR TO FORECASTED RAINSTORMS, REMOVE LIQUIDS OR COVER STRUCTURE TO PREVENT OVERFLOWS. REMOVE HARDENED SOLIDS, WHOLE OR BROKEN UP, FOR DISPOSAL OR RECYCLING. MAINTAIN RUNOFF DIVERSION

SYMBUL

36' MIN LENGTH FENCE

POSTS DRIVEN MIN. 16\*

INTO GROUND.

18° MIN.

16"MIN.

HEIGHT OF FILTER

— UNDISTURBED GROUND.

REINFORCED

SILT FENCE

WOVEN WIRE FENCE

CMIN. 14 GAUGE W/ MAX. 6' MESH

SPACING)

SECTION VIEW

CONSTRUCTION SPECIFICATIONS

1. WOVEN WIRE FENCE TO BE FASTENED SECURELY TO FENCE POSTS WITH WIRE TIES

OR STAPLES. POSTS SHALL BE STEEL EITHER "T" OR "U" TYPE OR HARDWOOD.

SPACED EVERY 24" AT TOP AND MID SECTION, FENCE SHALL BE WOVEN WIRE,

3. WHEN TWO SECTIONS OF FILTER CLOTH ADJOIN EACH OTHER THEY SHALL BE OVER-

LAPPED BY SIX INCHES AND FOLDED. FILTER CLOTH SHALL BE EITHER FILTER X,

2. FILTER CLOTH TO BE FASTENED SECURELY TO WOVEN WIRE FENCE WITH TIES

5. MAINTENANCE SHALL BE PERFORMED AS NEEDED AND MATERIAL REMOVED WHEN

10" MAX. C. TO C.

VOVEN WIRE FENCE (MIN. 14 -

SPACING) WITH FILTER CLOTH

GAUGE W/ MAX. 6' MESH

36" MIN. FENCE POST -

COMPACTED SOIL ---

EMBED FILTER CLOTH


MIRAFI 100X, STABILINKA T140N, DR APPROVED EQUIVALENT.


4. PREFABRICATED UNITS SHALL MEET THE MINIMUM REQUIREMENTS SHOWN.


A MIN. OF 6" IN GROUND.

AROUND EXCAVATED WASHOUT STRUCTURE UNTIL STRUCTURE IS REMOVED.

# CONSTRUCTION - FENCE SHALL BE LOCATED TO PROTECT SAFETY FENCE -TREE CANOPY

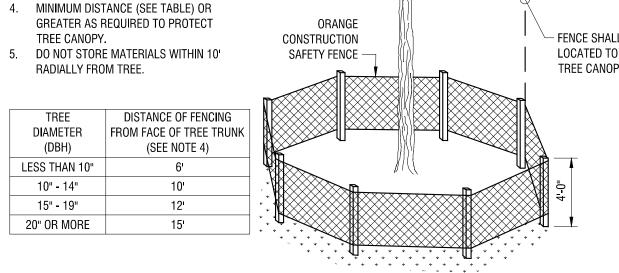

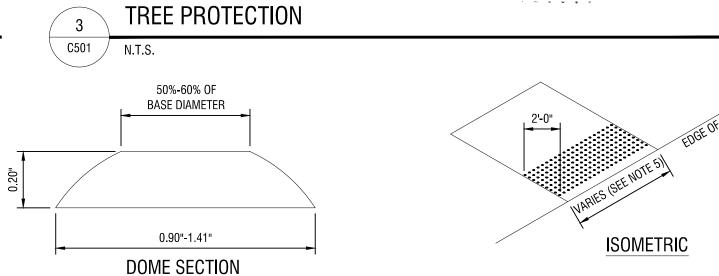

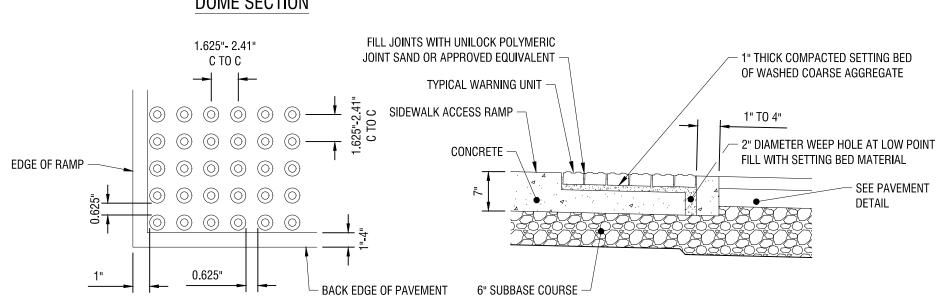

DOME SPACING **SECTION** 

1. QUANTITY OF TRUNCATED DOMES SHOWN IS FOR ILLUSTRATIVE PURPOSES ONLY AND TO DEPICT REQUIRED SQUARE GRID PATTERN. TRUNCATED DOMES ARE TO BE ALIGNED ON THE SQUARE GRID PATTERN IN THE PREDOMINANT DIRECTION OF TRAVEL. ENTIRE DETECTABLE WARNING SYSTEM FIELD, INCLUDING TRUNCATED DOMES, IS TO BE DARK GRAY IN COLOR, N7 PER MUNSELL BOOK NOTATION, OR APPROVED EQUIVALENT. 4. OUTER EDGE OF THE DETECTABLE WARNING SYSTEM FIELD IS TO BE LOCATED SO THAT THE EDGE OF THE WARNING FIELD NEAREST TO THE STREET IS 1 TO 4 INCHES BEHIND THE BACK

5. DETECTABLE WARNING SYSTEM IS TO EXTEND ACROSS THE FULL WIDTH OF A SIDEWALK ACCESS RAMP, BUT NOT UP THE SIDE FLARES.

BRICK DETECTABLE WARNING SYSTEM AT PAVEMENT C501 / N.T.S.

NOTES:

C501

NOTES:

1. ALL TREES DESIGNATED FOR PROTECTION ADJACENT TO

TREE CANOPY.

TREE CANOPY.

DIAMETER

(DBH)

LESS THAN 10"

10" - 14" 15" - 19"


20" OR MORE


CONSTRUCTION ACTIVITY 2. DO NOT LEAVE CONSTRUCTION

3. MAINTAIN 1' FENCE CLEARANCE TO OUTSIDE CURB FACE AND 6" TO 12"

FENCE CLEARANCE TO SIDEWALK.

**EQUIPMENT RUNNING (IDLING) UNDER** 

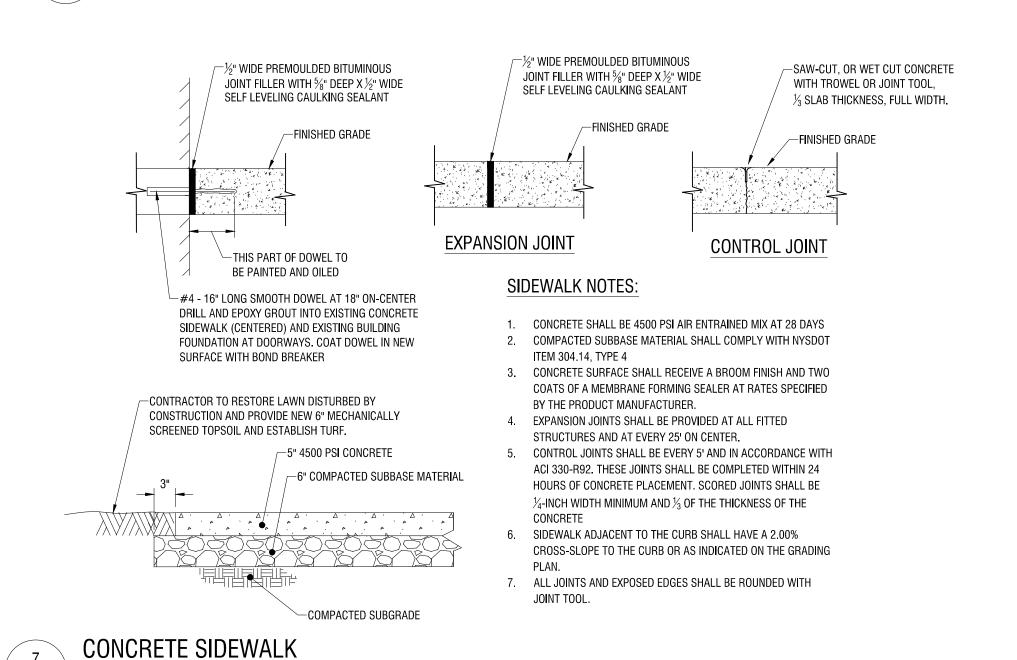

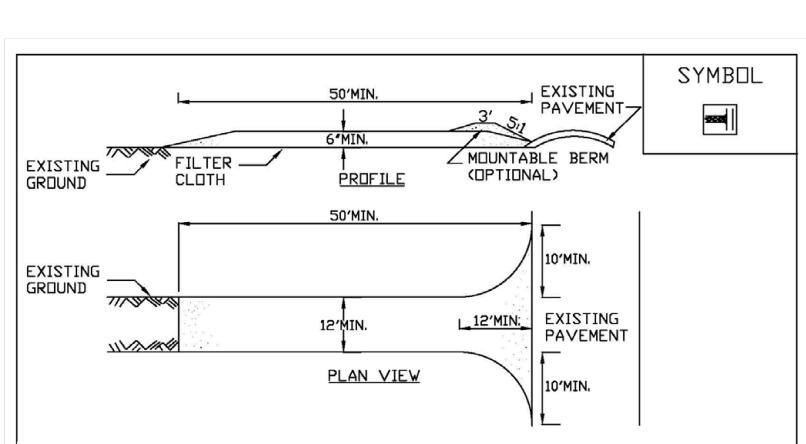

### CONSTRUCTION SPECIFICATIONS

- 1. STONE SIZE USE 1-4 INCH STONE, OR RECLAIMED OR RECYCLED CONCRETE **EQUIVALENT**
- 2. LENGTH NOT LESS THAN 50 FEET (EXCEPT ON A SINGLE RESIDENCE LOT WHERE A 30 FOOT MINIMUM LENGTH WOULD APPLY).
- 3. THICKNESS NOT LESS THAN SIX (6) INCHES.
- 4. WIDTH TWELVE (12) FOOT MINIMUM, BUT NOT LESS THAN THE FULL WIDTH AT PDINTS WHERE INGRESS OR EGRESS OCCURS, TWENTY-FOUR (24) FOOT IF SINGLE ENTRANCE TO SITE.
- 5. GEOTEXTILE WILL BE PLACED OVER THE ENTIRE AREA PRIOR TO PLACING OF STONE.
- 6. SURFACE WATER ALL SURFACE WATER FLOWING OR DIVERTED TOWARD CON-STRUCTION ACCESS SHALL BE PIPED BENEATH THE ENTRANCE, IF PIPING IS IMPRACTICAL, A MOUNTABLE BERM WITH 5:1 SLOPES WILL BE PERMITTED.
- '. MAINTENANCE THE ENTRANCE SHALL BE MAINTAINED IN A CONDITION WHICH WILL PREVENT TRACKING OR FLOWING OF SEDIMENT ONTO PUBLIC RIGHTS-OF-WAY, ALL SEDIMENT SPILLED, DROPPED, WASHED OR TRACKED ONTO PUBLIC RIGHTS-OF-WAY MUST BE REMOVED IMMEDIATELY.
- 8. WHEN WASHING IS REQUIRED, IT SHALL BE DONE ON A AREA STABILIZED WITH STONE AND WHICH DRAINS INTO AN APPROVED SEDIMENT TRAPPING DEVICE.
- 9. PERIODIC INSPECTION AND NEEDED MAINTENANCE SHALL BE PROVIDED AFTER EACH RAIN.

ADAPTED FROM DETAILS PROVIDED BY: USDA - NRCS, NEW YORK STATE DEPARTMENT OF TRANSPORTATION, NEW YORK STATE DEPARTMENT OF ENVIRONMENTAL CONSERVATION, NEW YORK STATE SOIL & WATER CONSERVATION COMMITTEE	STABILIZE CONSTRUCT ACCESS

NDIT

REACH 3 FT DEPTH

C501 N.T.S.

REINFORCED SILT FENCE

C501

6' MAXIMUM MESH OPENING.

NYS STANDARD SPECIFICATIONS FOR EROSION AND SEDIMENT CONTROL FIGURE 5.30

ADAPTED FROM DETAILS PROVIDED BY: USDA - NRCS,

NEW YORK STATE DEPARTMENT OF TRANSPORTATION,

NEW YORK STATE DEPARTMENT OF ENVIRONMENTAL CONSERVATION,

NEW YORK STATE SOIL & WATER CONSERVATION COMMITTEE

'BULGES' DEVELOP IN THE SILT FENCE.

/ NYS STANDARD SPECIFICATIONS FOR EROSION AND SEDIMENT CONTROL FIGURE 2.01

STABILIZED CONSTRUCTION ACCESS

C501

PERMIT SET

**VIDA - BUILDINGS** A AND B 2 ADVENTURE PLACE, ROCHESTER, NEW YORK 14607 DESCRIPTION

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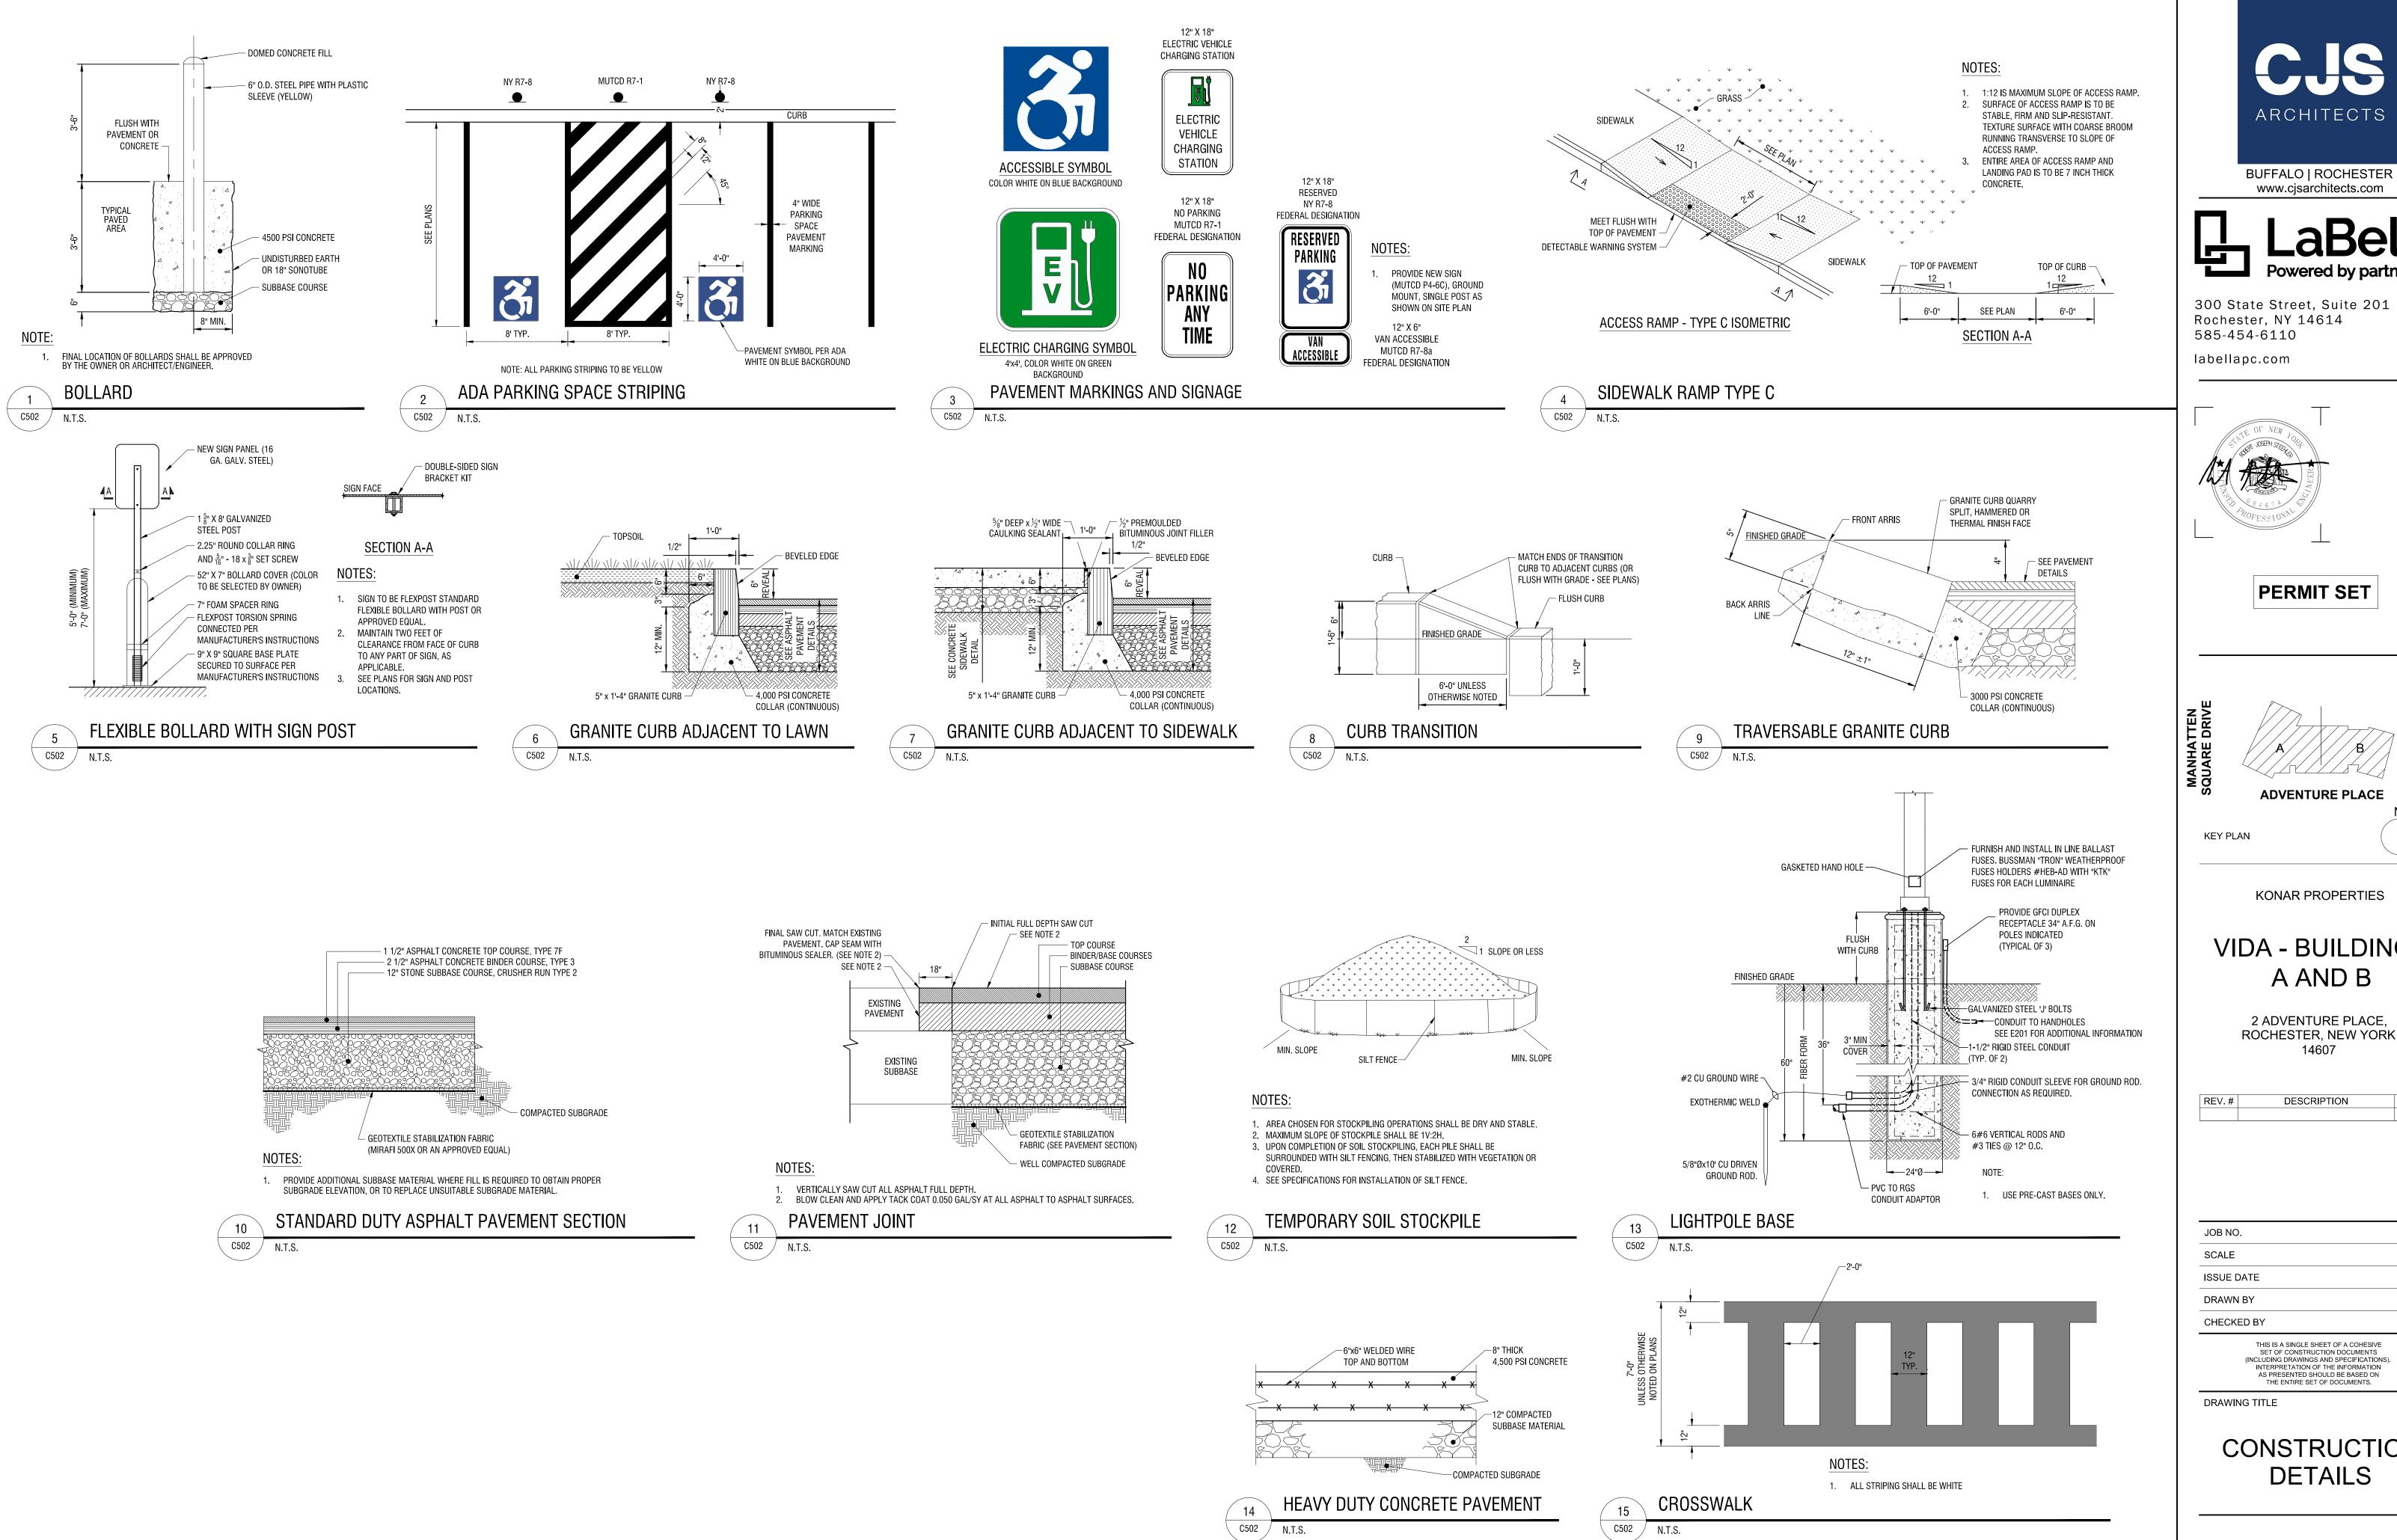
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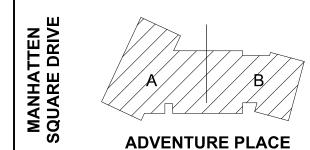
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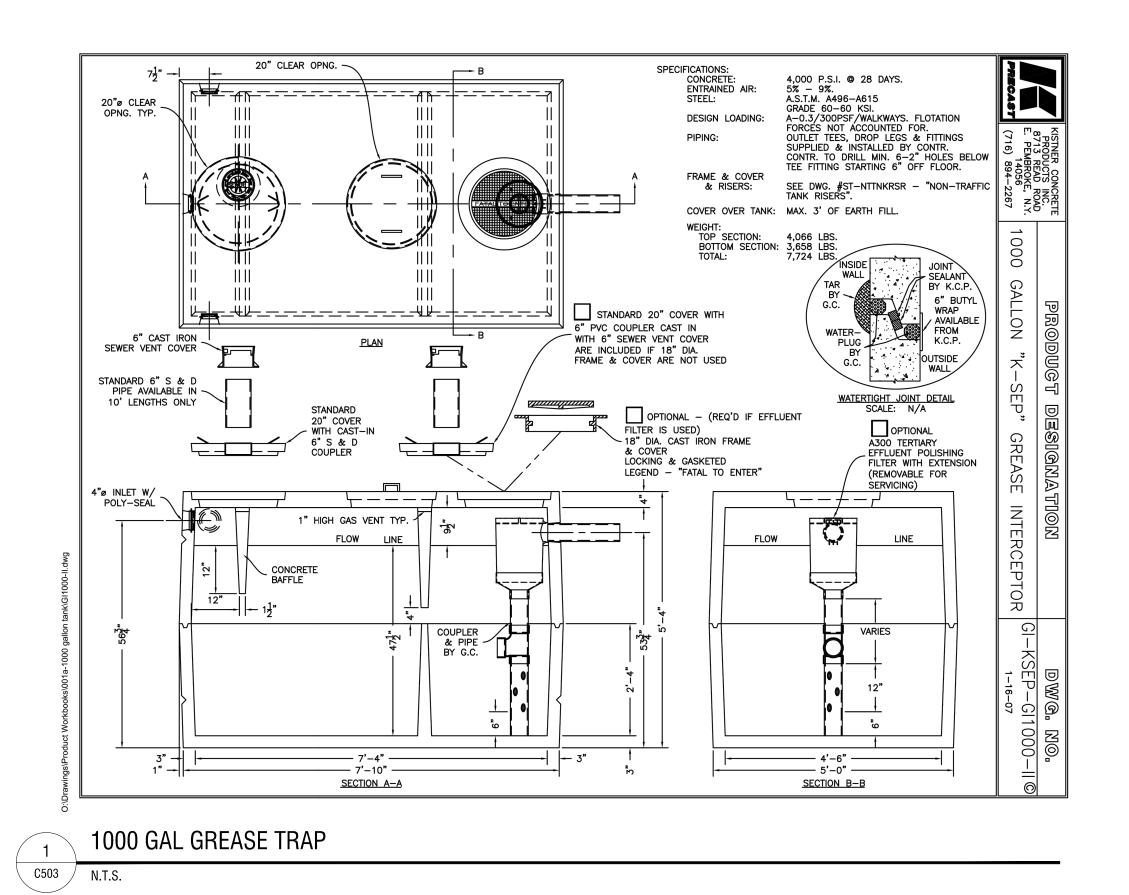
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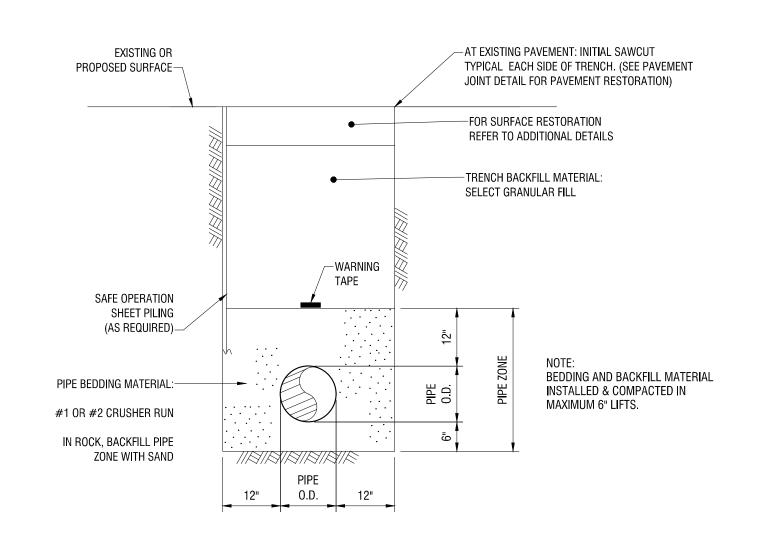
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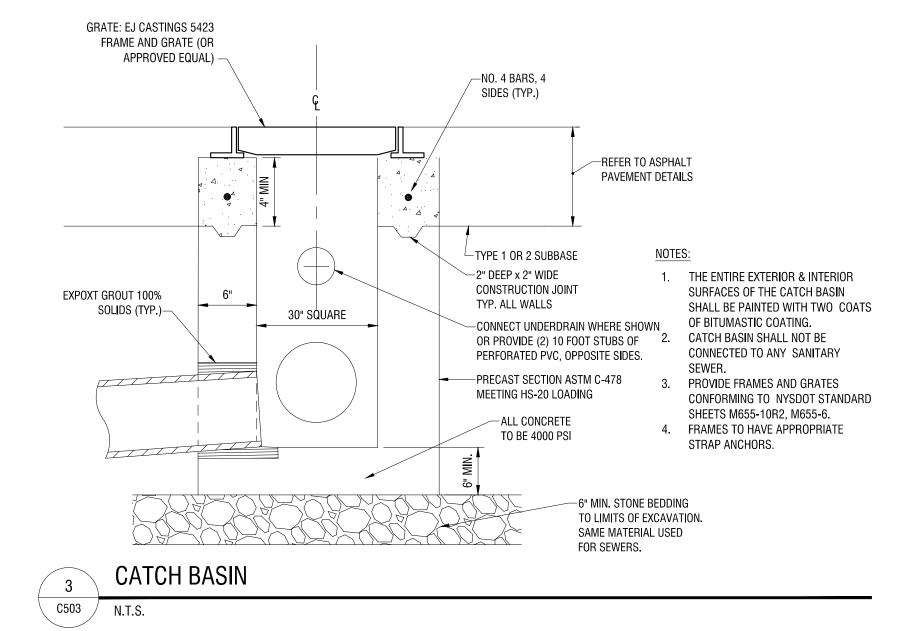
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CONSTRUCTION **DETAILS** 

C502








STORM SEWER TRENCH AND PIPE BEDDING

C503 N.T.S.


C503 N.T.S.

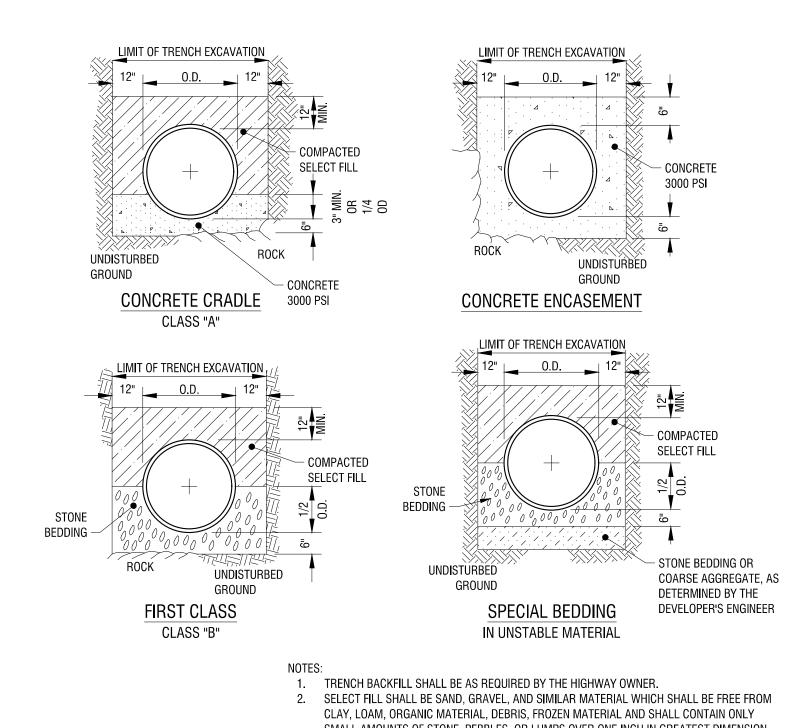


BUT NONE OVER TWO INCHES IN GREATEST DIMENSION.

3. STONE BEDDING SHALL MEAN APPROVED IMPORTED AGGREGATE MEETING THE

4. COARSE AGGREGATE SHALL MEAN APPROVED IMPORTED AGGREGATE MEETING THE

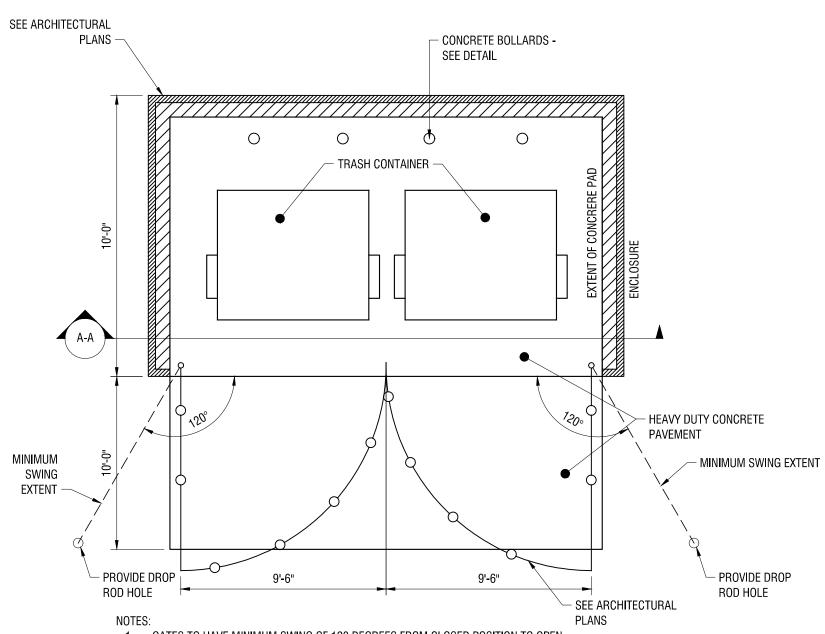

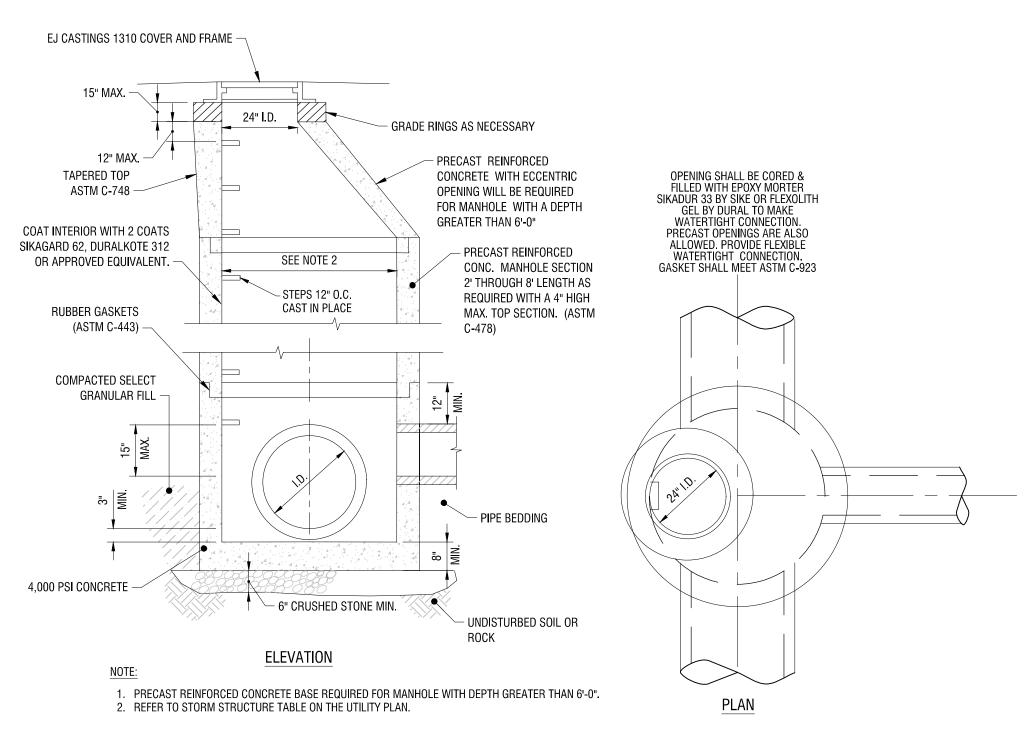

**CONCENTRIC STORM MANHOLE DETAIL** 

REQUIREMENTS OF THE NEW YORK STATE DEPARTMENT OF TRANSPORTATION, STANDARD 1. GATES TO HAVE MINIMUM SWING OF 120 DEGREES FROM CLOSED POSITION TO OPEN. REQUIREMENTS OF THE NEW YORK STATE DEPARTMENT OF TRANSPORTATION, STANDARD SPECIFICATION, "CRUSHED STONE", PRIMARY SIZE 3 OR A MIXTURE OF PRIMARY SIZE 3 AND DUMPSTER ENCLOSURE C503 N.T.S.




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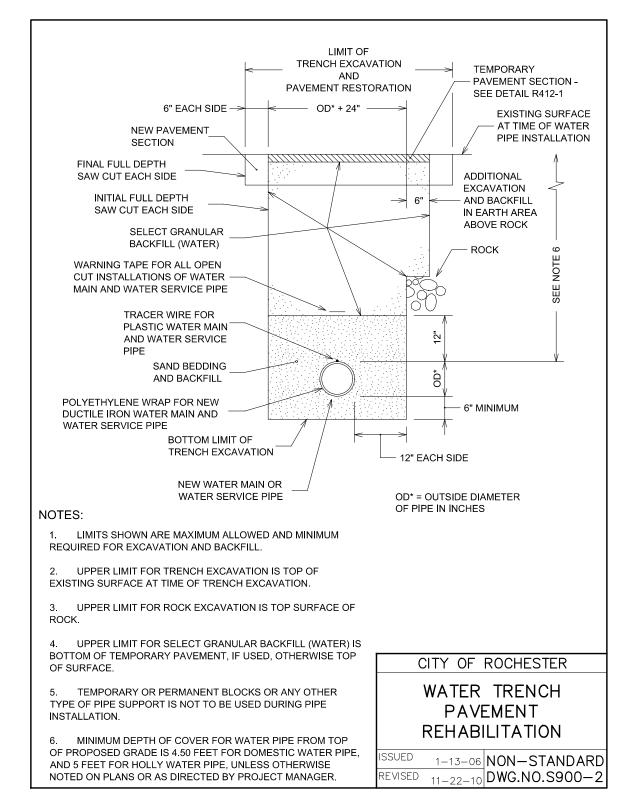
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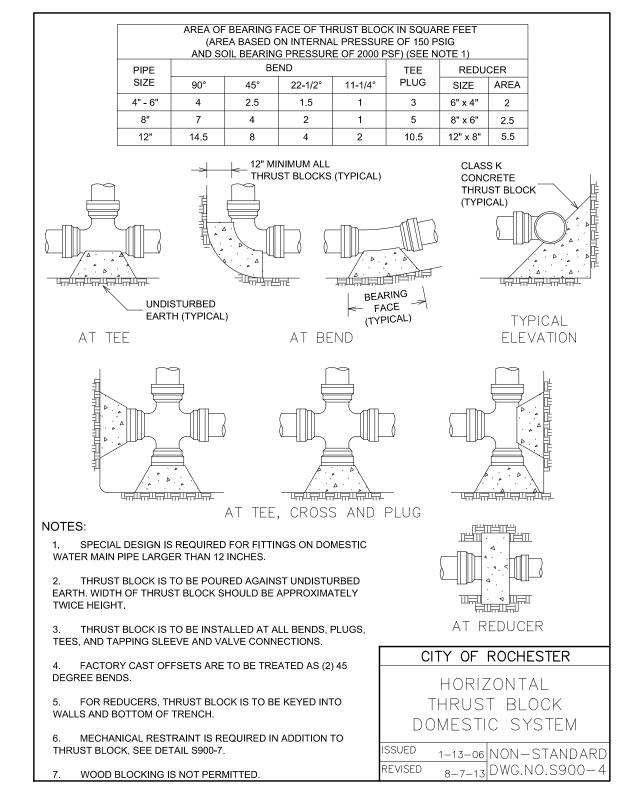
CONSTRUCTION **DETAILS** 


C503




CITY OF ROCHESTER DETAIL

LAYING CONDITION.

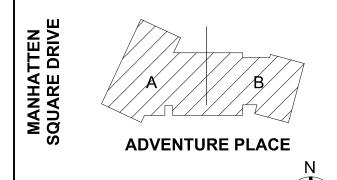

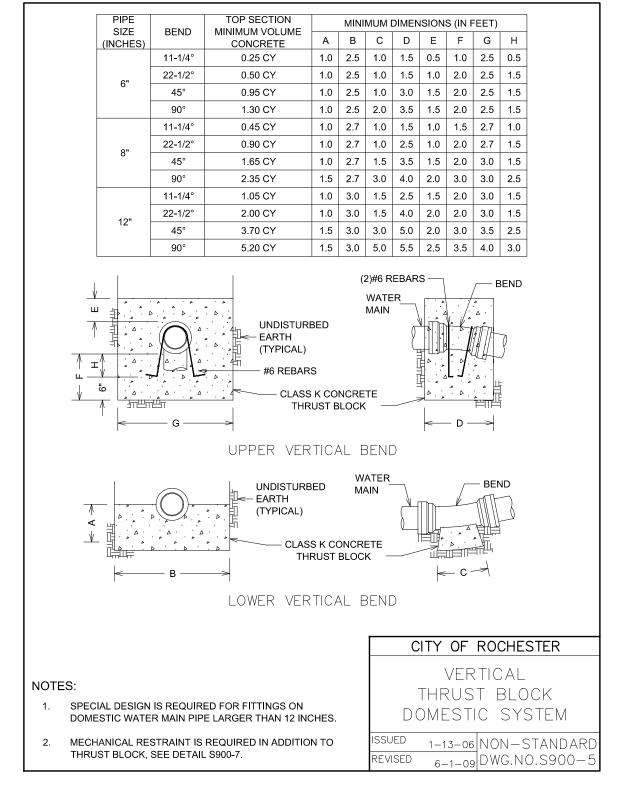

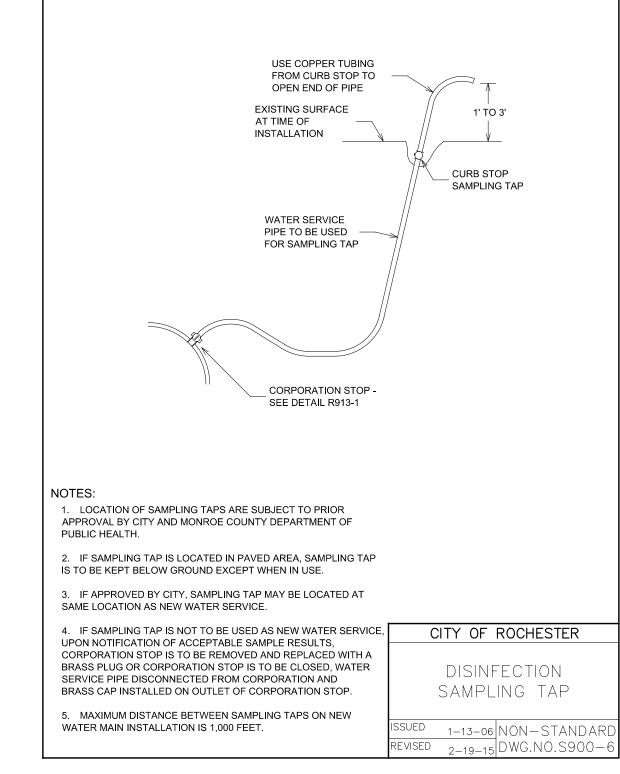



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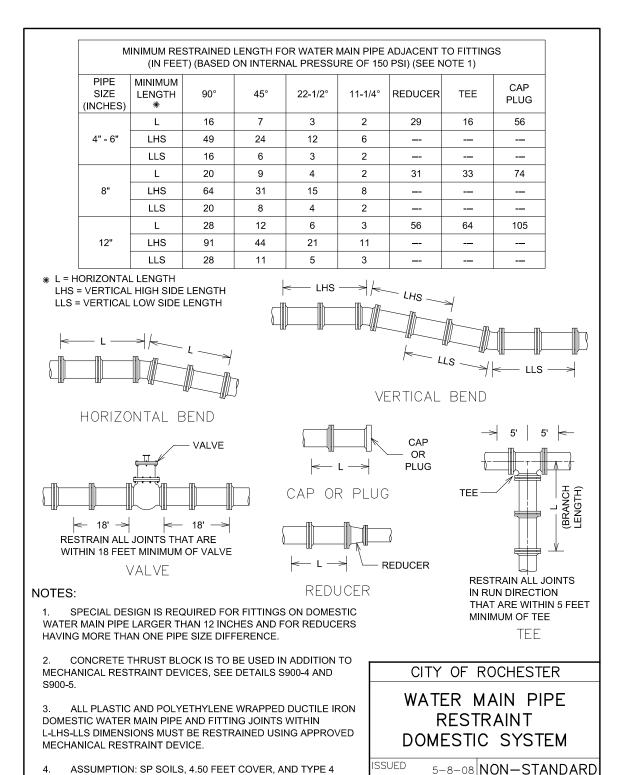
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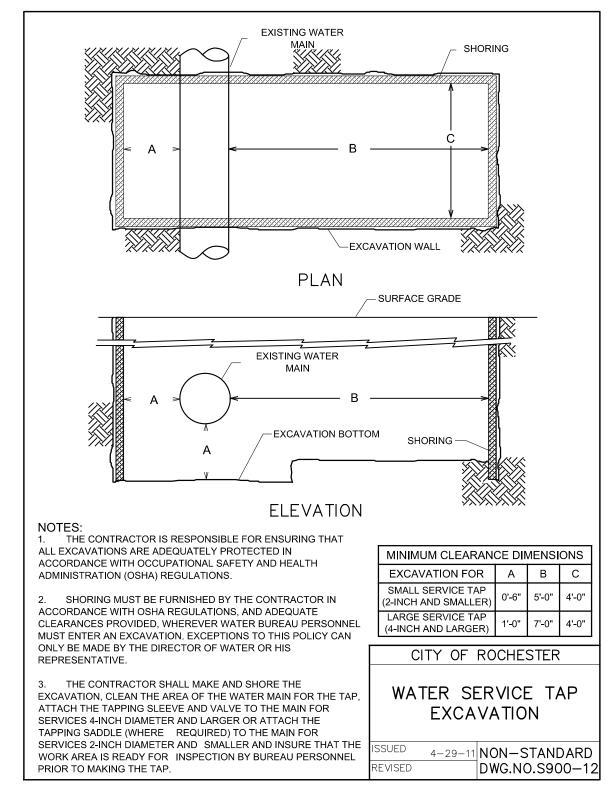
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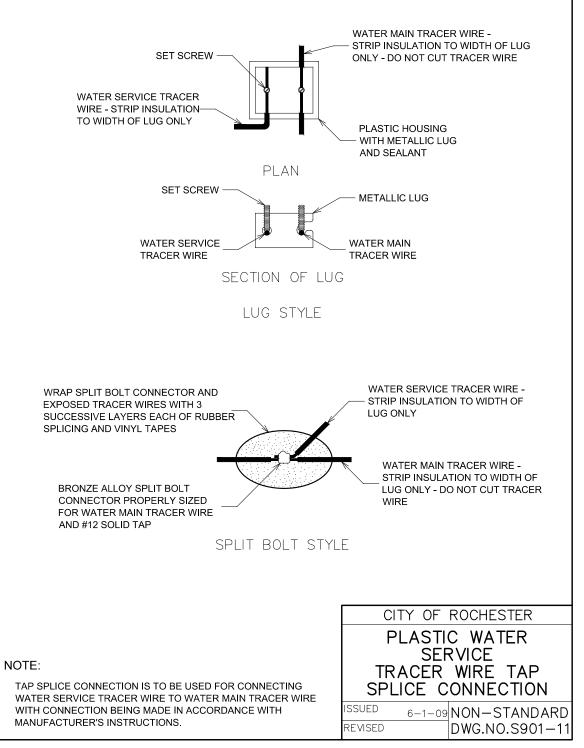
CONSTRUCTION **DETAILS** 


VERTICAL THRUST BLOCK DOMESTIC SYSTEM CITY OF ROCHESTER DETAIL CITY OF ROCHESTER DETAIL





VISED 9-1-09 DWG.NO.S900-






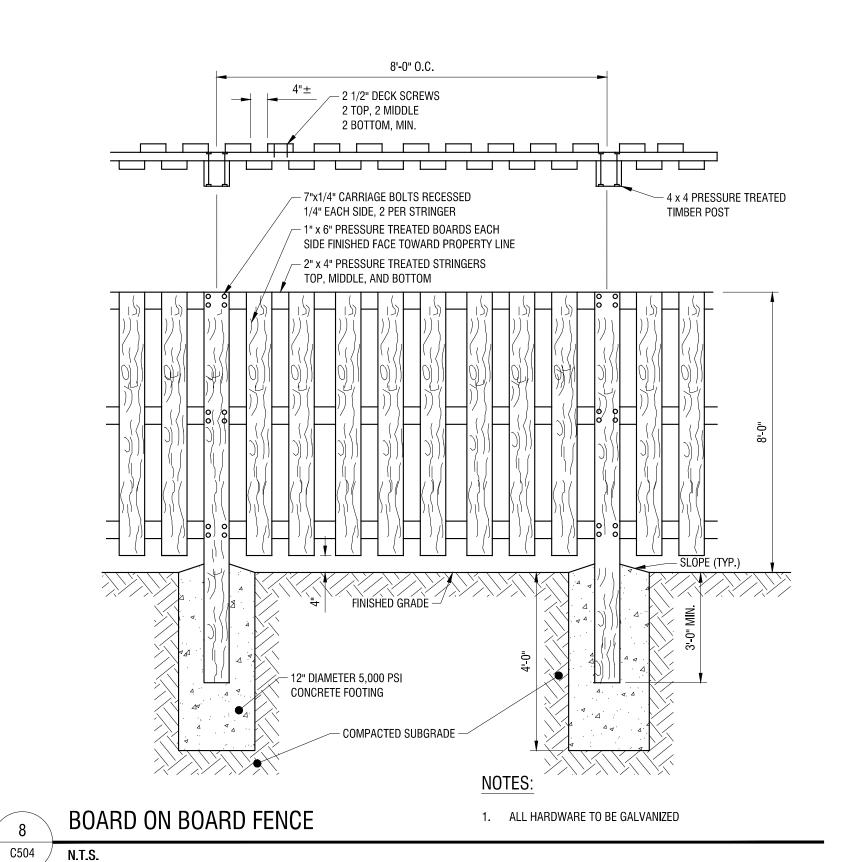


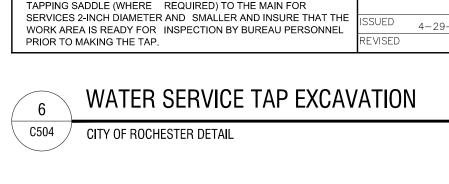

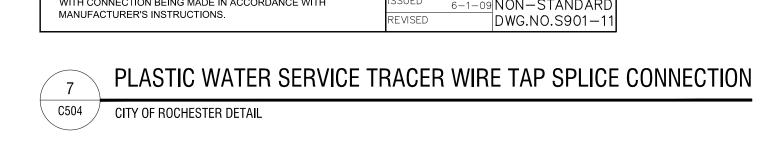



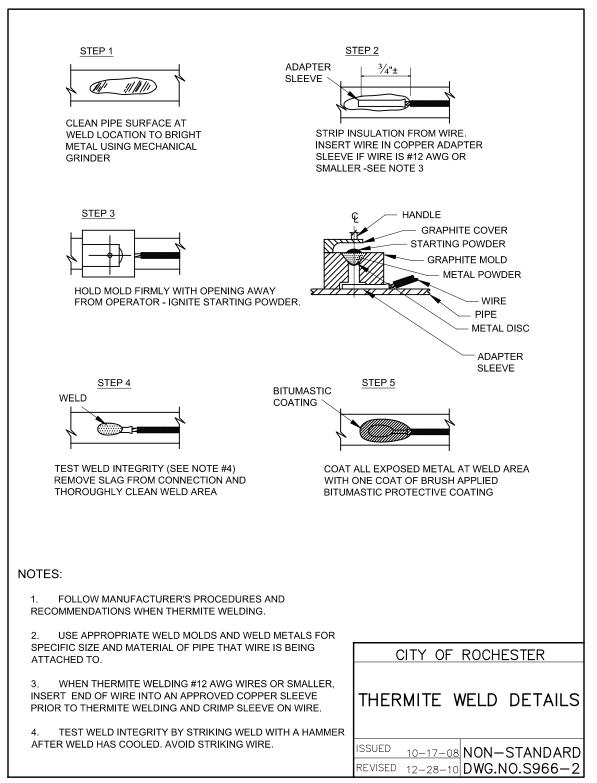

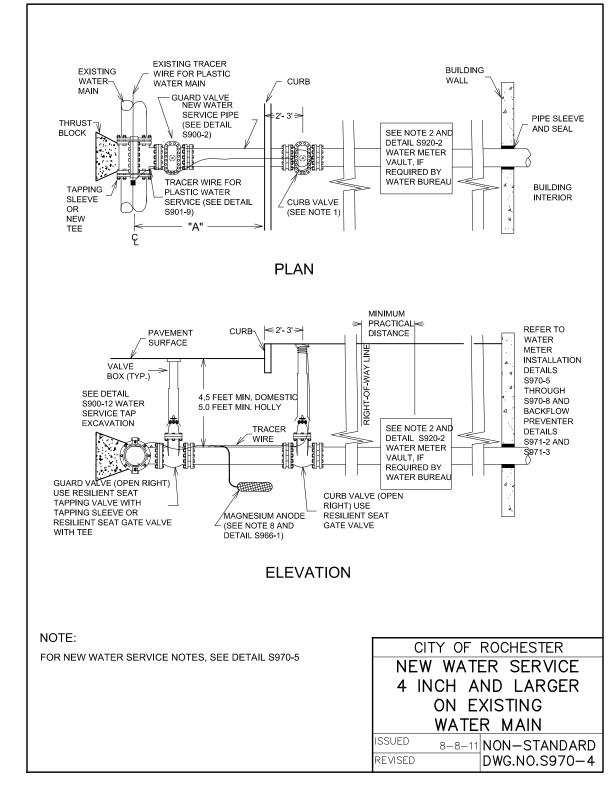

MINIMUM RESTRAINED LENGTH FOR WATER MAIN PIPE ADJACENT TO FITTINGS

(IN FEET) (BASED ON INTERNAL PRESSURE OF 250 PSI) (SEE NOTE 1)

L 30 13 6 3 47 70

LHS | 138 | 66 | 32 | 16 | -- | --

LHS 96 46 23 11 -- - --

LLS 30 12 6 3 -- - - -

43 | 16 | 8 | 4 | -- | -- |

90° | 45° | 22-1/2° | 11-1/4° | REDUCER | TEE | CAP PLUG

23 9 5 3 -- - -

43 18 9 5 84 117 159

← L → \ REDUCER

VERTICAL BEND

RESTRAIN ALL JOINTS

THAT ARE WITHIN 5 FEET

TEE

IN RUN DIRECTION

MINIMUM OF TEE

CITY OF ROCHESTER

WATER MAIN PIPE


RESTRAINT

HOLLY SYSTEM

<sup>JED</sup> 5-8-08 NON-STANDARI

VISED 9-1-09 DWG.NO.S900-8

NOTES: . IF DIMENSION "A" BETWEEN THE CENTERLINE OF THE WATER MAIN AND THE FACE OF CURB IS 6 FEET OR LESS. THE CURB VALVE IS NOT REQUIRED. CURB VALVE IS REQUIRED WHEN DIMENSION "A" EXCEEDS 6 FEET. 2. A METER VAULT MAY BE REQUIRED FOR A DOMESTIC SERVICE, WHEN THE WATER SERVICE LENGTH, AS MEASURED FROM THE STREET RIGHT-OF-WAY LINE TO THE BUILDING WALL, EXCEEDS 100 FEET. WHEN THE WATER SERVICE LENGTH EXCEEDS 100 FEET. THE WATER BUREAU WILL REVIEW EACH NEW WATER SERVICE PLAN TO DETERMINE IF THE METER SHOULD EITHER BE PLACED: INSIDE OF THE HEATED BUILDING: IN A METER VAULT OUTSIDE OF THE BUILDING NEAR THE RIGHT-OF-WAY LINE OR IN A HEATED ABOVE GROUND ENCLOSURE NEAR THE RIGHT-OF-WAY LINE. E. ALL JOINTS ON NEW WATER SERVICE PIPE, FITTINGS AND VALVES SHALL BE MECHANICALLY RESTRAINED. CONCRETE THRUST BLOCKS ARE ALSO REQUIRED AT FITTINGS PER DETAIL DRAWINGS \$900-4, \$900-5, S900-9 AND S900-10. 4. A BACKFLOW PREVENTION DEVICE IS REQUIRED ON ALL DOMESTIC WATER SERVICES 1½ AND LARGER. 5. NEW WATER SERVICE SHALL BE PRESSURE TESTED FROM GUARD VALVE TO WITHIN 5 FEET OF EXTERIOR BUILDING WALL PRESSURE TESTING SHALL BE PERFORMED IN ACCORDANCE WITH SPECIFICATION \$900-3.05. PIPE, FITTING AND VALVE JOINTS ON PORTION OF SERVICE NOT SUBJECT TO PRESSURE TEST SHALL BE LEAK TESTED AT NORMAL OPERATING PRESSURE. 6. WHEN THE LENGTH OF THE NEW WATER SERVICE EXCEEDS 50 FEET, WATER SERVICE SHALL BE DISINFECTED USING THE CONTINUOUS FEED METHOD IN ACCORDANCE WITH SPECIFICATION S900-3.06. FOR WATER SERVICES LESS THAN 50 FEET, ALL WATER SERVICE PIPE, FITTINGS AND VALVES SHALL BE SPRAY OR SWAB DISINFECTED WITH 1%-5% CHLORINE SOLUTION. . ON PLASTIC WATER SERVICES, WHEN DIMENSION "A" IS 6 FEET OR LESS AND THE CURB VALVE IS NOT EXTEND TRACER WIRE ALONG SERVICE TO RIGHT-OF-WAY LINE AND INSTALL TRACER WIRE TERMINATION BOX AT RIGHT-OF-WAY. 8. ONE MAGNESIUM ANODE IS TO BE INSTALLED ON EACH PIECE OF NEW DUCTILE IRON WATER SERVICE PIPE BETWEEN THE WATER MAIN AND RIGHT-OF-WAY LINE. SEE DETAIL \$966-2. USE 17 POUND ANODE ON 4 INCH AND 6 INCH PIPE, 32 POUND ANODE ON 8 INCH AND 10 INCH PIPE AND 48 POUND ANODE ON 12 INCH PIPE. 9. ALL DUCTILE IRON WATER SERVICE PIPE, FITTINGS AND VALVES LOCATED WITHIN THE STREET RIGHT-OF-WAY ARE TO BE INSTALLED IN POLYETHYLENE ENCASEMENT. 10. IF PLANS CALL FOR THE INSTALLATION OF A TAPPING SLEEVE AND VALVE, BUT THE WATER MAIN CAN NOT BE TAPPED DUE TO SPATIAL LIMITATIONS, A NEW SERVICE TEE WITH A SERVICE VALVE MAY NEED TO BE CUT INTO THE EXISTING WATER MAIN. 1 PROPOSED DEVIATIONS TO THE APPROVED PLANS REQUIRE WATER BUREAU AUTHORIZATION BEFORE BEGINNING THE WORK. CITY OF ROCHESTER NEW WATER SERVICE 4 INCH AND LARGER ON EXISTING WATER MAIN - NOTES SSUED 8-11-11 NON-STANDARD DWG.NO.S970-5

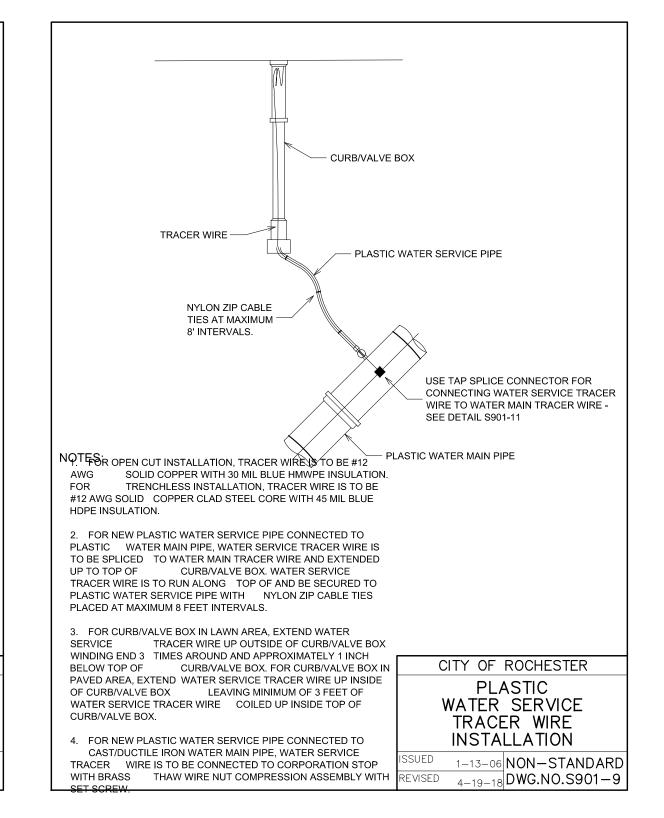

ADVENTURE PLACE

**KONAR PROPERTIES** 

VIDA - BUILDINGS A AND B

> 2 ADVENTURE PLACE, ROCHESTER, NEW YORK 14607


DESCRIPTION REV.#

1709 N.T.S. \_\_\_\_ 3/2020 LMB

> THIS IS A SINGLE SHEET OF A COHESIVE SET OF CONSTRUCTION DOCUMENTS (INCLUDING DRAWINGS AND SPECIFICATIONS) INTERPRETATION OF THE INFORMATION

CONSTRUCTION **DETAILS** 

C505

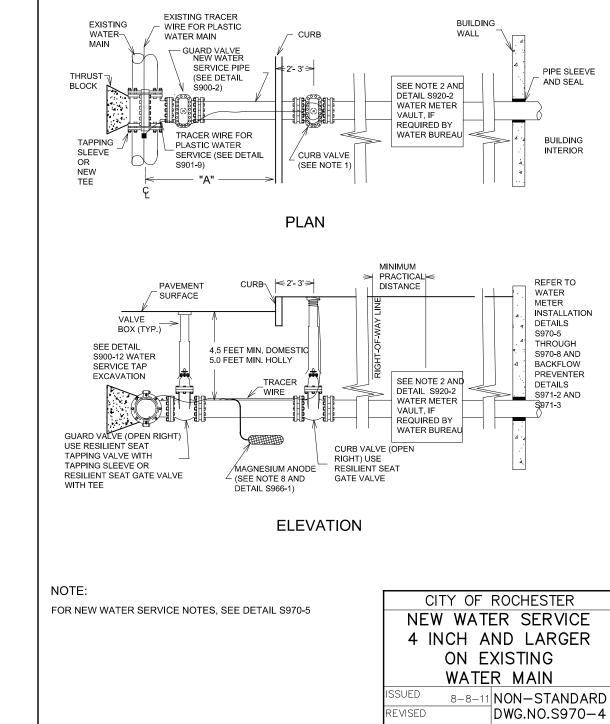

CITY OF ROCHESTER DETAIL

LLS

LHS = VERTICAL HIGH SIDE LENGTH LLS = VERTICAL LOW SIDE LENGTH

HORIZONTAL BEND

← 18' → ← 18' →

RESTRAIN ALL JOINTS THAT ARE

WATER

REDUCERS

S900-9 AND

SIZE DIFFERENCE

L-LHS-LLS DIMENSIONS

USING APPROVED MECHANICAL

WITHIN 18 FEET MINIMUM OF VALVE

VALVE

NOTES: REDUCER

CONCRETE THRUST BLOCK IS TO BE USED IN ADDITION

. ALL POLYETHYLENE WRAPPED DUCTILE IRON HOLLY

4. ASSUMPTION: SP SOILS, 5 FEET COVER, AND TYPE 4

MECHANICAL RESTRAINT DEVICES, SEE DETAILS

MAIN PIPE AND FITTING JOINTS WITHIN

MAIN PIPE LARGER THAN 12 INCHES AND FOR

HAVING MORE THAN ONE PIPE

MUST BE RESTRAINED

\* L = HORIZONTAL LENGTH



PLASTIC WATER SERVICE TRACER WIRE INSTALLATION

MINIMUM DIMENSIONS (IN FFET)

1.0 | 2.5 | 3.0 | 5.0 | 2.0 | 2.5 | 2.5 | 2.0

1.0 | 2.7 | 1.0 | 2.0 | 1.0 | 2.0 | 3.0 | 1.5

1.5 | 2.7 | 4.5 | 5.0 | 2.0 | 3.5 | 3.5 | 3.0

1.0 | 3.0 | 2.5 | 5.0 | 2.0 | 2.5 | 3.0 | 2.0

1.5 | 3.0 | 4.5 | 6.5 | 2.5 | 4.0 | 3.5 | 3.5

2.0 | 3.0 | 8.5 | 8.0 | 2.5 | 4.0 | 4.0 | 3.5

(2)#6 REBARS ──

MINIMUM VOLUME A B C D E F G H

0.45 CY | 1.0 | 2.5 | 1.0 | 2.0 | 1.0 | 1.0 | 2.5 |

2.20 CY

3.35 CY

6.15 CY

8.70 CY

UNDISTURBED


— CLASS K CONCRETE THRUST BLOCK

UPPER VERTICAL BEND

- CLASS K CONCRETE

LOWER VERTICAL BEND

45^

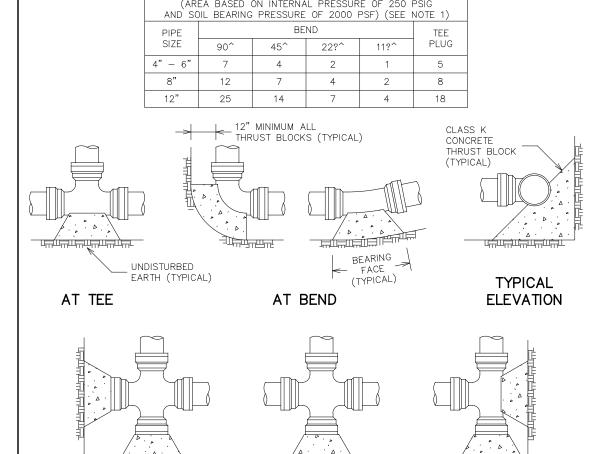

. SPECIAL DESIGN IS REQUIRED FOR FITTINGS ON HOLLY WATER MAIN PIPE LARGER THAN 12 INCHES.

. THRUST BLOCK IS TO BE INSTALLED AT ALL BENDS, TEES, AND TAPPING SLEEVE AND VALVE CONNECTIONS. 4. FACTORY CAST OFFSETS ARE TO BE TREATED AS (2) 45 DEGREE BENDS.

HORIZONTAL THRUST BLOCK HOLLY SYSTEM JED 6-1-09 NON-STANDAR DWG.NO.S900-

SPECIAL DESIGN IS REQUIRED FOR FITTINGS ON HOLLY WATER MAIN PIPE LARGER THAN 12 INCHES. . MECHANICAL RESTRAINT IS REQUIRED IN ADDITION TO THRUST BLOCK, SEE DETAIL S900-8.


VERTICAL THRUST BLOCK HOLLY SYSTEM SSUED 6-1-09 NON-STANDAR DWG.NO.S900-

CITY OF ROCHESTER

<--- D --->

VERTICAL THRUST BLOCK HOLLY SYSTEM

C505 CITY OF ROCHESTER DETAIL

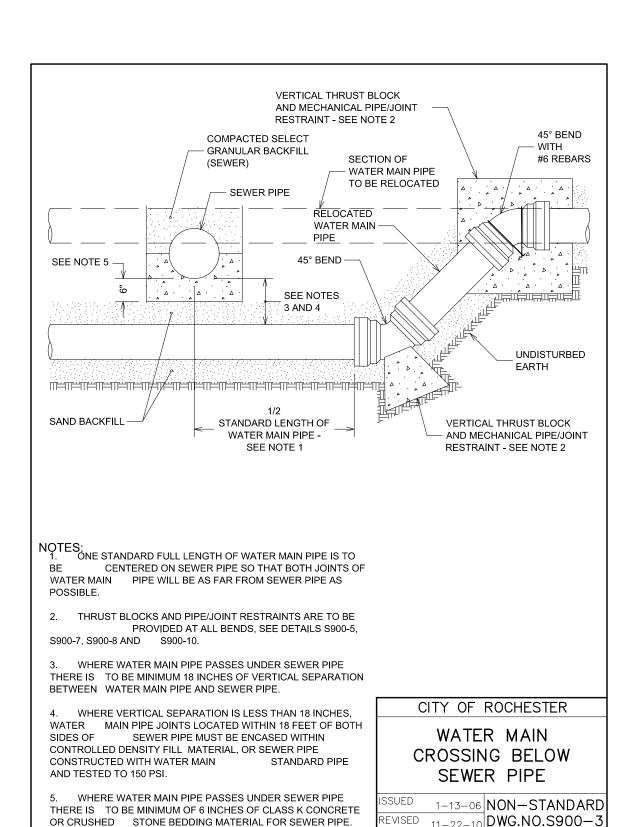




CITY OF ROCHESTER DETAIL

OR CRUSHED STONE BEDDING MATERIAL FOR SEWER PIPE.


CITY OF ROCHESTER DETAIL



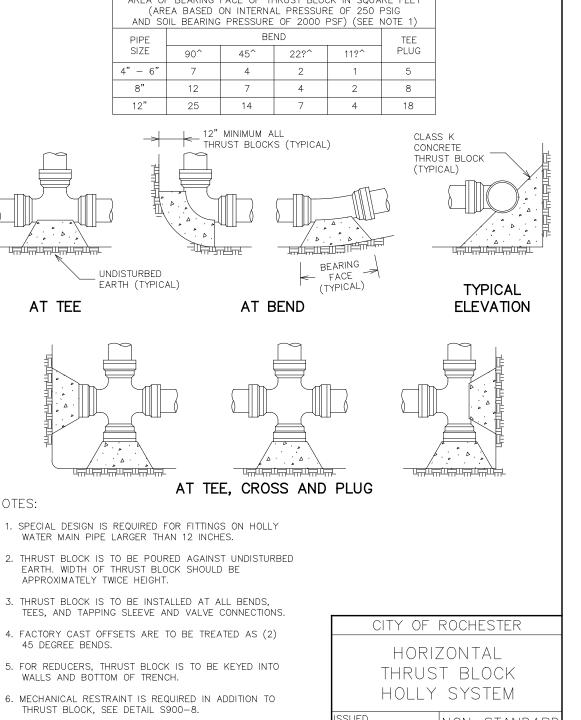

HORIZONTAL THRUST BLOCK HOLLY SYSTEM



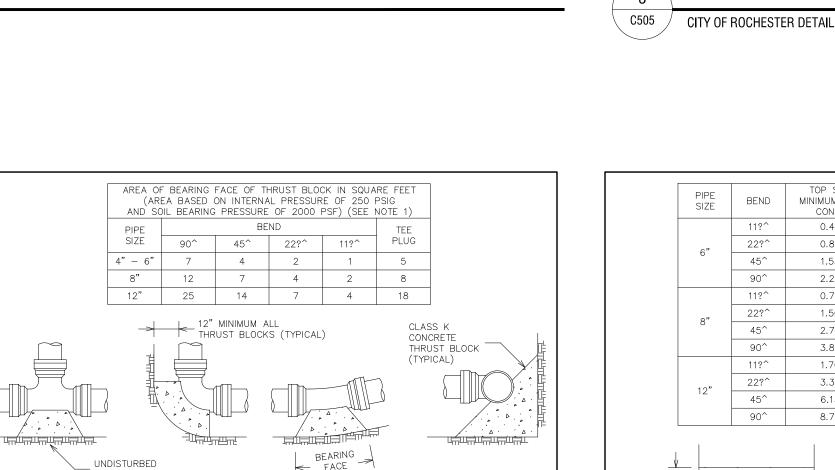

7. WOOD BLOCKING IS NOT PERMITTED.

C505

BUFFALO | ROCHESTER www.cjsarchitects.com

ARCHITECTS

300 State Street, Suite 201 Rochester, NY 14614 585-454-6110

labellapc.com




JOB NO.	1709
SCALE	N.T.S.
ISSUE DATE	5/08/2020
DRAWN BY	LMB
CHECKED BY	RJS

AS PRESENTED SHOULD BE BASED ON

THE ENTIRE SET OF DOCUMENTS.

DRAWING TITLE

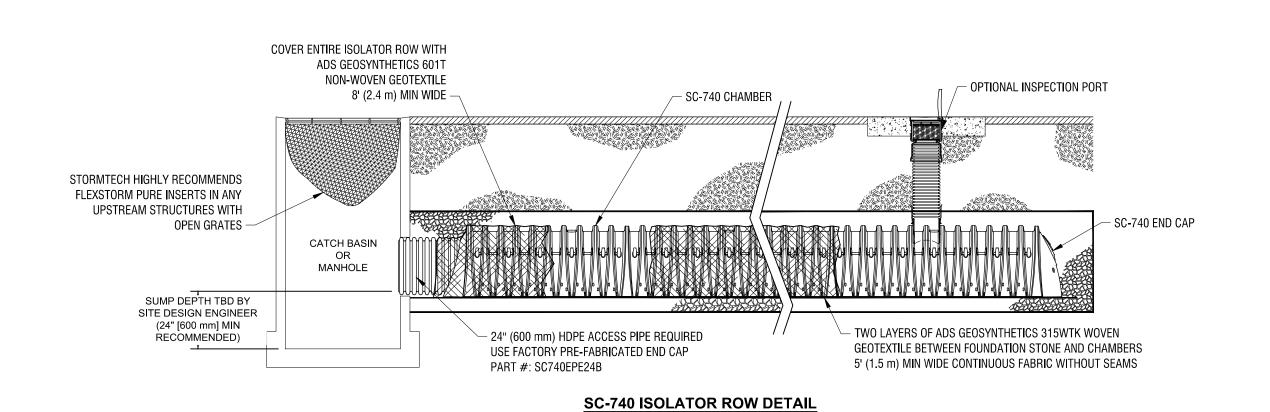

## STUBS, MATCH CROWNS TO CROWN OF MANIFOLD -30" ADS N-12 TOP MANIFOLD, INV 9" ABOVE CHAMBER BASE -PLACE MINIMUM 12.5' OF ADS GEOSYNTHETICS 315WTK WOVEN GEOTEXTILE OVER BEDDING STONE AND UNDERNEATH CHAMBER FEET FOR SCOUR PROTECTION AT ALL CHAMBER INLET ROWS -PROPOSED STRUCTURE W/ELEVATED BYPASS MANIFOLD (DESIGN BY ENGINEER / PROVIDED BY OTHERS) -

SC-740 PLAN VIEW

#### **INSPECTION & MAINTENANCE**

STEP 1) INSPECT ISOLATOR ROW FOR SEDIMENT A. INSPECTION PORTS (IF PRESENT)

- A.1. REMOVE/OPEN LID ON NYLOPLAST INLINE DRAIN
- A.2. REMOVE AND CLEAN FLEXSTORM FILTER IF INSTALLED
  A.3. USING A FLASHLIGHT AND STADIA ROD, MEASURE DEPTH OF SEDIMENT AND RECORD ON MAINTENANCE LOG A.4. LOWER A CAMERA INTO ISOLATOR ROW FOR VISUAL INSPECTION OF SEDIMENT LEVELS (OPTIONAL)
- A.5. IF SEDIMENT IS AT, OR ABOVE, 3" (80 mm) PROCEED TO STEP 2. IF NOT, PROCEED TO STEP 3. B. ALL ISOLATOR ROWS
- B.1. REMOVE COVER FROM STRUCTURE AT UPSTREAM END OF ISOLATOR ROW
   B.2. USING A FLASHLIGHT, INSPECT DOWN THE ISOLATOR ROW THROUGH OUTLET PIPE^Ji) MIRRORS ON POLES OR CAMERAS MAY BE USED TO AVOID A CONFINED SPACE ENTRY^Jii) FOLLOW OSHA REGULATIONS FOR CONFINED
- SPACE ENTRY IF ENTERING MANHOLE B.3. IF SEDIMENT IS AT, OR ABOVE, 3" (80 mm) PROCEED TO STEP 2. IF NOT, PROCEED TO STEP 3.
- STEP 2) CLEAN OUT ISOLATOR ROW USING THE JETVAC PROCESS A. A FIXED CULVERT CLEANING NOZZLE WITH REAR FACING SPREAD OF 45" (1.1 m) OR MORE IS PREFERRED . APPLY MULTIPLE PASSES OF JETVAC UNTIL BACKFLUSH WATER IS CLEAN C. VACUUM STRUCTURE SUMP AS REQUIRED
- STEP 3) REPLACE ALL COVERS, GRATES, FILTERS, AND LIDS; RECORD OBSERVATIONS AND ACTIONS.
- STEP 4) INSPECT AND CLEAN BASINS AND MANHOLES UPSTREAM OF THE STORMTECH SYSTEM.

- 1. INSPECT EVERY 6 MONTHS DURING THE FIRST YEAR OF OPERATION. ADJUST THE INSPECTION INTERVAL BASED ON PREVIOUS
- OBSERVATIONS OF SEDIMENT ACCUMULATION AND HIGH WATER ELEVATIONS.^J 2. CONDUCT JETTING AND VACTORING ANNUALLY OR WHEN INSPECTION SHOWS THAT MAINTENANCE IS NECESSARY.

#### CONCRETE SLAB 12" (300 mm) NYLOPLAST INLINE 8" (200 mm) MIN THICKNESS DRAIN BODY W/SOLID HINGED COVER OR GRATE FLEXSTORM CATCH IT PART# 2712AG06N PART# 6212NYFX SOLID COVER: 1299CGC WITH USE OF OPEN GRATE — GRATE: 1299CGS 6" (150 mm) INSERTA TEE - 6" (150 mm) ADS N-12 PART#06N12ST74IP HDPE PIPE INSERTA TEE TO BE CENTERED ON CORRUGATION CREST -SC-740 CHAMBER

CONCRETE COLLAR -

PAVEMENT :

- 18" (450 mm) MIN WIDTH

CONCRETE COLLAR NOT REQUIRED FOR


UNPAVED APPLICATIONS

#### SC-740 6" INSPECTION PORT DETAIL

## **ACCEPTABLE FILL MATERIALS: STORMTECH SC-740 CHAMBER SYSTEMS**

	MATERIAL LOCATION	DESCRIPTION	AASHTO MATERIAL CLASSIFICATIONS	COMPACTION / DENSITY REQUIREMENT
	FINAL FILL: FILL MATERIAL FOR LAYER 'D' STARTS FROM THE TOP OF THE 'C' LAYER TO THE BOTTOM OF FLEXIBLE PAVEMENT OR UNPAVED FINISHED GRADE ABOVE. NOTE THAT PAVEMENT SUBBASE MAY BE PART OF THE 'D' LAYER	ANY SOIL/ROCK MATERIALS, NATIVE SOILS, OR PER ENGINEER'S PLANS. CHECK PLANS FOR PAVEMENT SUBGRADE REQUIREMENTS.	N/A	PREPARE PER SITE DESIGN ENGINEER'S PLANS. PAVED INSTALLATIONS MAY HAVE STRINGENT MATERIAL AND PREPARATION REQUIREMENTS.
С	INITIAL FILL: FILL MATERIAL FOR LAYER 'C' STARTS FROM THE TOP OF THE EMBEDMENT STONE ('B' LAYER) TO 18" (450 mm) ABOVE THE TOP OF THE CHAMBER, NOTE THAT PAVEMENT SUBBASE MAY BE A PART OF THE 'C' LAYER.	GRANULAR WELL-GRADED SOIL/AGGREGATE MIXTURES, <35% FINES OR PROCESSED AGGREGATE.  MOST PAVEMENT SUBBASE MATERIALS CAN BE USED IN LIEU OF THIS LAYER.	OR	BEGIN COMPACTIONS AFTER 12" (300 mm) OF MATERIAL OVER THE CHAMBERS IS REACHED. COMPACT ADDITIONAL LAYERS IN 6" (150 mm) MAX LIFTS TO A MIN. 95% PROCTOR DENSITY FOR WELL GRADED MATERIAL AND 95% RELATIVE DENSITY FOR PROCESSED AGGREGATE MATERIALS. ROLLER GROSS BEHICLE WEIGHT NOT TO EXCEED 12,000 lbs (53 kN). DYNAMIC FORCE NOT TO EXCEED 20,000 lbs (89 kN).
l	EMBEDMENT STONE: FILL SURROUNDING THE CHAMBERS FROM THE FOUNDATION STONE ('A' LAYER) TO THE 'C' LAYER ABOVE.	CLEAN, CRUSHED, ANGULAR STONE, NOMINAL SIZE DISTRIBUTION BETWEEN 3/4-2 INCH (20-50 mm)	AASHTO M43 <sup>1</sup> 3, 357, 4, 467, 5, 56, 57	NO COMPACTION REQUIRED.
1	FOUNDATION STONE: FILL BELOW CHAMBERS FROM THE SUBGRADE UP TO THE FOOT (BOTTOM) OF THE CHAMBER.	CLEAN, CRUSHED, ANGULAR STONE, NOMINAL SIZE DISTRIBUTION BETWEEN 3/4-2 INCH (20-50 mm)	AASHTO M43 <sup>1</sup> 3, 357, 4, 467, 5, 56, 57	PLATE COMPACT OR ROLL TO ACHIEVE A FLAT SURFACE. <sup>23</sup>


- 1. THE LISTED AASHTO DESIGNATIONS ARE FOR GRADATIONS ONLY. THE STONE MUST ALSO BE CLEAN, CRUSHED, ANGULAR. FOR EXAMPLE, A SPECIFICATION FOR #4 STONE WOULD STATE: "CLEAN, CRUSHED, ANGULAR. FOR EXAMPLE, A SPECIFICATION FOR #4 STONE WOULD STATE: "CLEAN, CRUSHED, ANGULAR. FOR EXAMPLE, A SPECIFICATION FOR #4 STONE WOULD STATE: "CLEAN, CRUSHED, ANGULAR. FOR EXAMPLE, A SPECIFICATION FOR #4 STONE WOULD STATE: "CLEAN, CRUSHED, ANGULAR. FOR EXAMPLE, A SPECIFICATION FOR #4 STONE WOULD STATE: "CLEAN, CRUSHED, ANGULAR. FOR EXAMPLE, A SPECIFICATION FOR #4 STONE WOULD STATE: "CLEAN, CRUSHED, ANGULAR. FOR EXAMPLE, A SPECIFICATION FOR #4 STONE WOULD STATE: "CLEAN, CRUSHED, ANGULAR. FOR EXAMPLE, A SPECIFICATION FOR #4 STONE WOULD STATE: "CLEAN, CRUSHED, ANGULAR. FOR EXAMPLE, A SPECIFICATION FOR #4 STONE WOULD STATE: "CLEAN, CRUSHED, ANGULAR. FOR EXAMPLE, A SPECIFICATION FOR #4 STONE WOULD STATE: "CLEAN, CRUSHED, ANGULAR. FOR EXAMPLE, A SPECIFICATION FOR #4 STONE WOULD STATE: "CLEAN, CRUSHED, ANGULAR. FOR EXAMPLE, A SPECIFICATION FOR #4 STONE WOULD STATE: "CLEAN, CRUSHED, ANGULAR. FOR EXAMPLE, A SPECIFICATION FOR #4 STONE WOULD STATE: "CLEAN, CRUSHED, ANGULAR. FOR EXAMPLE, A SPECIFICATION FOR #4 STONE WOULD STATE: "CLEAN, CRUSHED, ANGULAR. FOR EXAMPLE, A SPECIFICATION FOR #4 STONE WOULD STATE: "CLEAN, CRUSHED, ANGULAR. FOR EXAMPLE, A SPECIFICATION FOR #4 STONE WOULD STATE: "CLEAN, CRUSHED, ANGULAR FOR EXAMPLE, A
- 2. STORMTECH COMPACTION REQUIREMENTS ARE MET FOR 'A' LOCATION MATERIALS WHEN PLACED AND COMPACTED IN 6" (150 mm) (MAX) LIFTS USING TWO FULL COVERAGES WITH A VIBRATORY COMPACTOR. 3. WHERE INFILTRATION SURFACES MAY BE COMPROMISED BY COMPACTION, FOR STANDARD DESIGN LOAD CONDITIONS, A FLAT SURFACE MAY BE ACHIEVED BY RAKING OR DRAGGING WITHOUT COMPACTION EQUIPMENT. FOR SPECIAL LOAD DESIGNS, CONTACT STORMTECH FOR COMPACTION REQUIREMENTS.

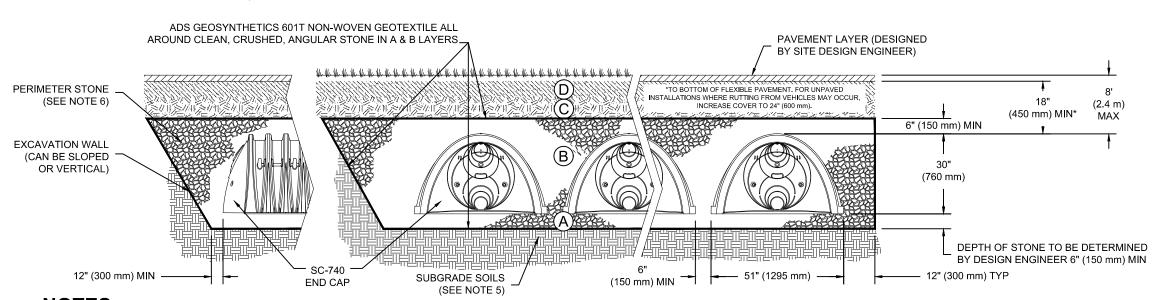

## NOTES:

- 1. SC-740 CHAMBERS SHALL CONFORM TO THE REQUIREMENTS OF ASTM F2418 "STANDARD SPECIFICATION FOR POLYPROPYLENE (PP) CORRUGATED WALL STORMWATER COLLECTION CHAMBERS", OR ASTM F2922 "STANDARD SPECIFICATION FOR POLYETHYLENE (PE) CORRUGATED WALL STORMWATER COLLECTION CHAMBERS". AJ
- 2. SC-740 CHAMBERS SHALL BE DESIGNED IN ACCORDANCE WITH ASTM F2787 "STANDARD PRACTICE FOR STRUCTURAL DESIGN OF THERMOPLASTIC CORRUGATED WALL STORMWATER COLLECTION 3. "ACCEPTABLE FILL MATERIALS" TABLE ABOVE PROVIDES MATERIAL LOCATIONS, DESCRIPTIONS, GRADATIONS, AND COMPACTION REQUIREMENTS FOR FOUNDATION, EMBEDMENT, AND FILL
- MATERIALS.^J
- 4. THE "SITE DESIGN ENGINEER" REFERS TO THE ENGINEER RESPONSIBLE FOR THE DESIGN AND LAYOUT OF THE STORMTECH CHAMBERS FOR THIS PROJECT.^J 5. THE SITE DESIGN ENGINEER IS RESPONSIBLE FOR ASSESSING THE BEARING RESISTANCE (ALLOWABLE BEARING CAPACITY) OF THE SUBGRADE SOILS AND THE DEPTH OF FOUNDATION STONE WITH CONSIDERATION FOR THE RANGE OF EXPECTED SOIL MOISTURE CONDITIONS.^J
- 6. PERIMETER STONE MUST BE EXTENDED HORIZONTALLY TO THE EXCAVATION WALL FOR BOTH VERTICAL AND SLOPED EXCAVATION WALLS.
- 7. ONCE LAYER 'C' IS PLACED, ANY SOIL/MATERIAL CAN BE PLACED IN LAYER 'D' UP TO THE FINISHED GRADE. MOST PAVEMENT SUBBASE SOILS CAN BE USED TO REPLACE THE MATERIAL REQUIREMENTS OF LAYER 'C' OR 'D' AT THE SITE DESIGN ENGINEER'S DISCRETION.

`— 30" ADS N-12 STUB

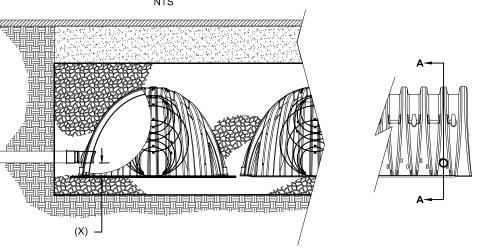

CHAMBER	MAX DIAMETER OF INSERTA TEE	HEIGHT FROM BASE OF CHAMBER (X)
SC-740	10" (250 mm)	4" (100 mm)

INSERTA TEE FITTINGS AVAILABLE FOR SDR 26, SDR 35, SCH 40 IPS GASKETED & SOLVENT WELD, N-12, HP STORM, C-900 OR DUCTILE IRON

SIDE VIEW


6" ADS N-12 DUAL WALL PERFORATED HDPE UNDERDRAIN

(SIZE TBD BY ENGINEER)


#### NOTE: PART NUMBERS WILL VARY BASED ON INLET PIPE MATERIALS. CONTACT STORMTECH FOR MORE INFORMATION.


15" ADS N-12 ECCENTRIC HIGH

SECTION A-A

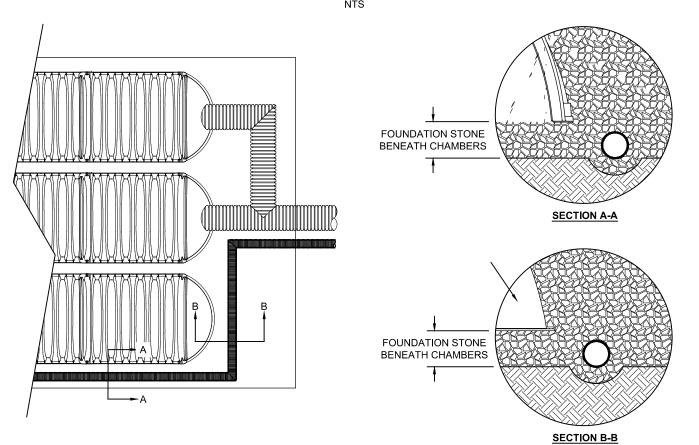

#### SC-740 TECHNICAL SPECIFICATION

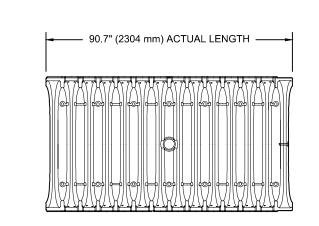

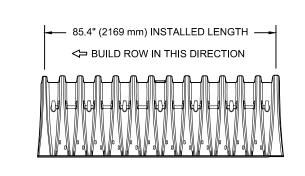

PROPOSED OUTLET CONTROL STRUCTURE

INSPECTION PORT


- ISOLATOR ROW


(DESIGN BY ENGINEER / PROVIDED BY OTHERS) -

24" ADS N-12 BOTTOM CONNECTION,

(7 CFS MAXIMUM OUTLET CAPACITY)

INV 0.1"" ABOVE CHAMBER BASE

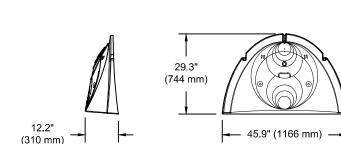

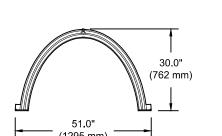

NOMINAL CHAMBER SPECIFICATIONS
SIZE (W X H X INSTALLED LENGTH) CHAMBER STORAGE MINIMUM INSTALLED STORAGE\*

WEIGHT

51.0" X 30.0" X 85.4" (1295 mm X 762 mm X 2169 mm) 45.9 CUBIC FEET (1.30 m<sup>3</sup>) 74.9 CUBIC FEET (2.12 m³) 75.0 lbs. (33.6 kg)

\*ASSUMES 6" (152 mm) STONE ABOVE, BELOW, AND BETWEEN CHAMBERS



DART#	OTUD			
STUBS AT TOP OF END CAP FOR PART NUMBERS ENDING WITH "T"				
STUBS AT BOTTOM OF END CAP FOR PA	ART NUMBERS ENDIN	IG WITH "B		

PART #	STUB	A	В	С	
SC740EPE06T / SC740EPE06TPC	6" (150 mm)	10.9" (277 mm)	18.5" (470 mm)		
SC740EPE06B / SC740EPE06BPC			_	0.5" (13 mm)	
SC740EPE08T /SC740EPE08TPC	8" (200 mm)	12.2" (310 mm)	16.5" (419 mm)	-	
SC740EPE08B / SC740EPE08BPC	7 8 (200 111111)	12.2 (310111111)	_	0.6" (15 mm)	
SC740EPE10T / SC740EPE10TPC	10" (250 mm)	13.4" (340 mm)	14.5" (368 mm)	-	
SC740EPE10B / SC740EPE10BPC	10 (250 11111)	13.4 (340 11111)	_	0.7" (18 mm)	
SC740EPE12T / SC740EPE12TPC	12" (300 mm)	14.7" (373 mm)	12.5" (318 mm)		
SC740EPE12B / SC740EPE12BPC	12 (300 mm)	12 (300 11111)	14.7 (373 11111)	_	1.2" (30 mm)
SC740EPE15T / SC740EPE15TPC	15" (375 mm)	18.4" (467 mm)	9.0" (229 mm)	-	
SC740EPE15B / SC740EPE15BPC		10.4 (407 11111)	_	1.3" (33 mm)	
SC740EPE18T / SC740EPE18TPC	2 18" (450 mm) 19.7" (500 mm) 5.0" (127 mm)	10" (4E0 mm) 1	5.0" (127 mm)		
SC740EPE18B / SC740EPE18BPC	] 10 (450 11111)	19.7 (300 11111)	_	1.6" (41 mm)	
SC740EPE24B*	24" (600 mm)	18.5" (470 mm)	_	0.1" (3 mm)	

ALL STUBS, EXCEPT FOR THE SC740EPE24B ARE PLACED AT BOTTOM OF END CAP SUCH THAT THE OUTSIDE DIAMETER OF THE STUB IS FLUSH WITH THE BOTTOM OF THE END CAP. FOR ADDITIONAL INFORMATION CONTACT STORMTECH AT 1-888-892-2694. MATERIAL SHOULD BE REMOVED FROM BELOW THE N-12 STUB SO THAT THE FITTING SITS LEVEL.

\* FOR THE SC740EPE24B THE 24" (600 mm) STUB LIES BELOW THE BOTTOM OF THE END CAP APPROXIMATELY 1.75" (44 mm). BACKFILL NOTE: ALL DIMENSIONS ARE NOMINAL

SC-740 STORMTECH CHAMBER SYSTEM DETAIL



300 State Street, Suite 201 Rochester, NY 14614 585-454-6110

labellapc.com



**PERMIT SET** 

ADVENTURE PLACE

**KONAR PROPERTIES** 

VIDA - BUILDINGS A AND B

> 2 ADVENTURE PLACE. ROCHESTER, NEW YORK 14607

DESCRIPTION


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ISSUE DATE	5/08/202
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CHECKED BY	RJ

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DRAWING TITLE

CONSTRUCTION **DETAILS** 

C506



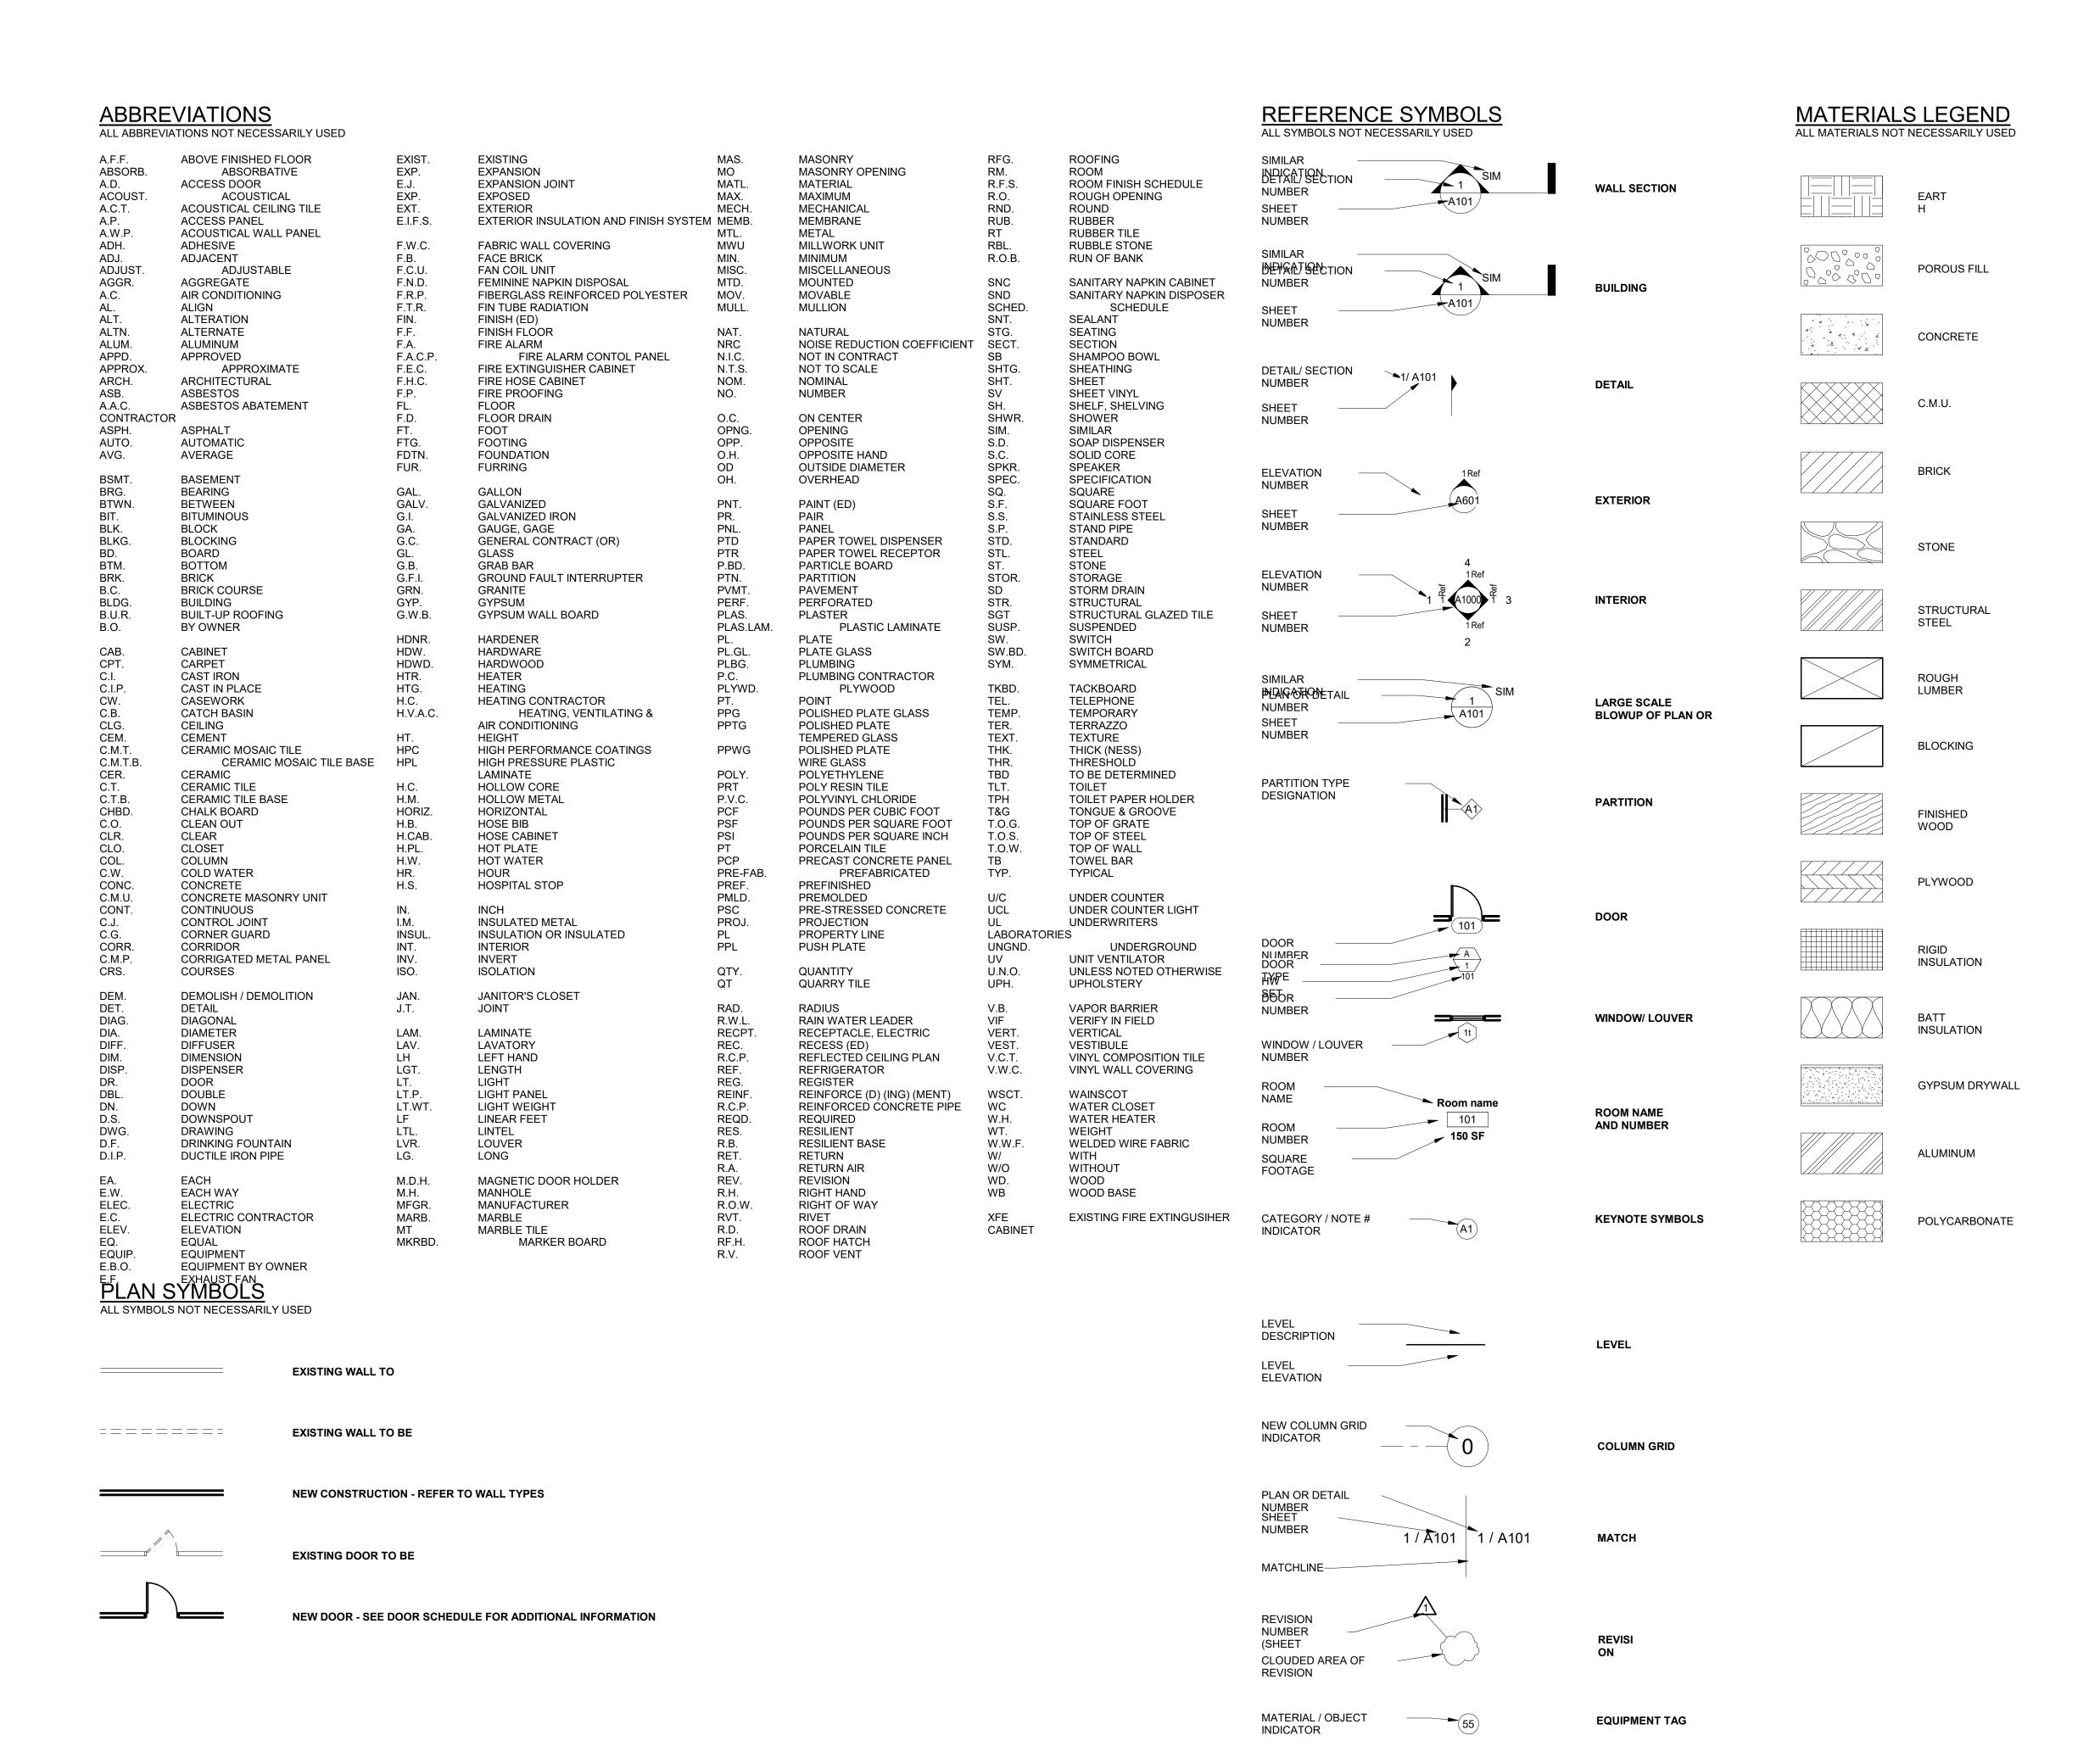










PERMIT SET

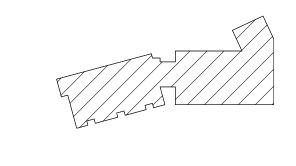

ADVENTURE PLACE N

KONAR PROPERTIES

BUILDING B




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DRAWING TITLE

SYMBOLS, ABBREVIATIONS & GEN. NOTES

A001

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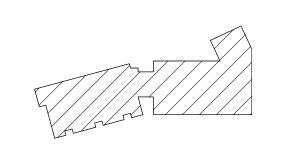


PERMIT SET

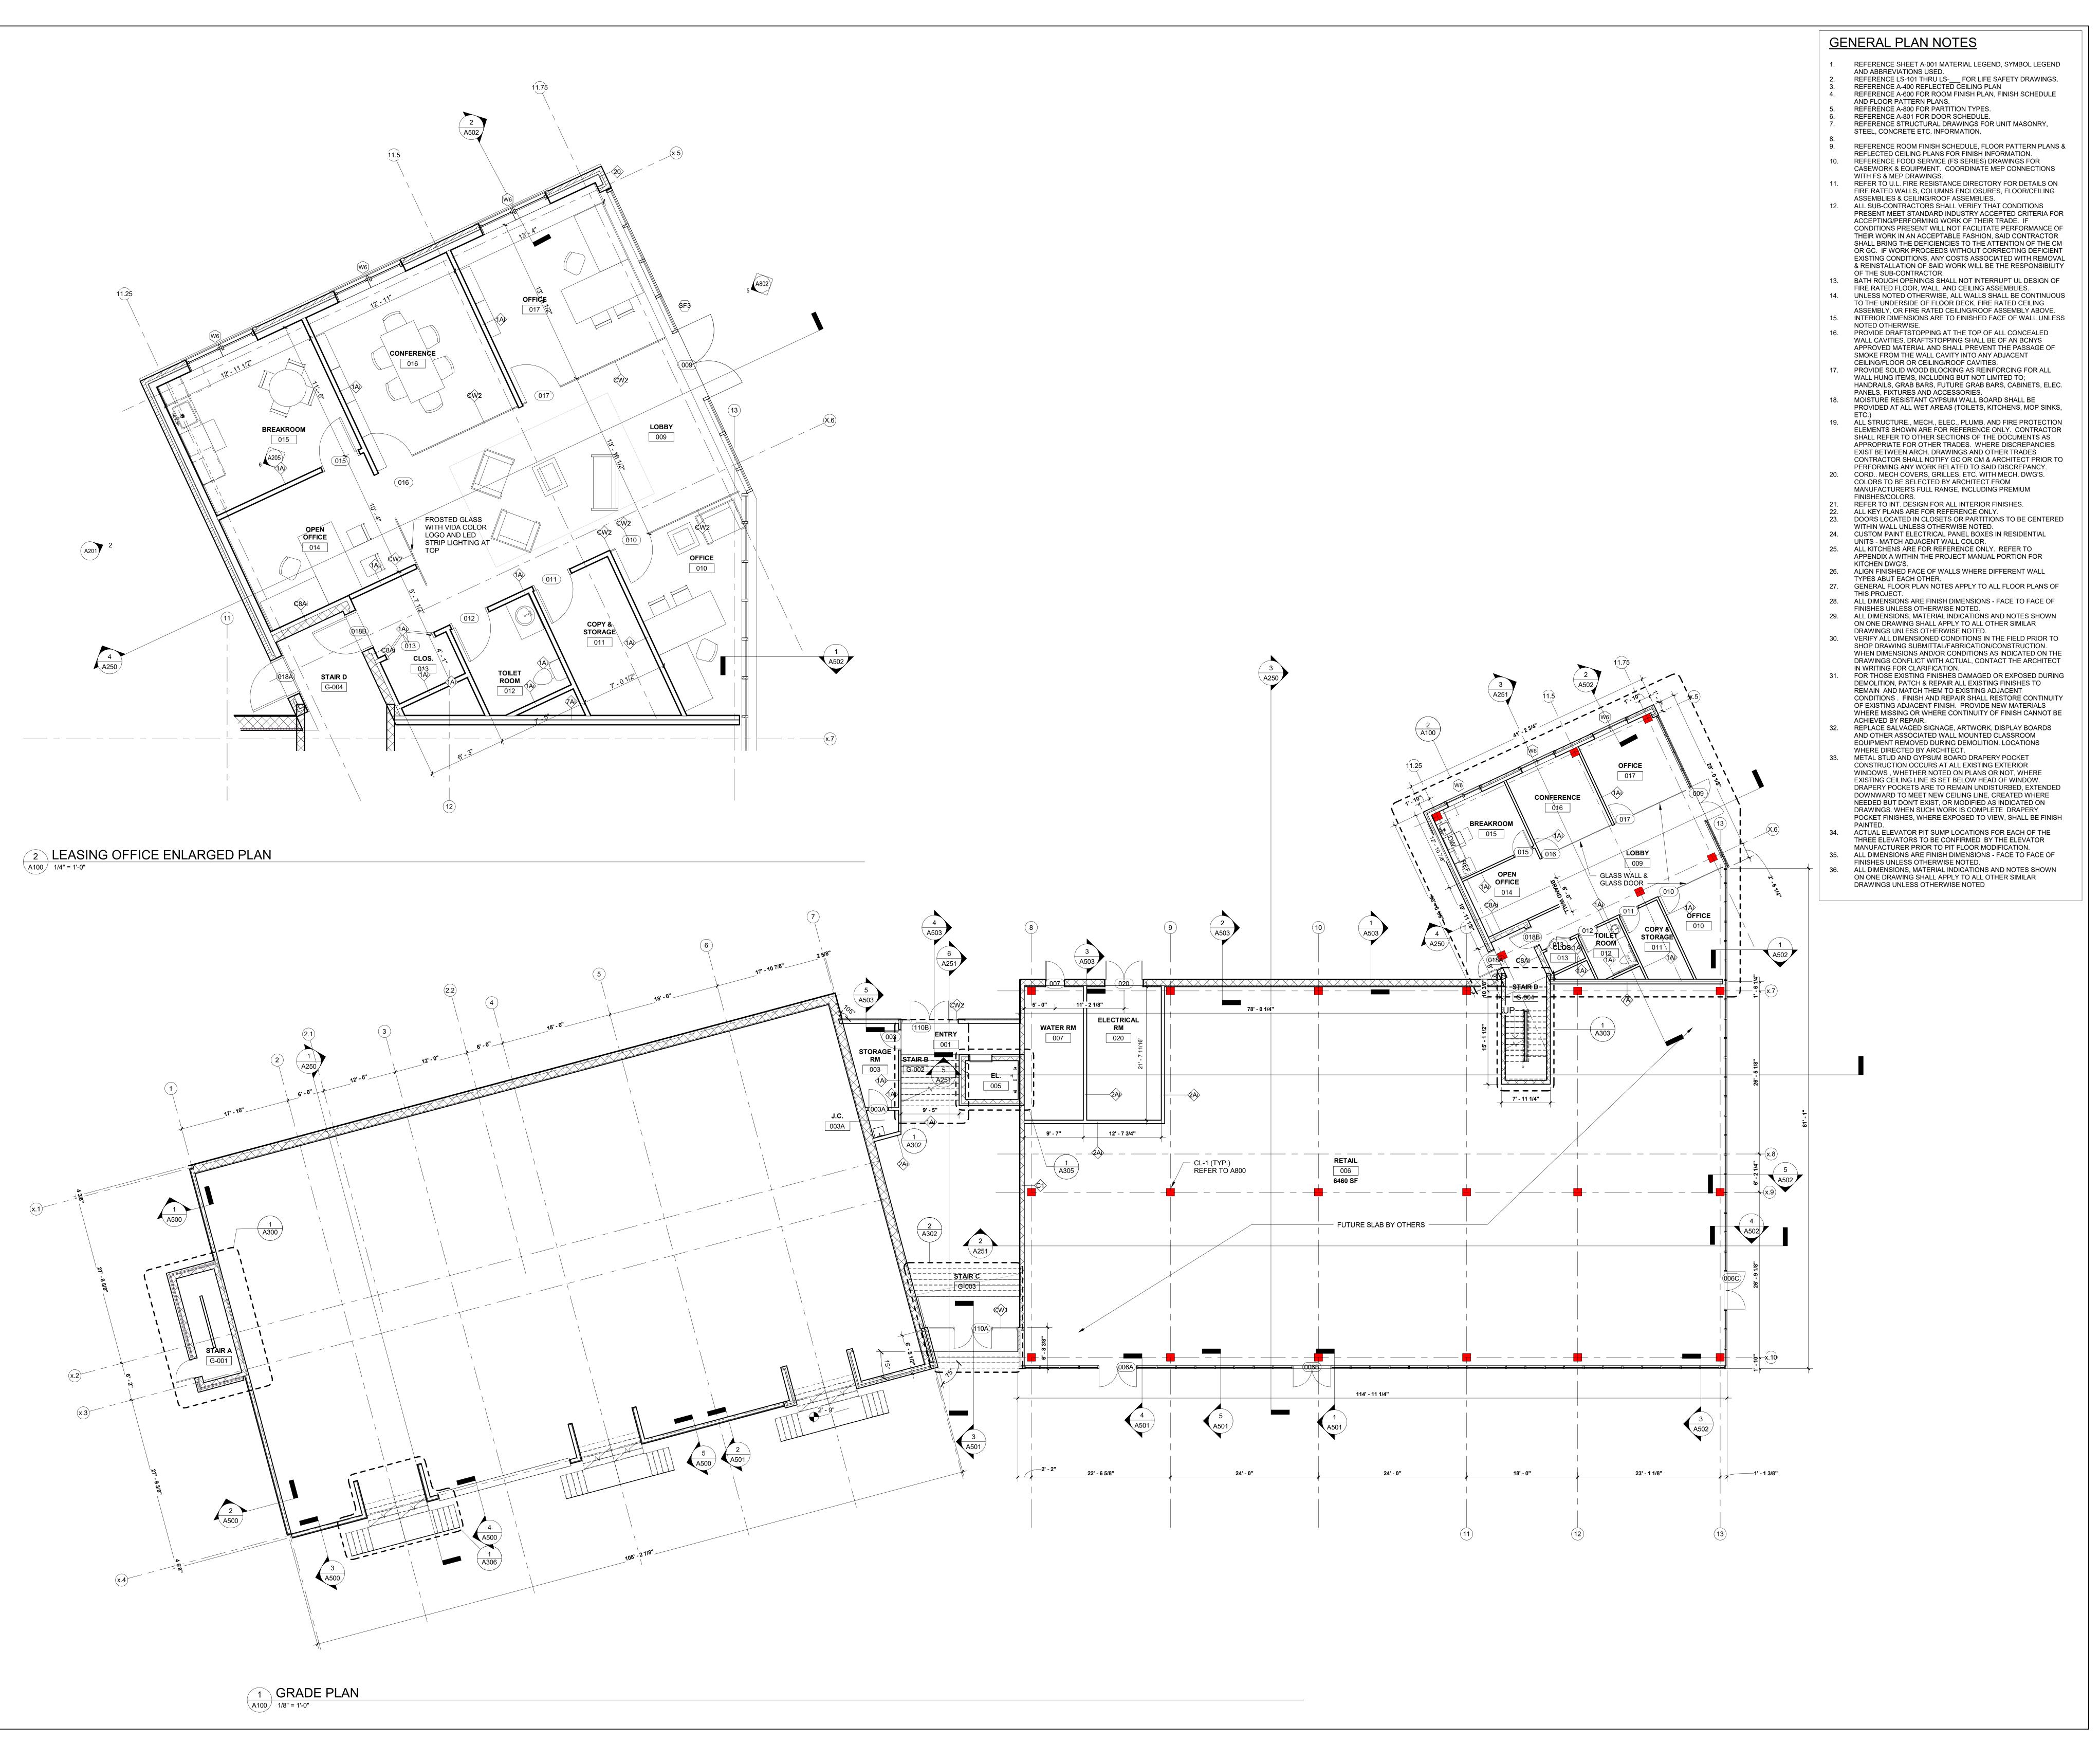



PERMIT SET



ADVENTURE PLACE
KEY PLAN

KONAR PROPERTIES

BUILDING B

30 ADVENTURE PLACE,
ROCHESTER, NEW YORK
14607


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GRADE FLOOR PLAN

DRAWING TITLE

A100



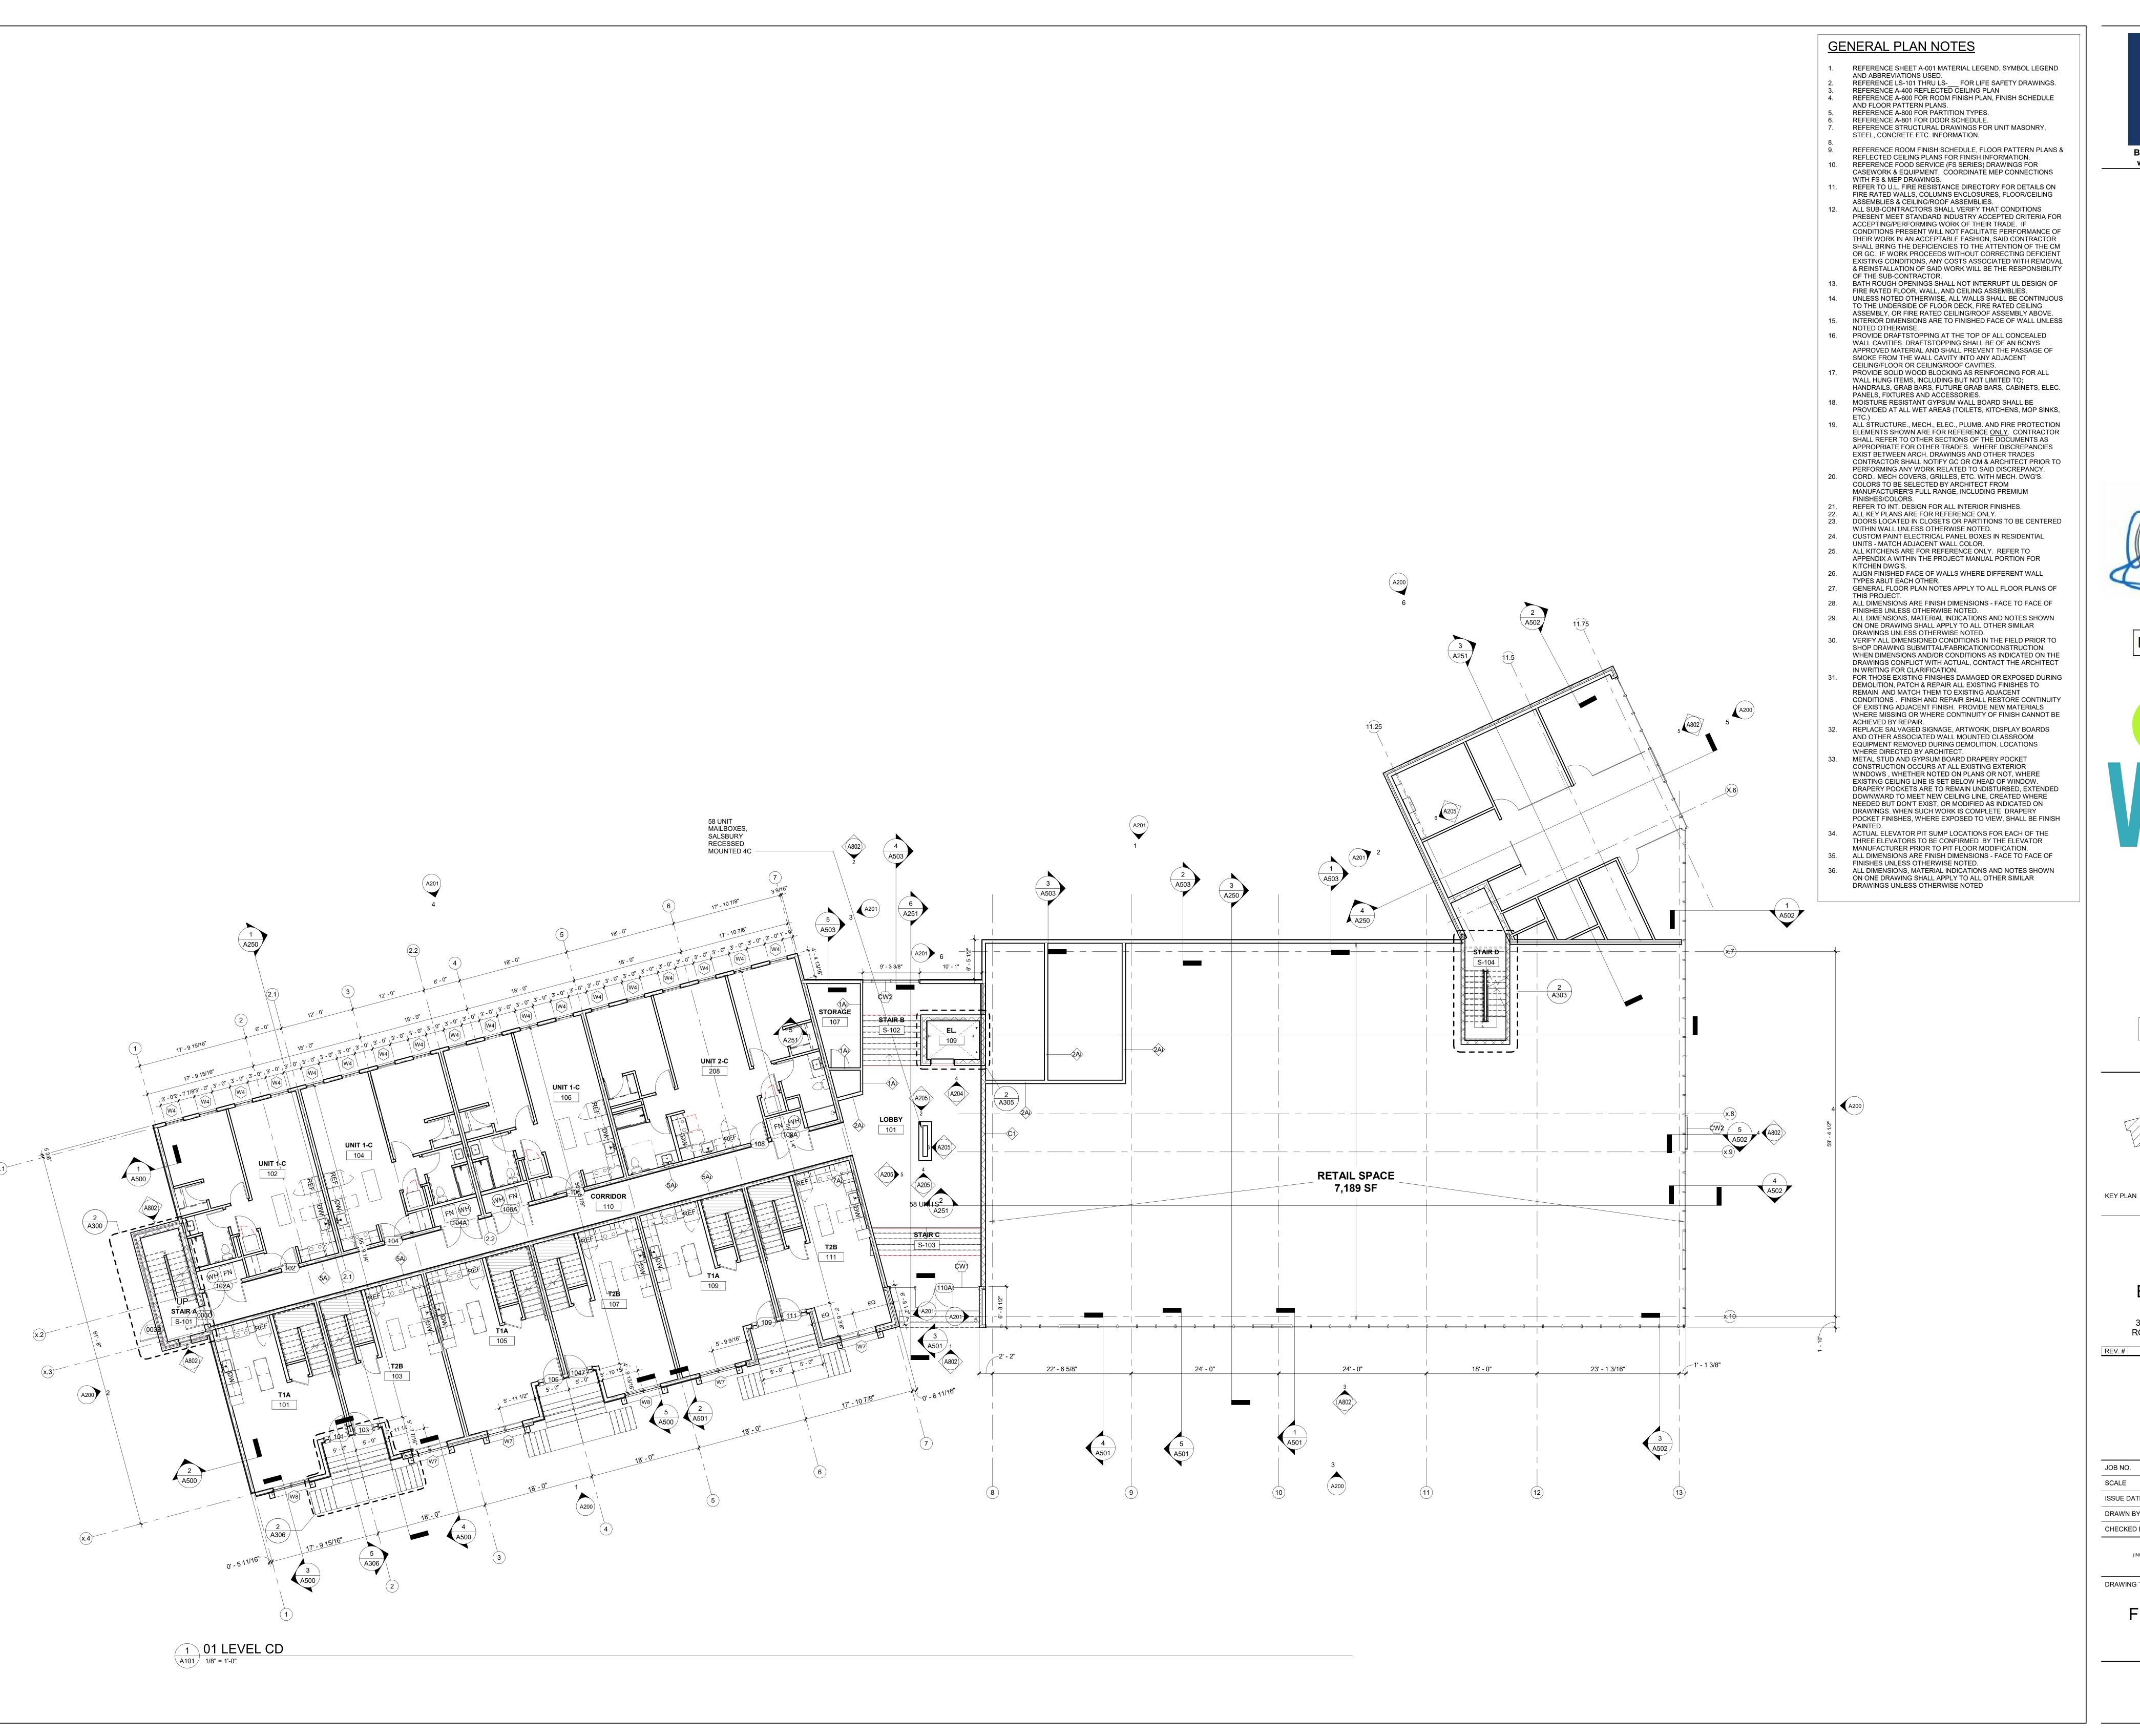


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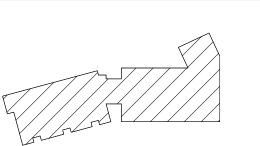


PERMIT SET





PERMIT SET

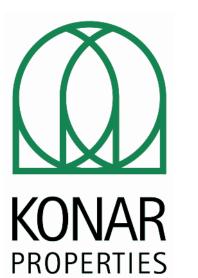

ADVENTURE PLACE

NAR PROPERTIES

**BUILDING B** 

30 ADVENTURE PLACE,
ROCHESTER, NEW YORK
14607
DESCRIPTION DATE

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	ISSUE DATE	05/08/20
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FIRST FLOOR PLAN

A101

DEDMI







ARCHITECTS

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ADVENTURE PLACE
KEY PLAN

KONAR PROPERTIES

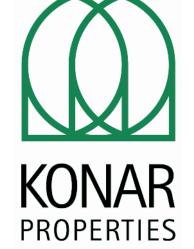BUILDING B

30 ADVENTURE PLACE,
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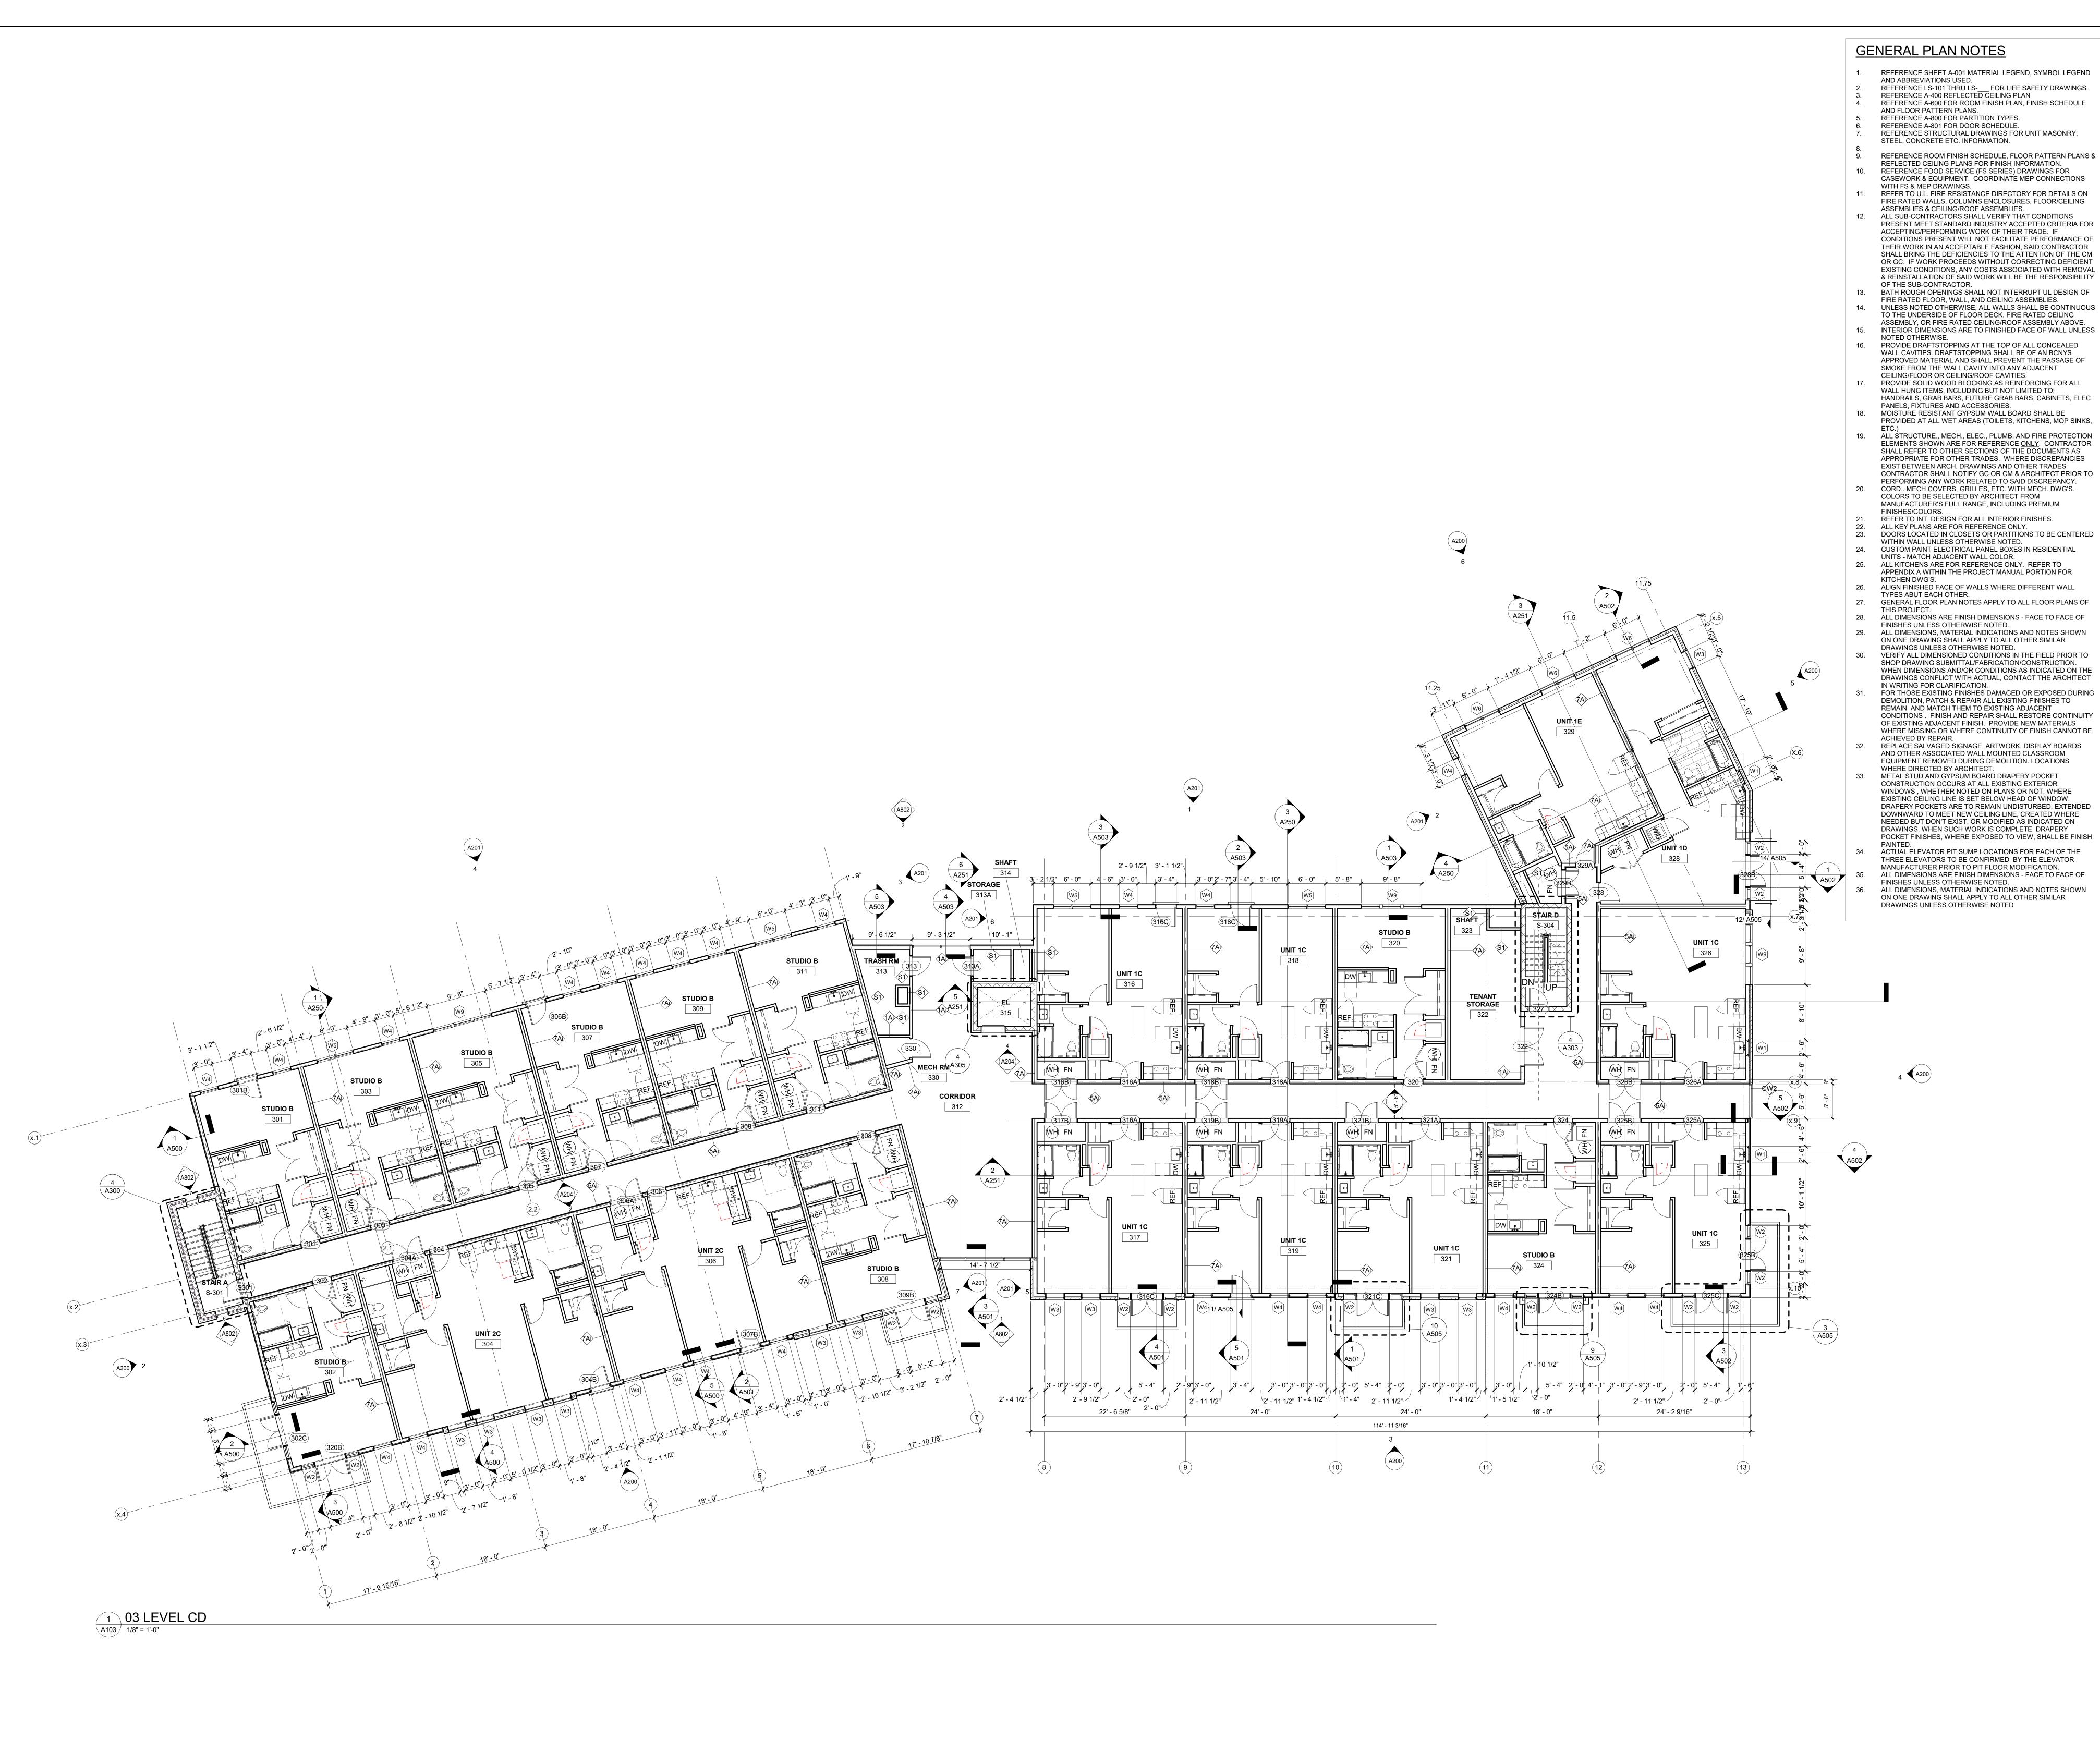
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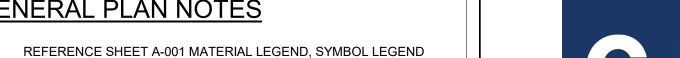
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SECOND FLOOR PLAN

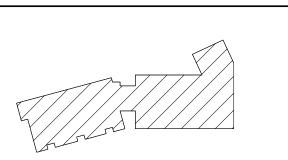DRAWING TITLE

A102











PERMIT SET



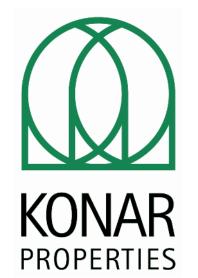

PERMIT SET

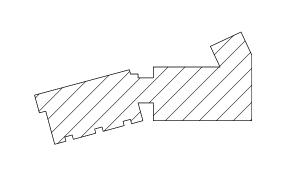

ADVENTURE PLACE KEY PLAN

**KONAR PROPERTIES** 

**BUILDING B** 30 ADVENTURE PLACE, ROCHESTER, NEW YORK


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THIRD FLOOR PLAN

A103






ARCHITECTS
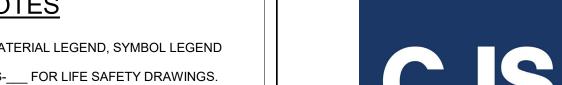
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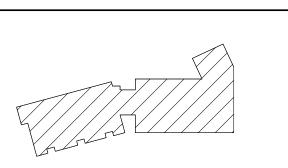


PERMIT SET



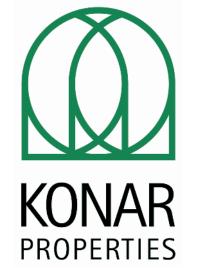

PERMIT SET



ADVENTURE PLACE
KEY PLAN

KONAR PROPERTIES

**BUILDING B** 

30 ADVENTURE PLACE,
ROCHESTER, NEW YORK
14607

# DESCRIPTION DATE

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	ISSUE DATE	05/08/20
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FOURTH FLOOR PLAN

DRAWING TITLE


A104

DEDMIT

## **GENERAL ROOF PLAN NOTES**

- SLOPE ROOF MIN. 1/4" PER FOOT TOWARDS DRAIN & ACROSS ENTIRE ROOF INC. BUILT-UP INSULATION TYP. COORD. WITH STRUCT. FRAMING PLANS.
   MEP ITEMS SHOWN FOR ILLUSTRATIVE PURPOSES ONLY. REFER TO MEP DRAWINGS FOR ALL PENETRATING ITEMS AND ROOFTOP EQUIPMENT.
   ALLOW FOR +/- 400 ROOF PENETRATIONS OF VARIOUS SIZES AND MATERIALS. FLASH ALL PENETRATIONS UTILIZING ROOFING MANUFACTURE'S STANDARD DETAILS AND MATERIALS FOR THE PENETRATE. COORDINATE EXACT COUNT OF PENETRATIONS W/
   MEP DRAWINGS.
- PROVIDE CURBS w/ ALL ASSOCIATED CRICKETING FOR ALL ROOF TOP EQUIPMENT REF.
  MEP DRAWINGS.
  MEP DRAWINGS.
  MEP DRAWINGS.
  REF. PLUMBING DRAWINGS FOR ROOF DRAINS.
  REFER TO WALL SECTIONS FOR PARAPET / CORNICE AND COPING / GRAVEL STOP DETAILS.
  PROVIDE ROOFTOP WALKWAY, REFER TO SPECIFICATIONS FOR MATERIAL &



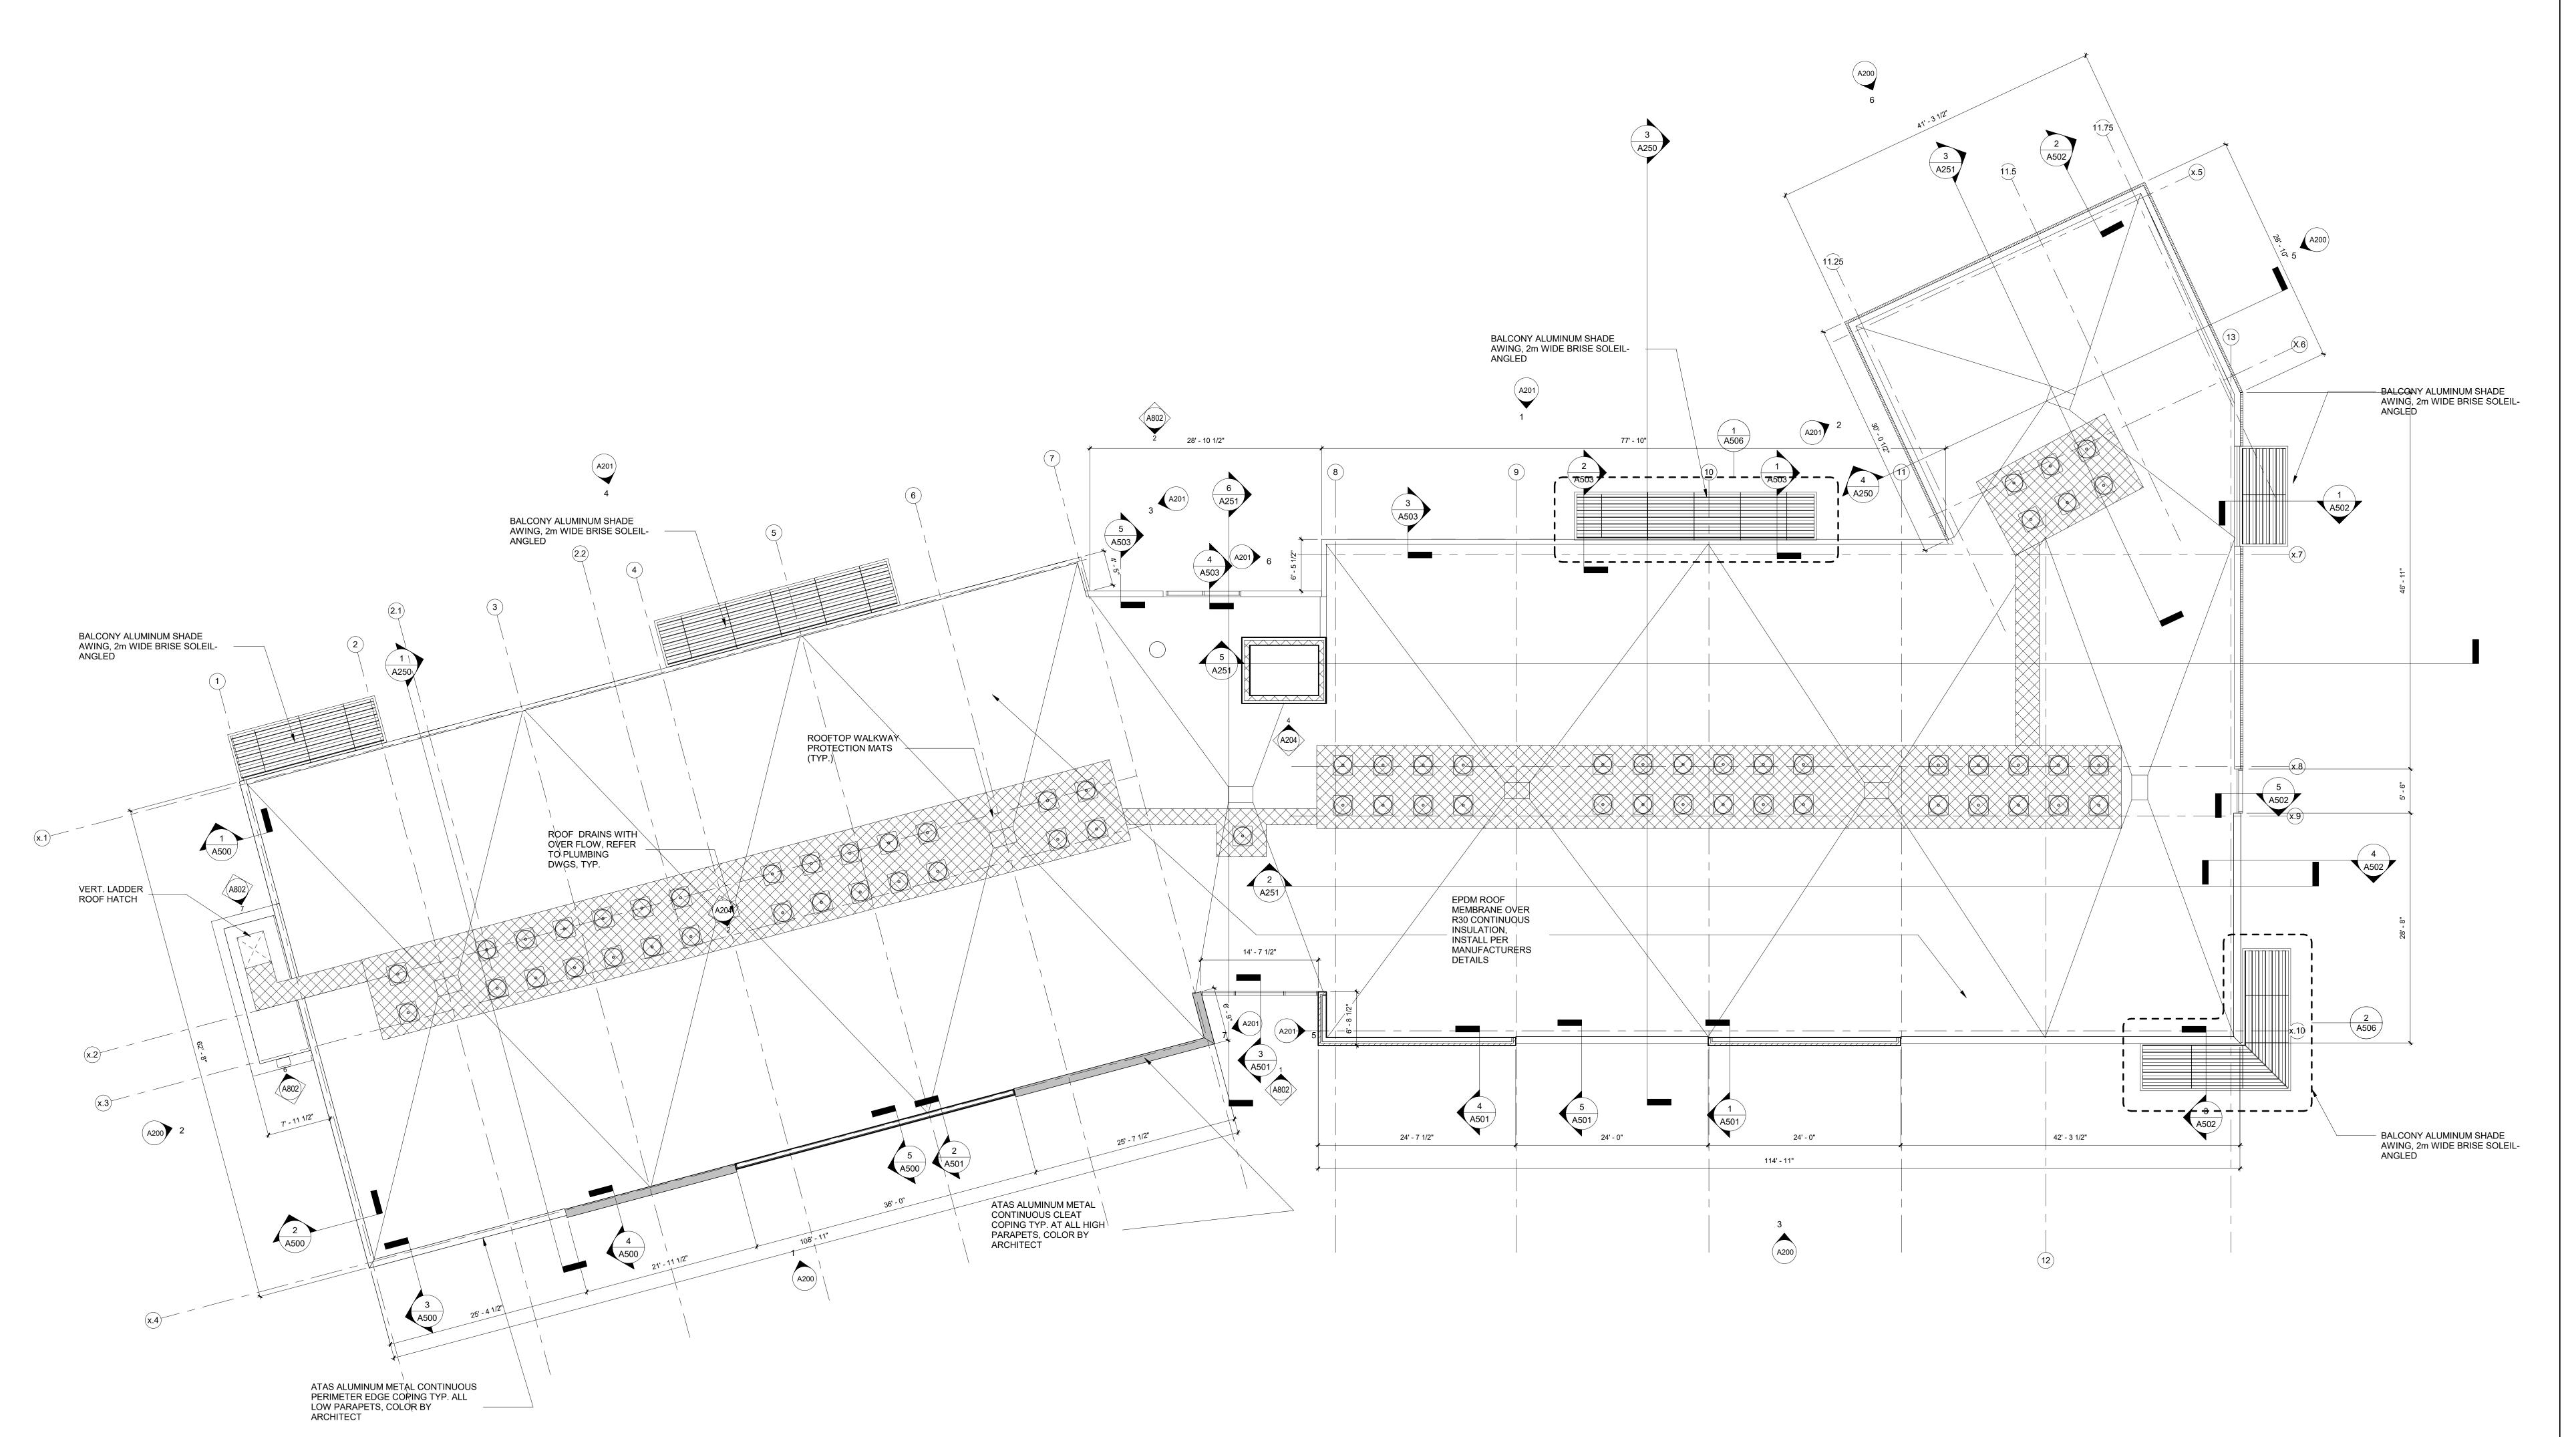


1 05 ROOF CD A105 1/8" = 1'-0"




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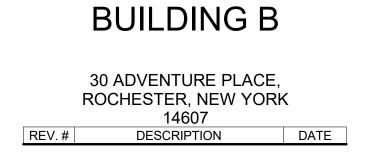


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ADVENTURE PLACE N

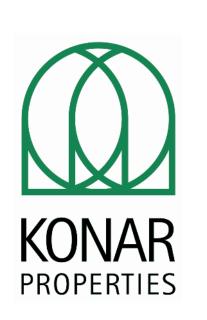
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**ROOF PLAN** 

A105

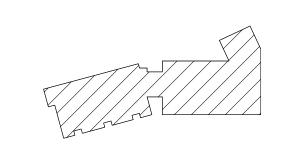



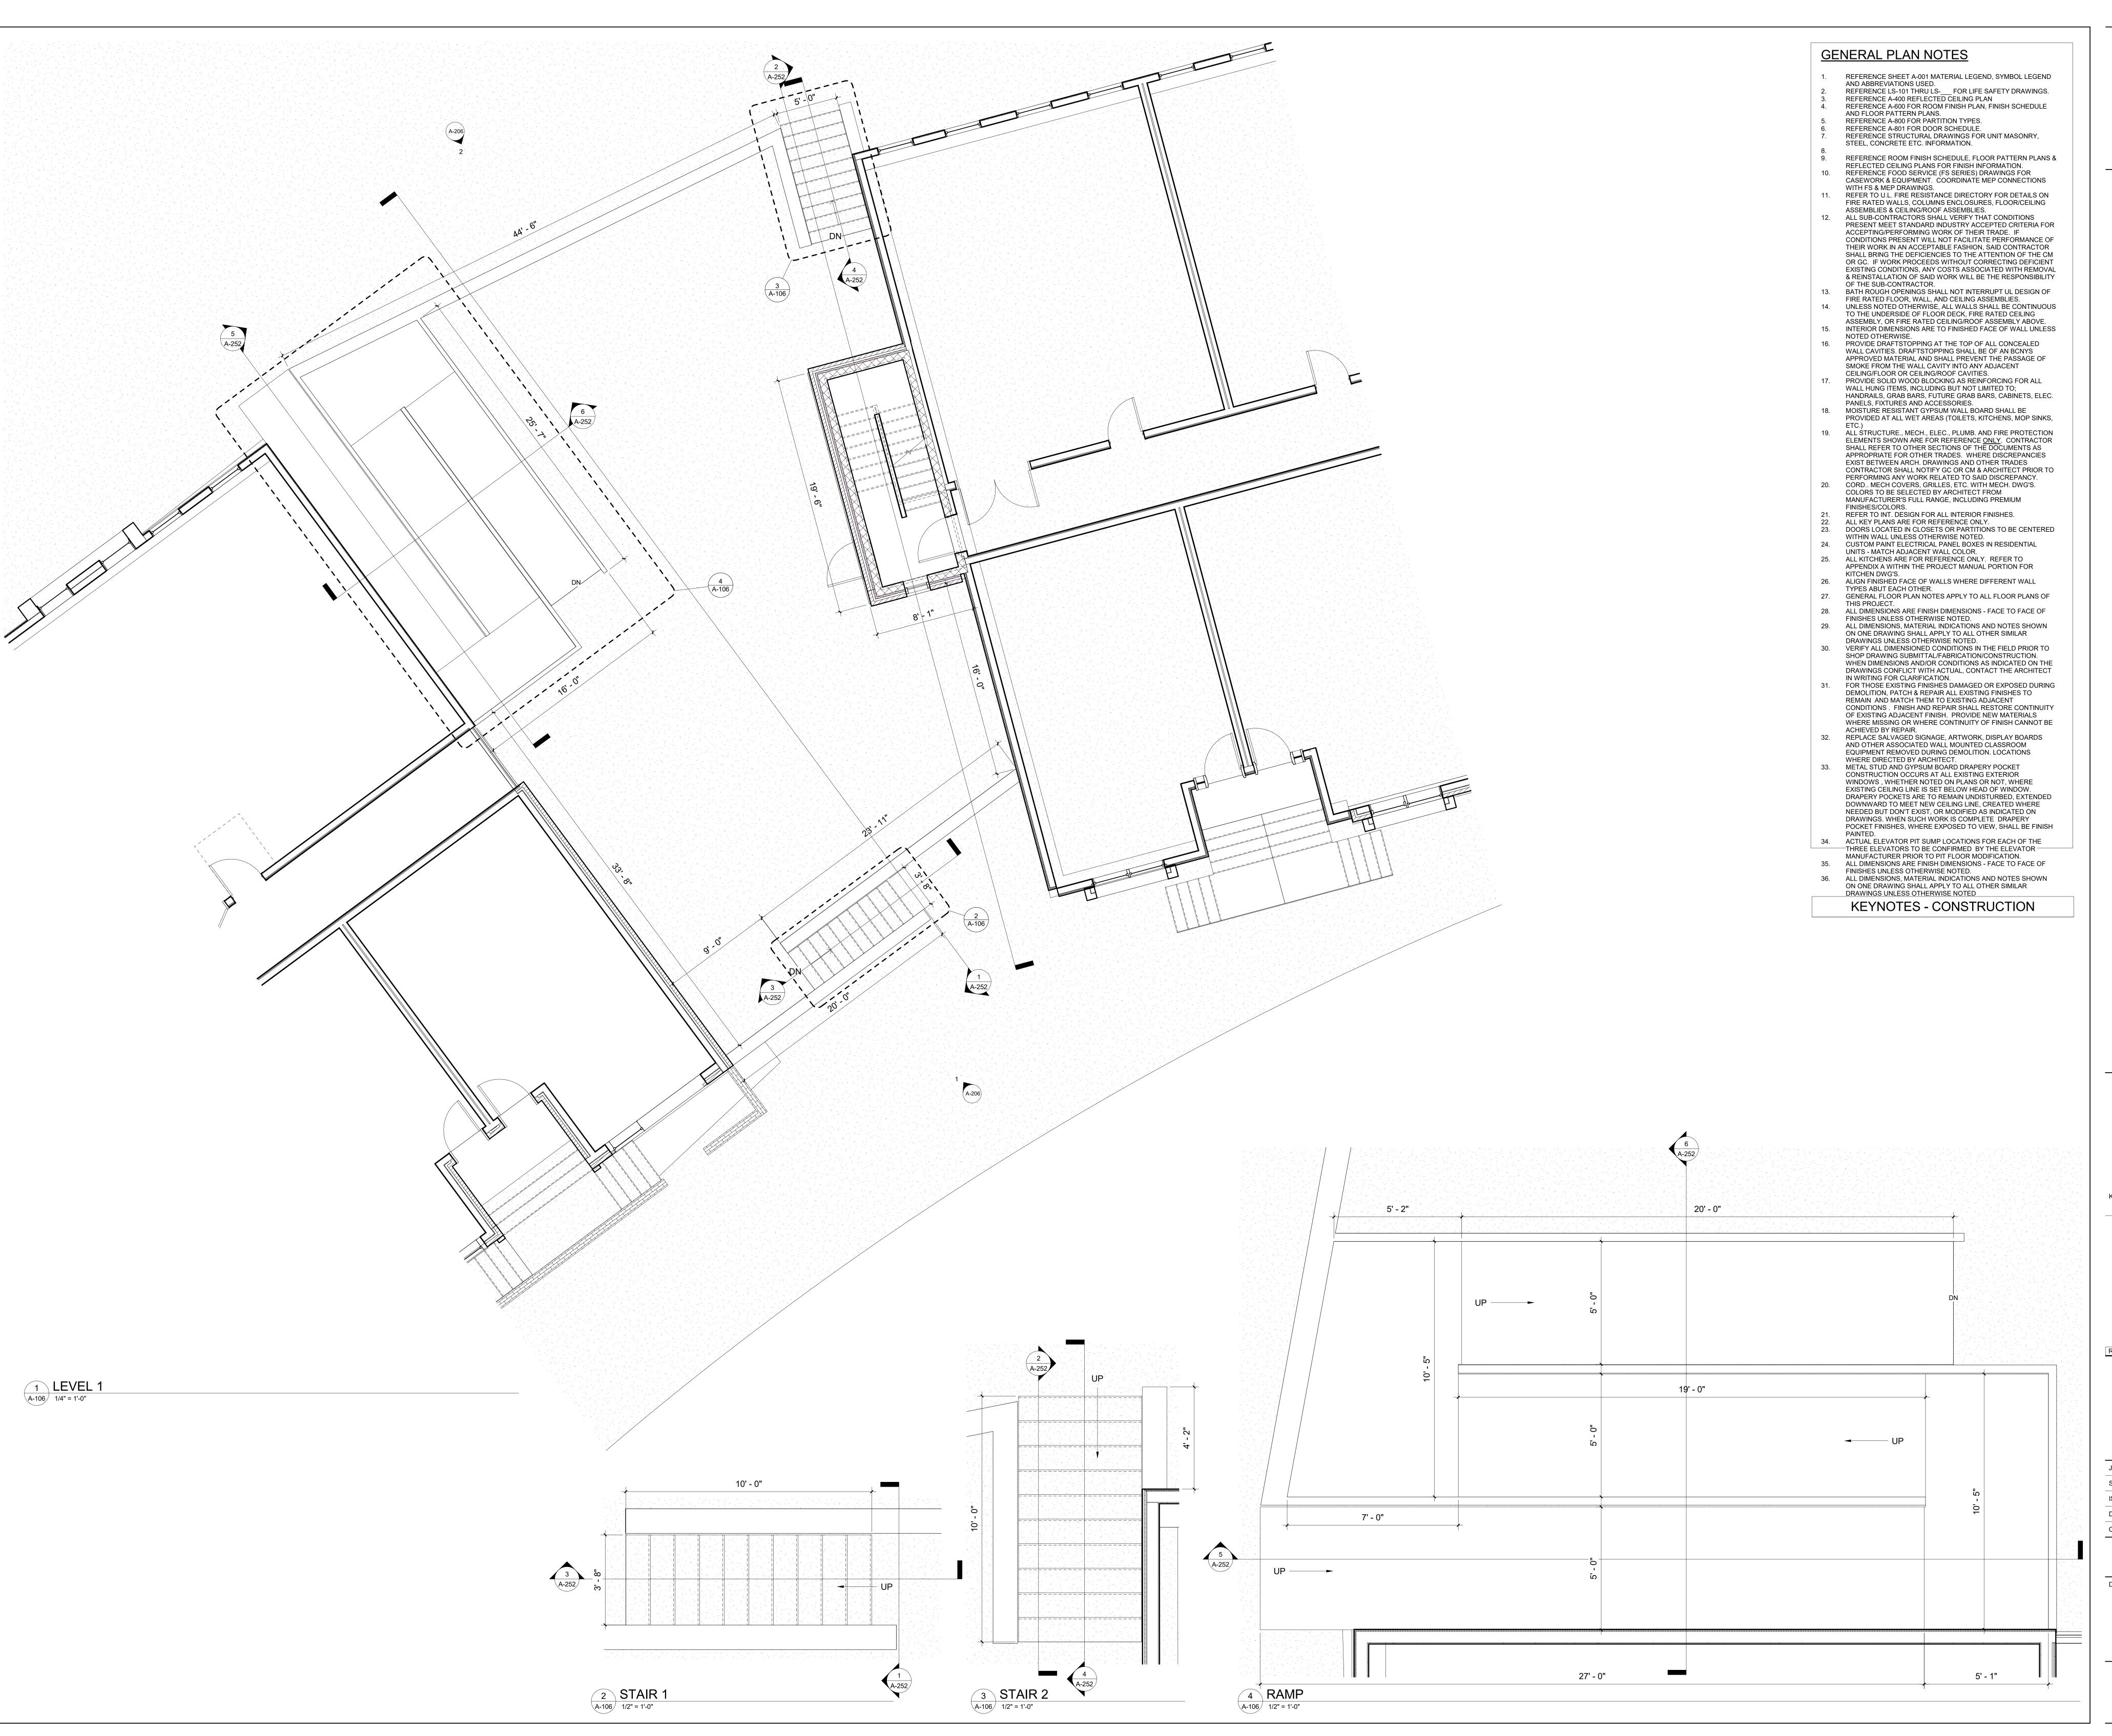

**ADVENTURE PLACE** KEY PLAN

KONAR PROPERTIES

VIDA ON ADVENTURE PLACE

REV. # DESCRIPTION DATE

JOB NO.	1709
SCALE	As indicated
ISSUE DATE	05/06/20
DRAWN BY	KD
CHECKED BY	JG
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FIRST FLOOR RAISED PATIO PLAN

A-106





PERMIT SET



PERMIT SET

ADVENTURE PLACE

KONAR PROPERTIES

**BUILDING B** 


30 ADVENTURE PLACE, ROCHESTER, NEW YORK DESCRIPTION

ISSUE DATE DRAWN BY CHECKED BY

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**ELEVATIONS** 


**A200** 

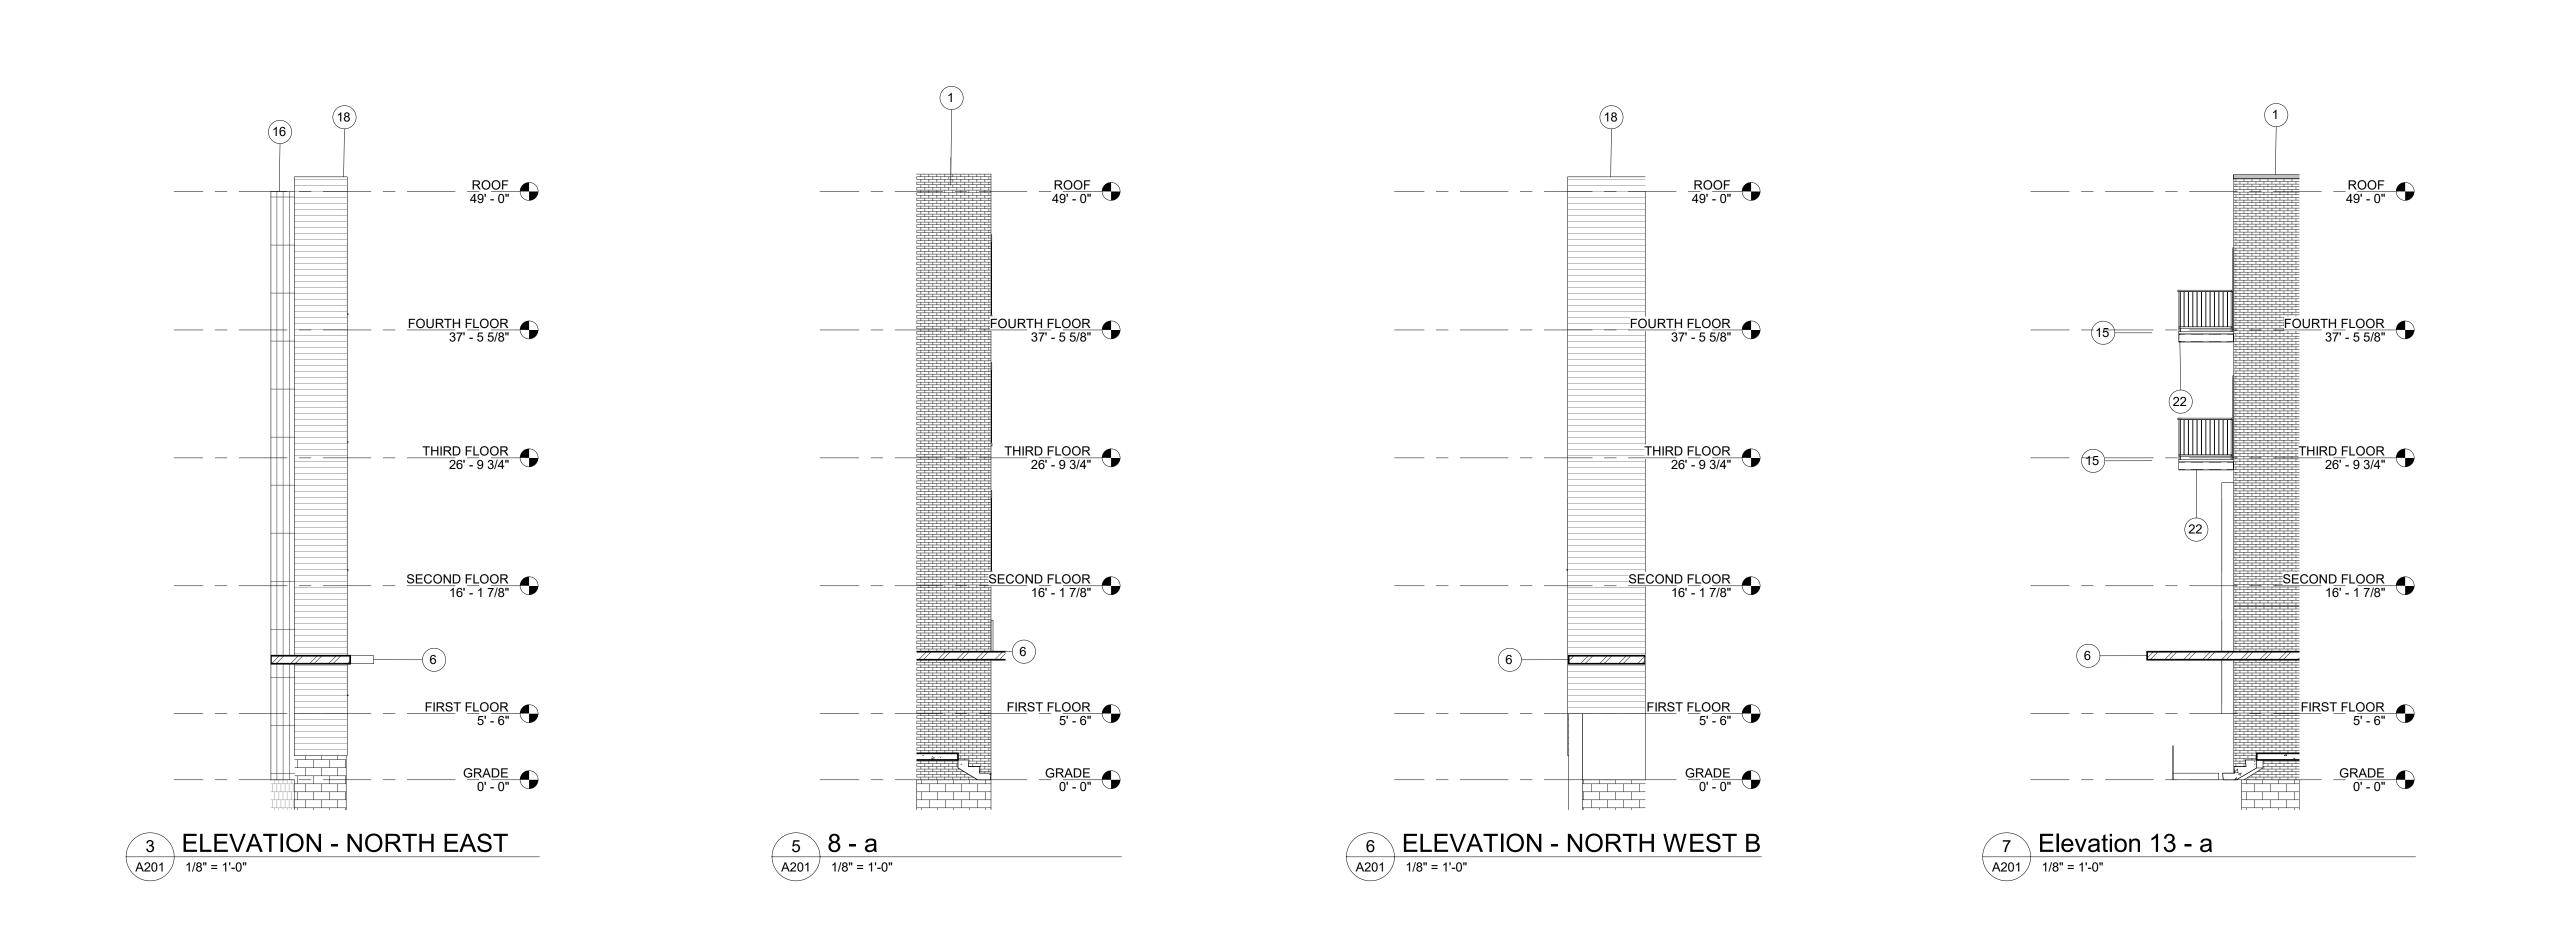

	ALS NOT NECESSARILY USED	
1	FIELD BRICK REDLAND BRICK - PORT ROYAL / GAS FLASHED RANGE / SIZE / TUMBLED (98) TEXTURE ACCENT BRICK BELDEN BRICK - BELCREST BLACK A / MODULAR SIZE	
2	FIELD BRICK MCAVOY BRICK - QUEENSTOWN SHADOWBOX / NORMAN SIZE  FIELD BRICK SIOUX CITY BRICK - SILVERSTONE GREY / MODULAR SIZE ACCENT BRICK TAYLOR CLAT PRODUCTS #323 GREY WIRECUT	
3		
4	CEMENTITIOUS LAP SIDING - SMOOTH 7" - COLOR - PAINTED WHITE (( ARCHITECT)	COLOR BY
5	CEMENTITIOUS LAP SIDING - SMOOTH 7" - COLOR - PAINTED BLUE (COLOR - PAINTED)	OLOR BY
6	TRESPA PURA / SIDINGS / WOOD DECORS / PU08 / ROMANTIC WALNUT / MATT / FLUSH / BROWN CORE  EFCO ANODIZED ALUMINUM CURTAINWALL - ULTRAPON 70% PVDF - BLACK  ATAS METAL PANEL - VERSA-LINE (VSN 120) .032 - LENGTH 6' - SMOOTH - BLACK  CANOPY GALV. STRUCTURAL STEEL, PAINTED SATIN BLACK POWDER COAT  CORTEN STEEL PANEL - SANDBLASTED AND WET  36" ALUMINIUM PICKET (QUAD SPEAR AND BALL) FENCE WITH SELF CLOSING HINGE GATE, BLACK  CANOPY - MAPES LUMISHADE ANODIZED ALUMINUM - COLOR BY ARCHITECT  PRECAST STONE SILL	
7		
8		
9		
10		
11		
12		
13		
14	JULIETTE BALCONY - GALV. STEEL, PAINTED SATIN BLACK POWDER COAT	
15	HUNG BALCONY - GALV. STEEL, PAINTED SATIN BLACK POWDER COAT  CEMENTITIOUS WALL PANEL 4'X8' WITH EZ TRIM  ANODIZED ALUMINUM EXTRUSION - BLACK  CEMENTITIOUS LAP SIDING - SMOOTH 7" - COLOR - GREY (COLOR BY ARCHITECT)	
16		
17		
18		
19	CEMENTITIOUS LAP SIDING - SMOOTH 7" - COLOR - VIDA GREEN	
20	ANODIZED BLACK ALUMINUM PANEL	
21	TRESPA METEON / EXTERIOR / UNI COLOURS / A04.1.7 / GOLD YELLOW / SATIN	
22	TRESPA METEON / EXTERIOR / UNI COLOURS / A22.1.6 / ROYAL BLUE / SATIN	
23	TRESPA METEON / EXTERIOR / UNI COLOURS / A37.0.8 / LIME GREEN / SATIN	
24	TRESPA METEON / EXTERIOR / WOOD DECORS / NWO8 / ITALIAN WALNUT / SATIN (HPL-1)	

UNDERSIDE OF ALL CANOPIES AND BALCONIES



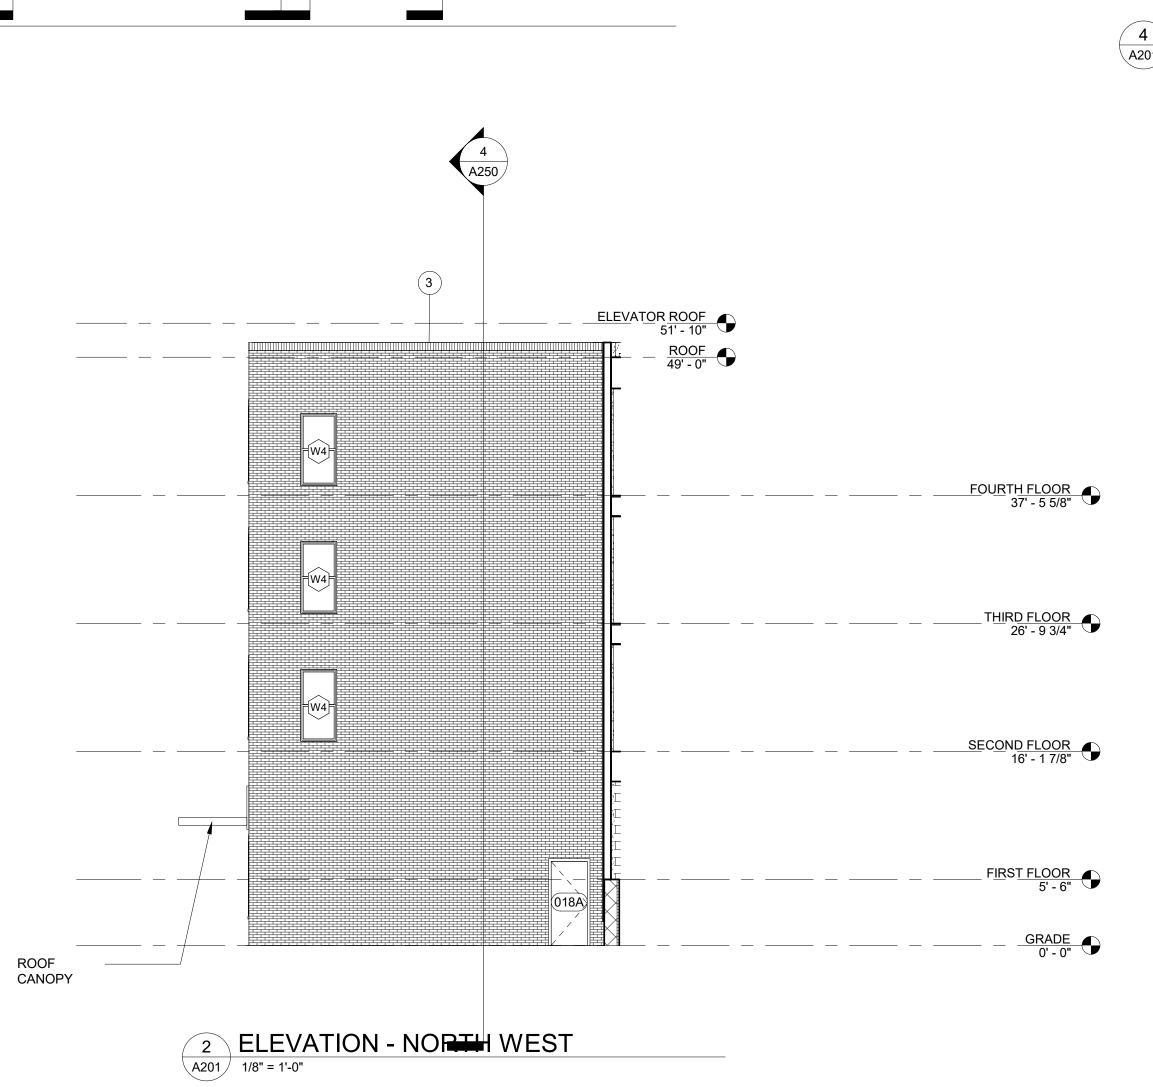



ARCHITECTS


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ADVENTURE PLACE
KEY PLAN

KONAR PROPERTIES

**BUILDING B** 

30 ADVENTURE PLACE,
ROCHESTER, NEW YORK
14607
REV. # DESCRIPTION DATE


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ISSUE DATE	05/08/20
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INTERPRETATION OF THE INFORMATION
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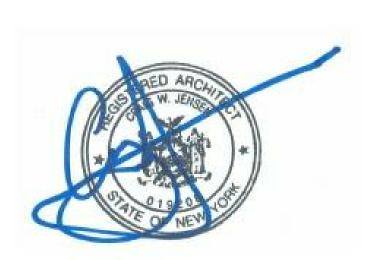
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**ELEVATIONS** 

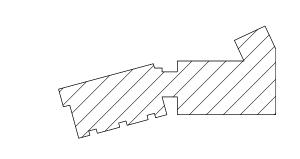A201









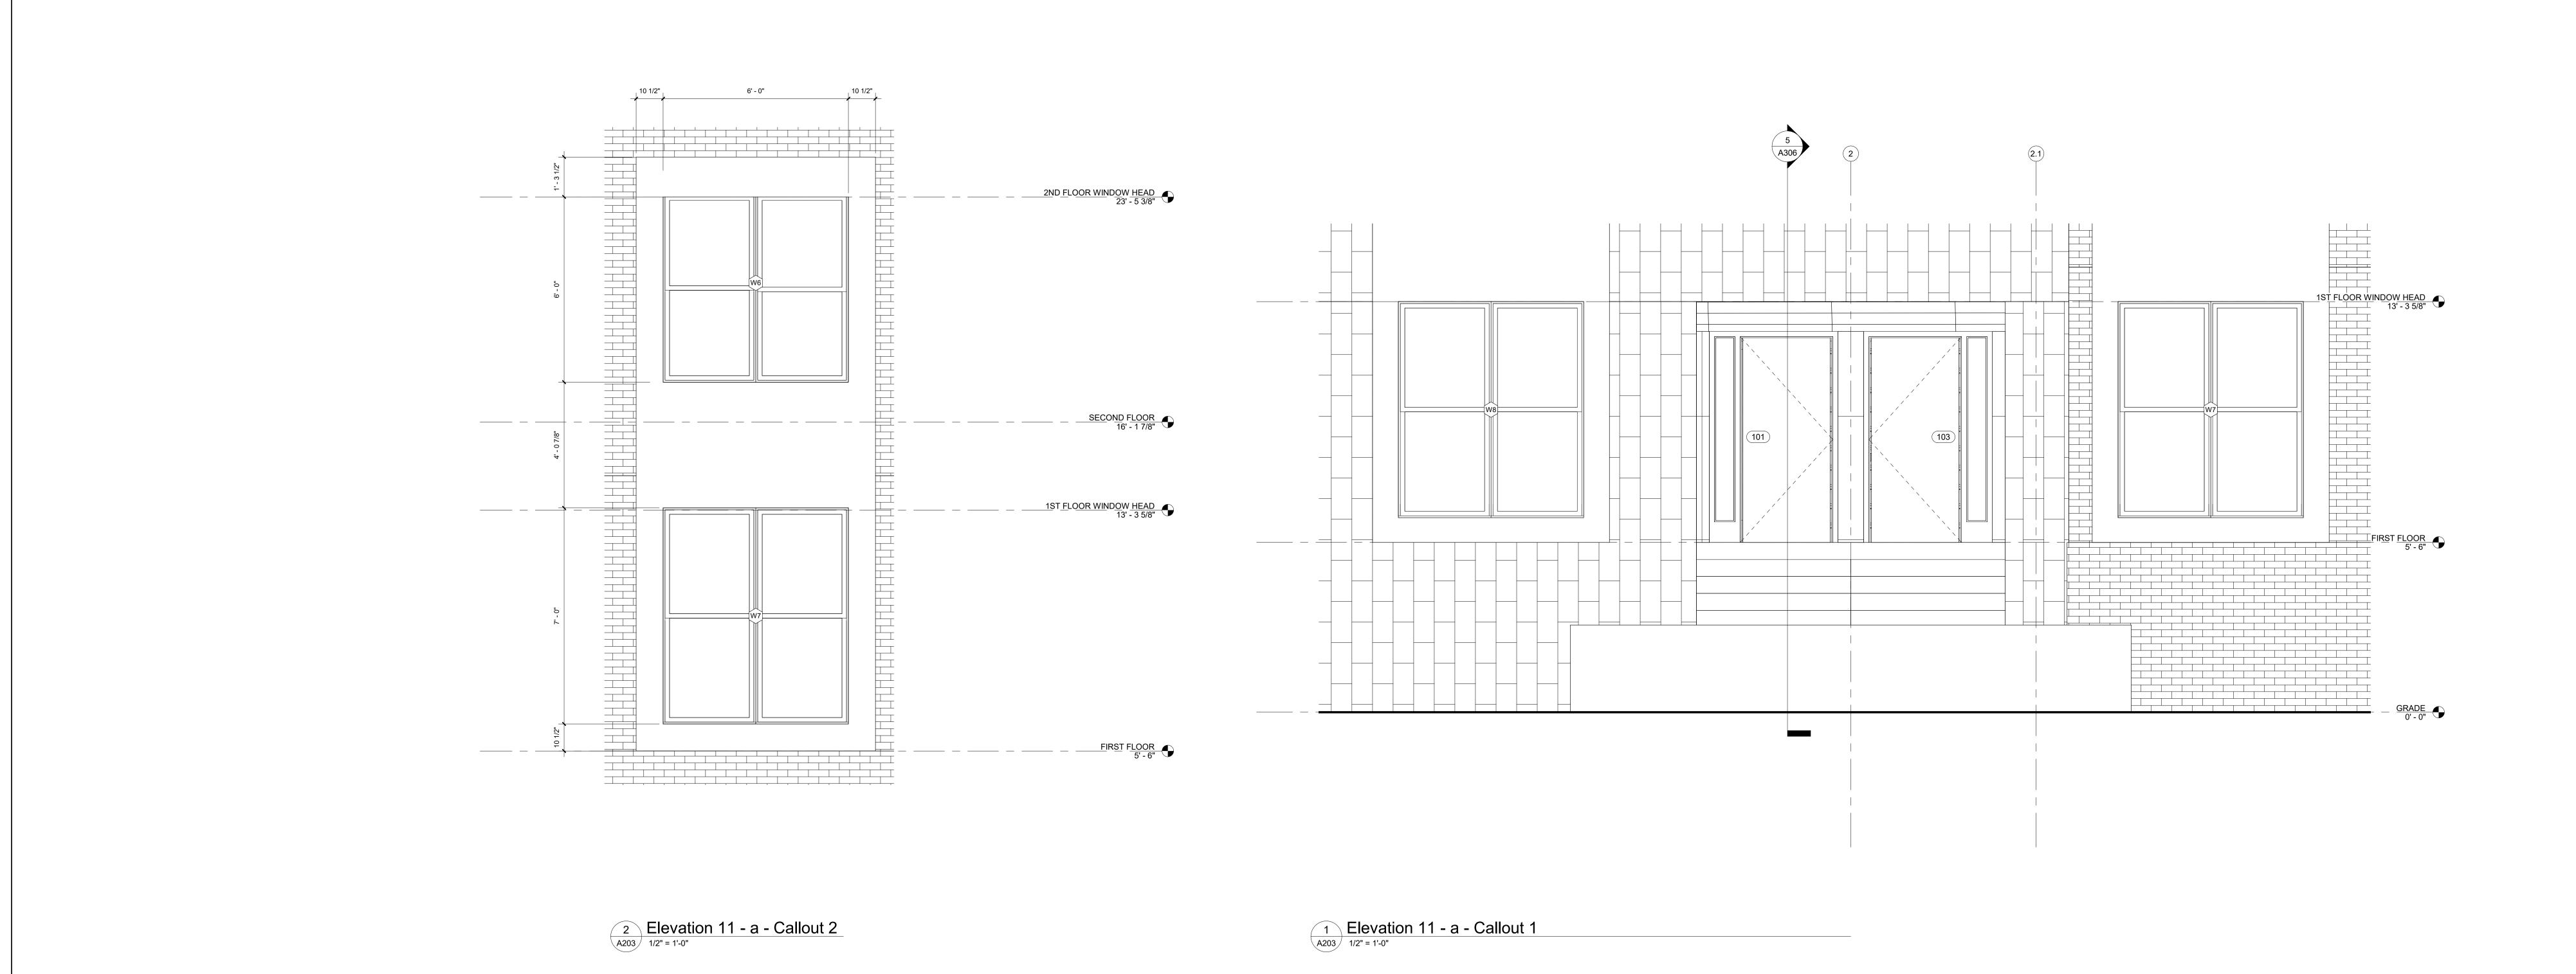



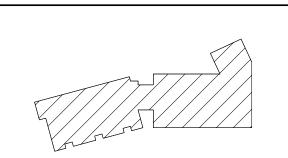


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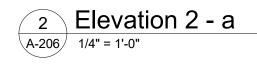


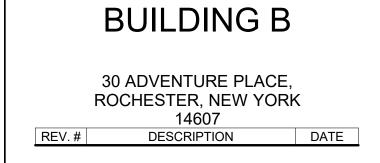
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DETAIL **ELEVATIONS** 

**A203** 





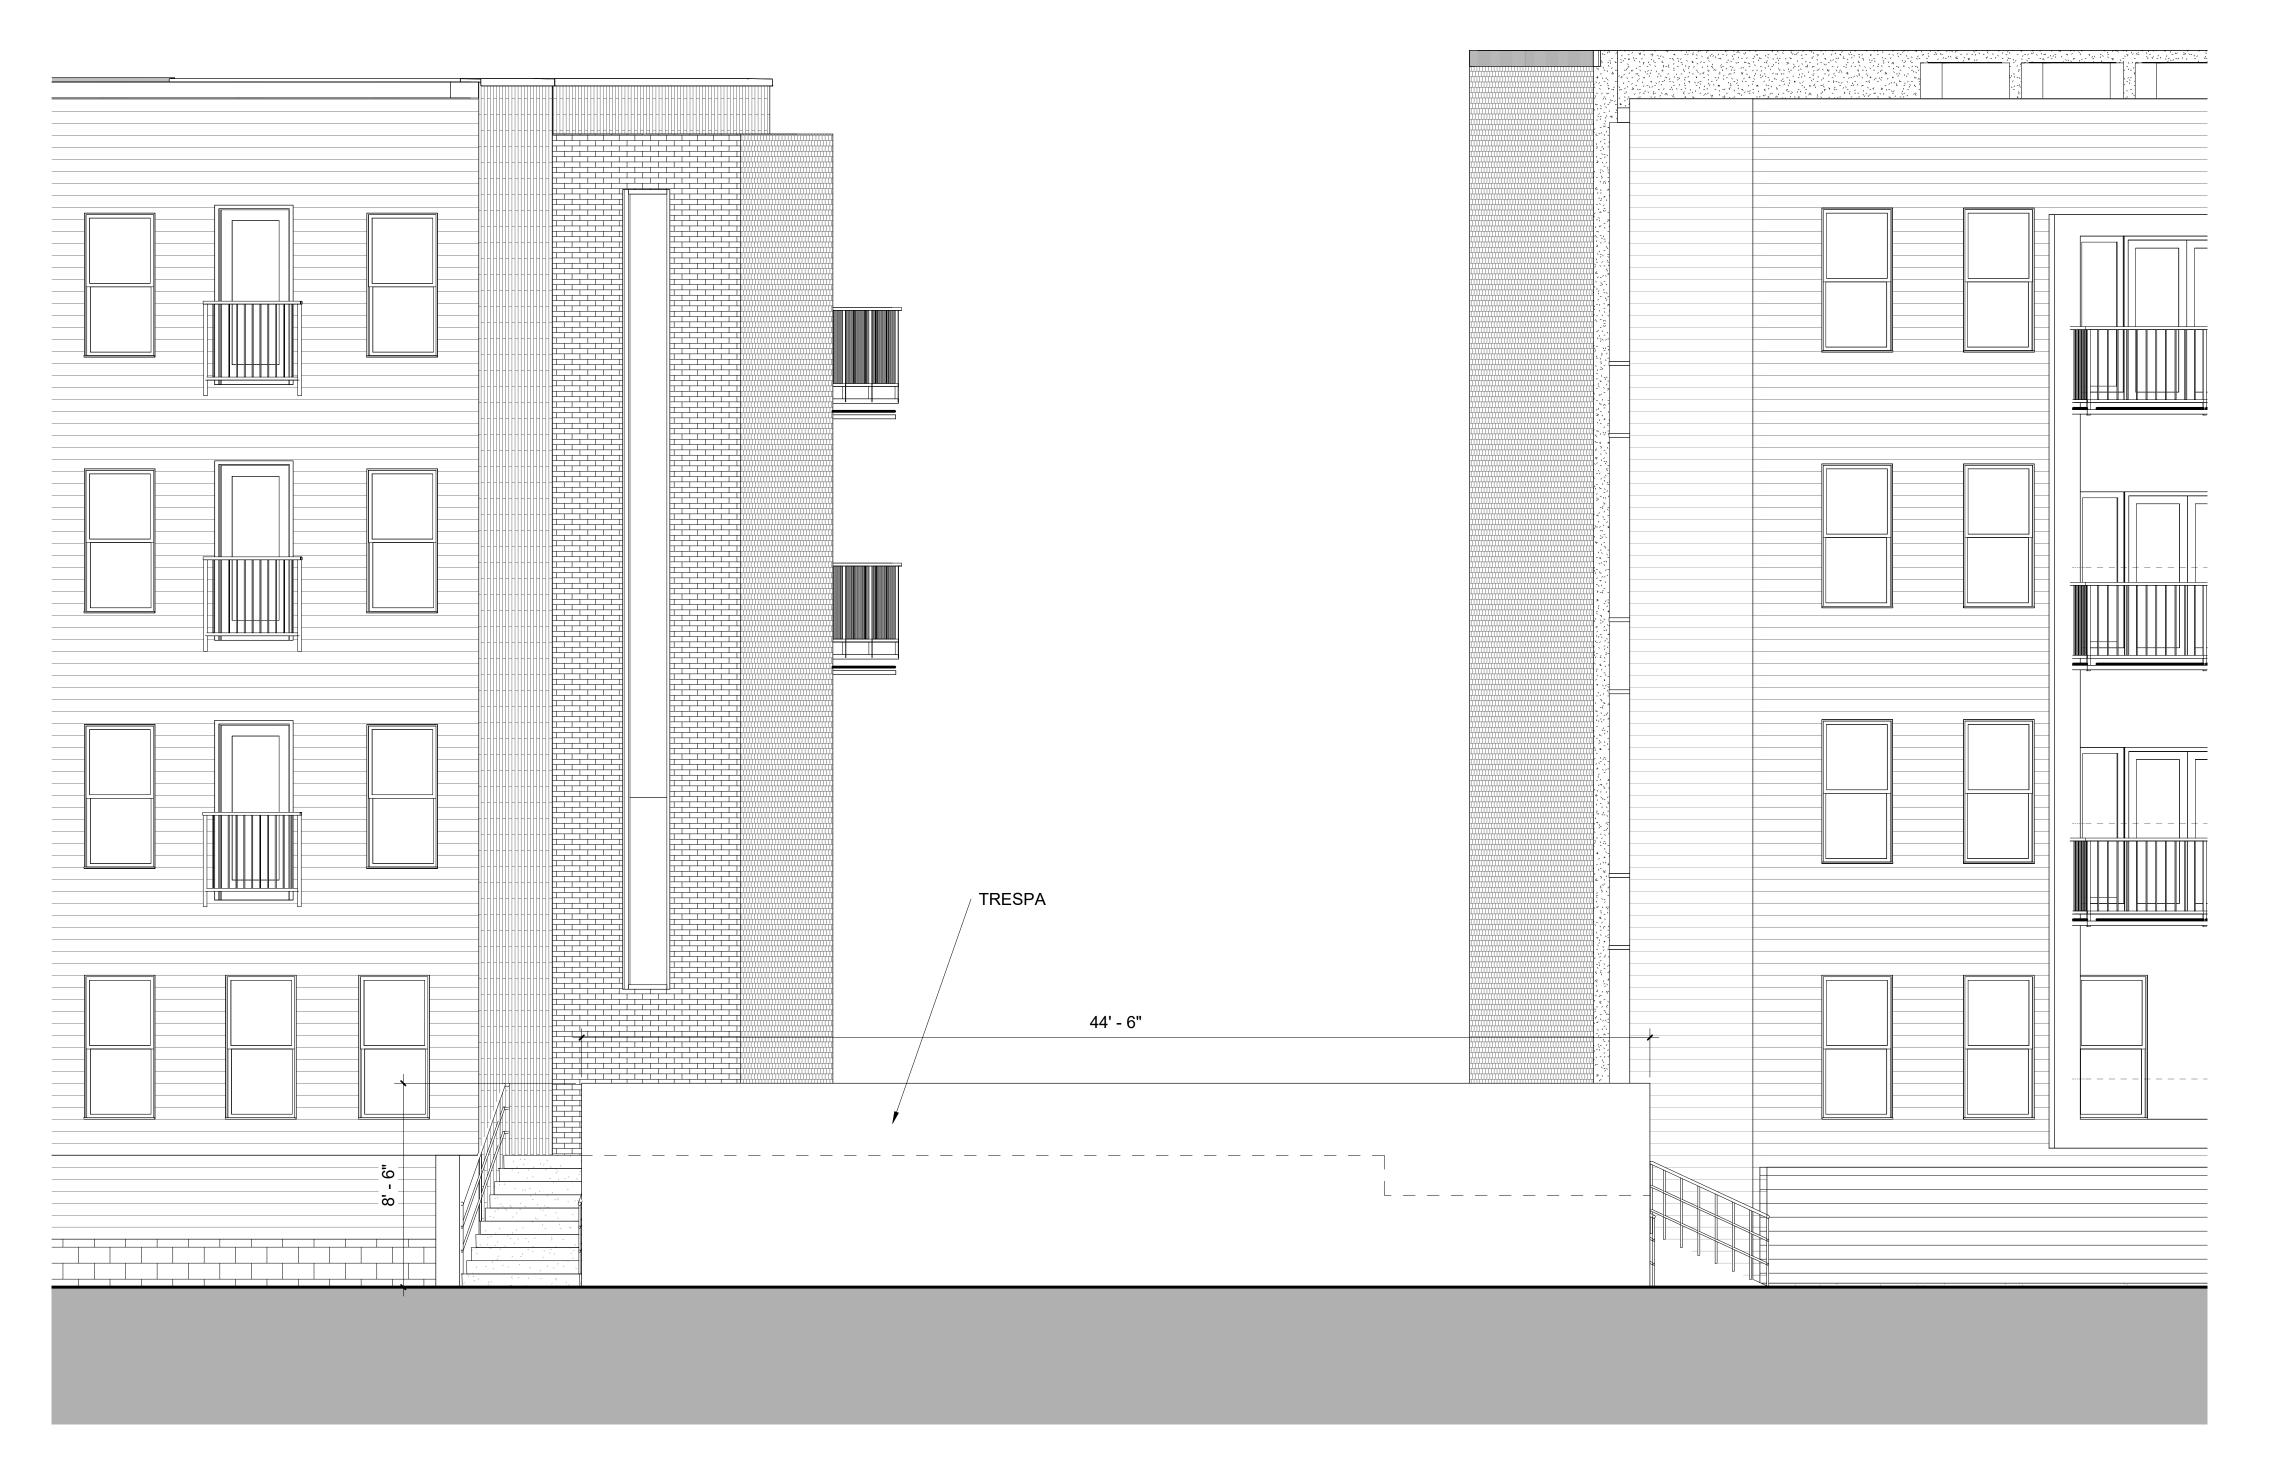

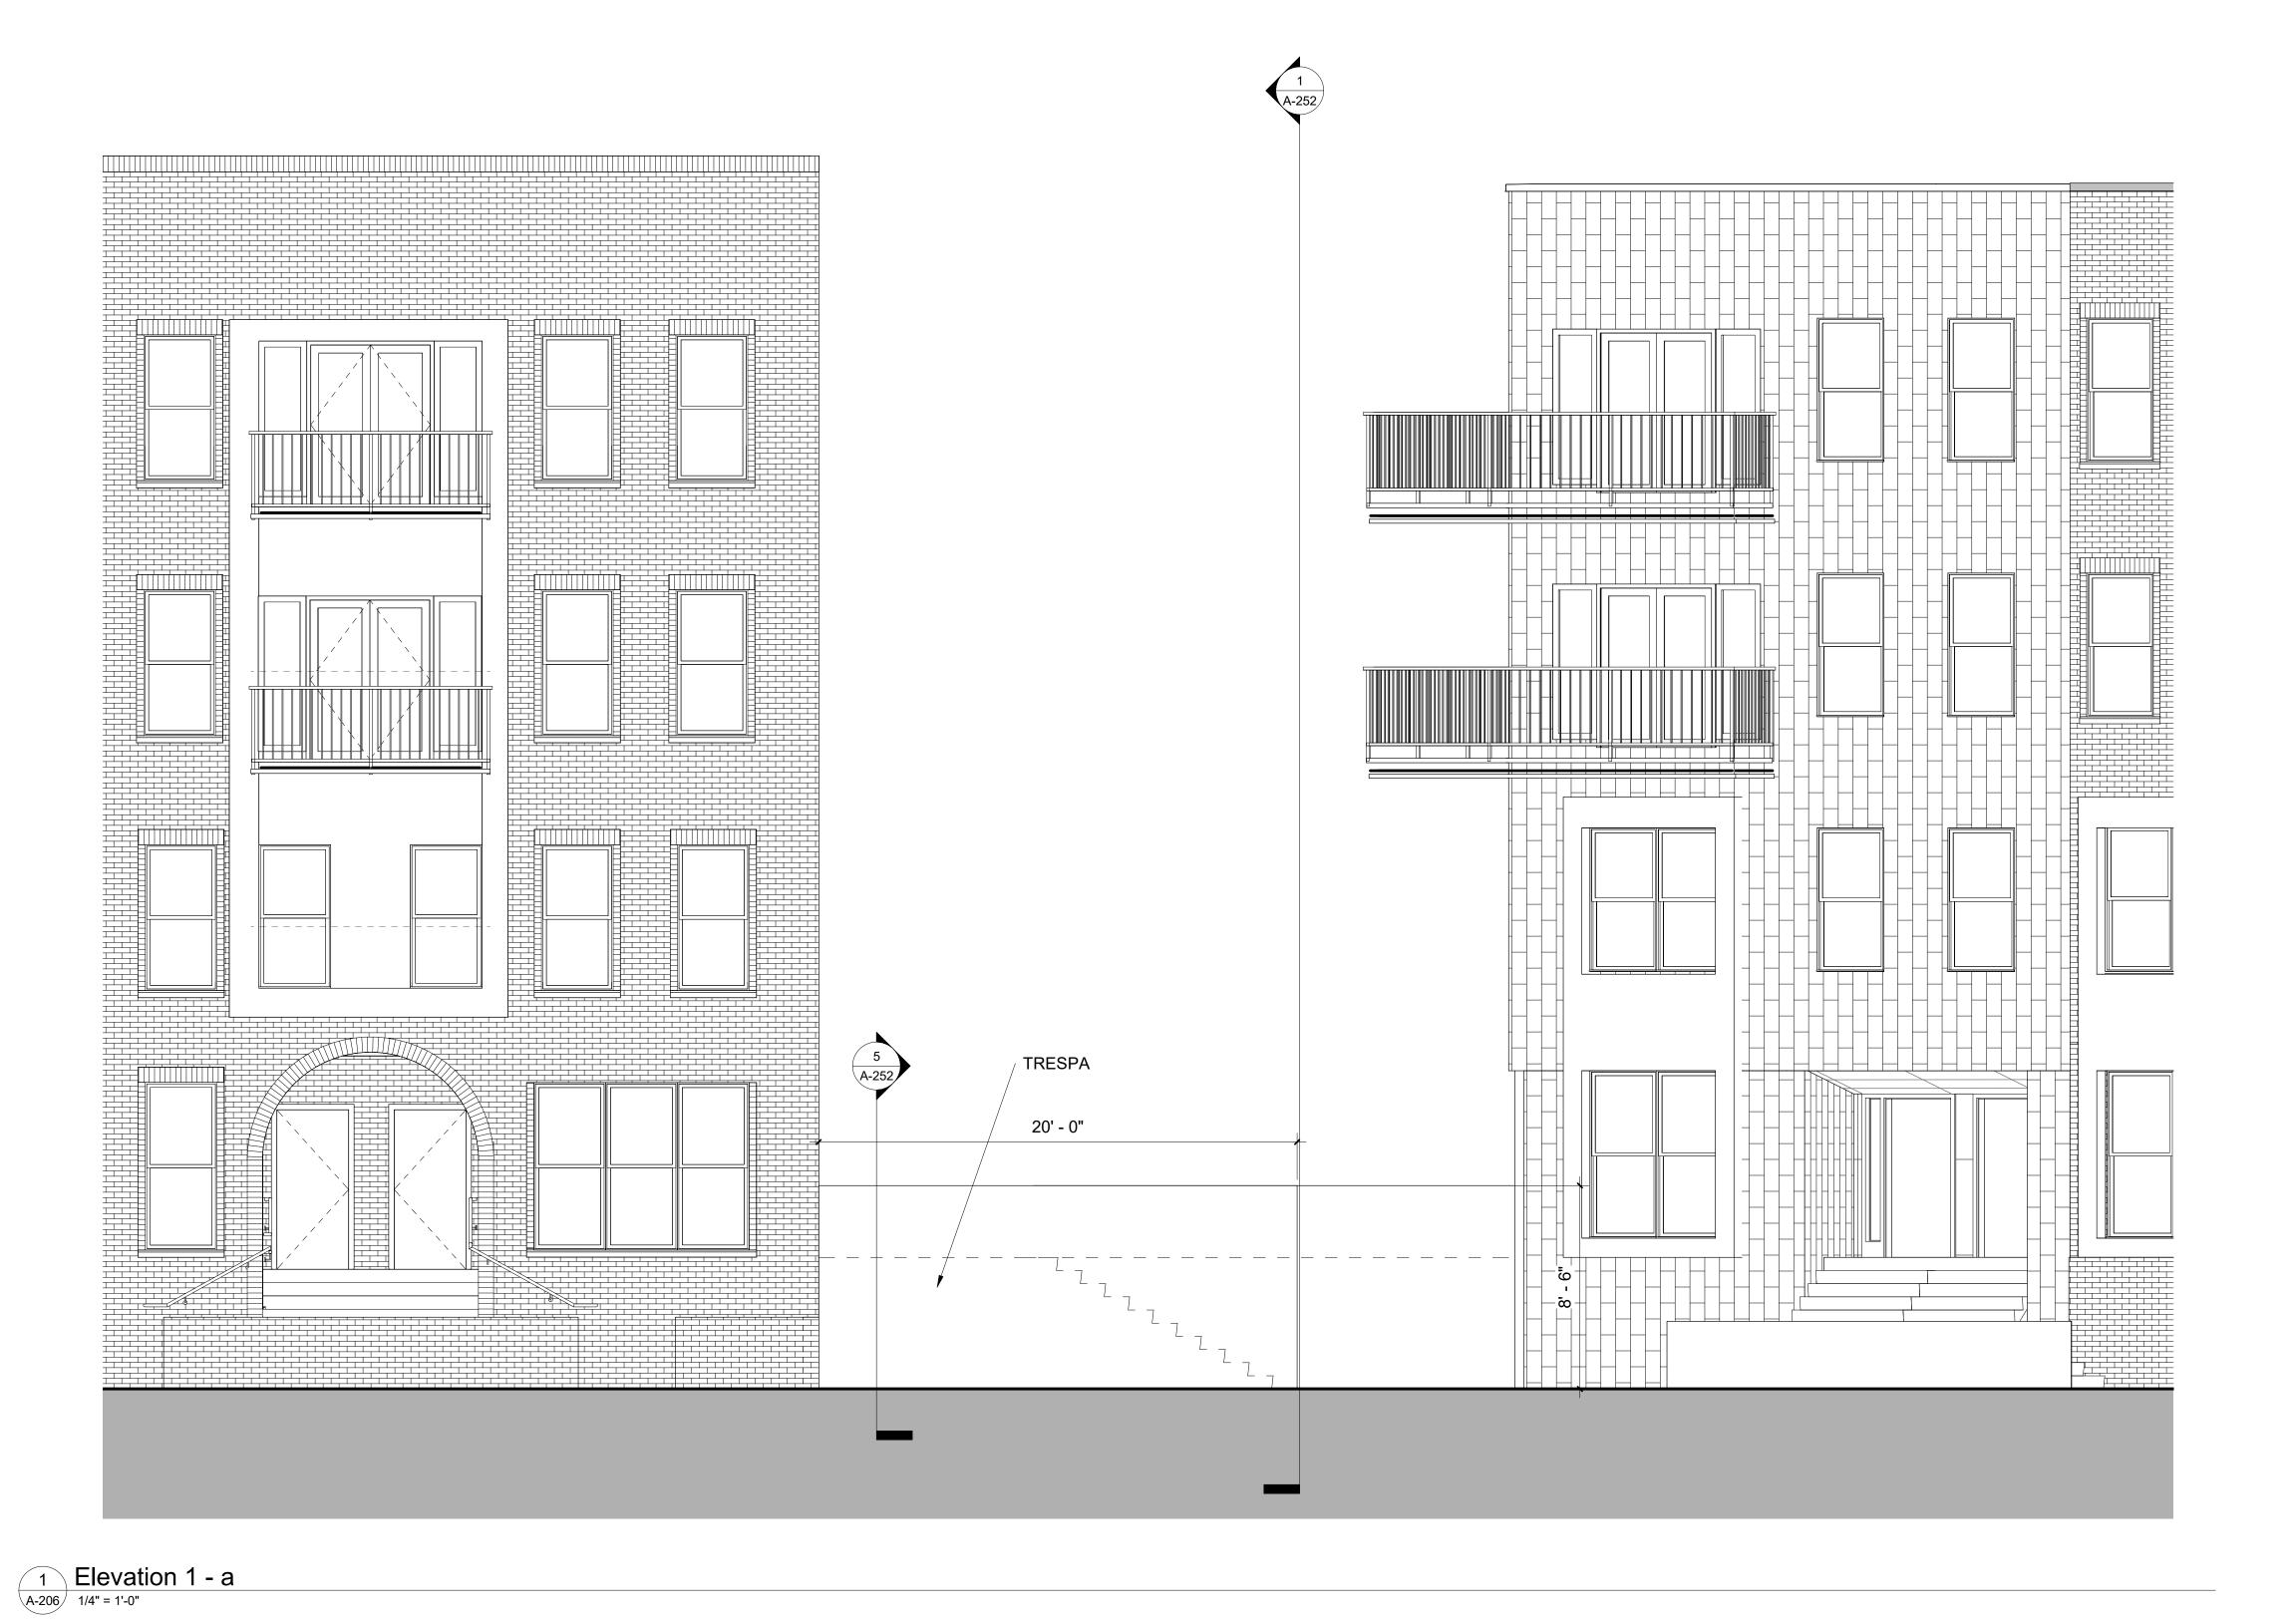

	LS NOT NECESSARILY USED
1	FIELD BRICK REDLAND BRICK - PORT ROYAL / GAS FLASHED RANGE / MODULAR SIZE / TUMBLED (98) TEXTURE ACCENT BRICK BELDEN BRICK - BELCREST BLACK A / MODULAR SIZE / 16-49
2	FIELD BRICK MCAVOY BRICK - QUEENSTOWN SHADOWBOX / NORMAN SIZE
3	FIELD BRICK SIOUX CITY BRICK - SILVERSTONE GREY / MODULAR SIZE ACCENT BRICK TAYLOR CLAT PRODUCTS #323 GREY WIRECUT
4	CEMENTITIOUS LAP SIDING - SMOOTH 7" - COLOR - PAINTED WHITE (COLOR BY ARCHITECT)
5	CEMENTITIOUS LAP SIDING - SMOOTH 7" - COLOR - PAINTED BLUE (COLOR BY ARCHITECT)
6	TRESPA PURA / SIDINGS / WOOD DECORS / PU08 / ROMANTIC WALNUT / MATT / FLUSH / BROWN CORE
7	EFCO ANODIZED ALUMINUM CURTAINWALL - ULTRAPON 70% PVDF - BLACK
8	ATAS METAL PANEL - VERSA-LINE (VSN 120) .032 - LENGTH 6' - SMOOTH - BLACK
9	CANOPY GALV. STRUCTURAL STEEL, PAINTED SATIN BLACK POWDER COAT
10	CORTEN STEEL PANEL - SANDBLASTED AND WET
11	36" ALUMINIUM PICKET (QUAD SPEAR AND BALL) FENCE WITH SELF CLOSING HINGE GATE, BLACK_
12	CANOPY - MAPES LUMISHADE ANODIZED ALUMINUM - COLOR BY ARCHITECT
13	PRECAST STONE SILL
14	JULIETTE BALCONY - GALV. STEEL, PAINTED SATIN BLACK POWDER COAT
15	HUNG BALCONY - GALV. STEEL, PAINTED SATIN BLACK POWDER COAT
16	BRICK WALL
17	ANODIZED ALUMINUM EXTRUSION - BLACK
18	CEMENTITIOUS LAP SIDING - SMOOTH 7" - COLOR - GREY (COLOR BY ARCHITECT)
19	CEMENTITIOUS LAP SIDING - SMOOTH 7" - COLOR - VIDA GREEN
20	ANODIZED BLACK ALUMINUM PANEL

UNDERSIDE OF ALL **CANOPIES** AND

TRESPA METEON / EXTERIOR / UNI COLOURS / A04.1.7 / GOLD YELLOW / SATIN TRESPA METEON / EXTERIOR / UNI COLOURS / A22.1.6 / ROYAL BLUE / SATIN\_\_\_\_\_ TRESPA METEON / EXTERIOR / UNI COLOURS / A37.0.8 / LIME GREEN / SATIN TRESPA METEON / EXTERIOR / WOOD DECORS / NWO8 / ITALIAN WALNUT / SATIN (HPL-1)



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ADVENTURE PLACE KEY PLAN

KONAR PROPERTIES

REV. # DESCRIPTION DATE


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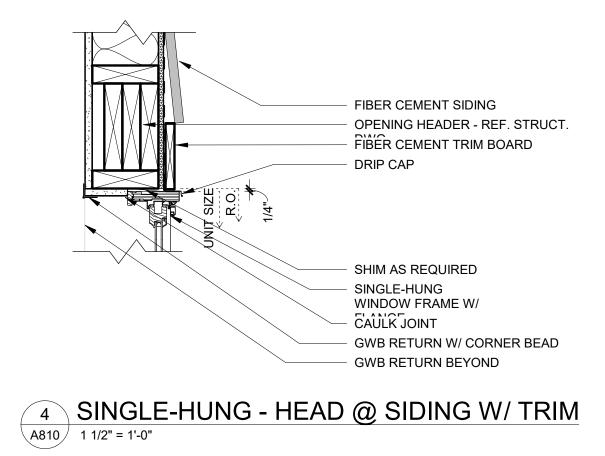
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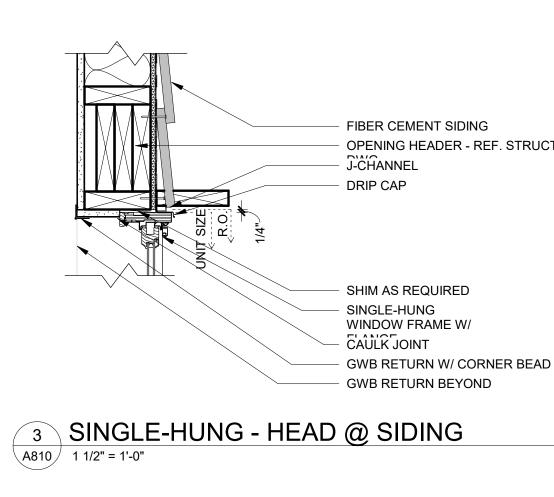
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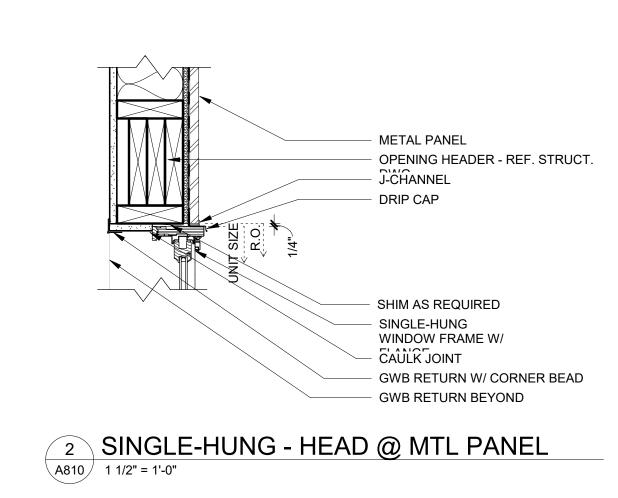
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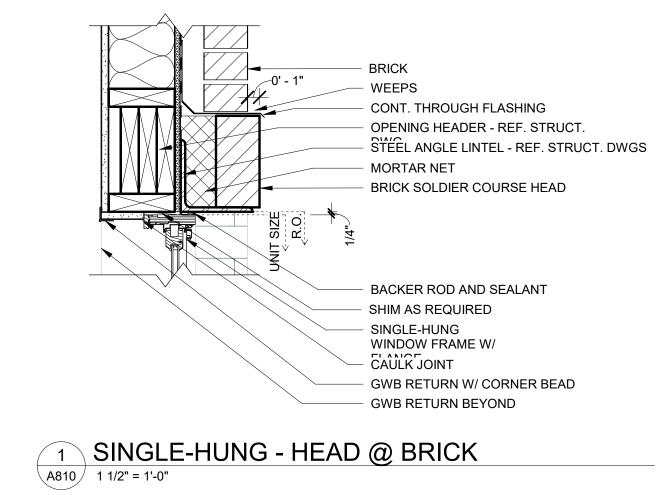
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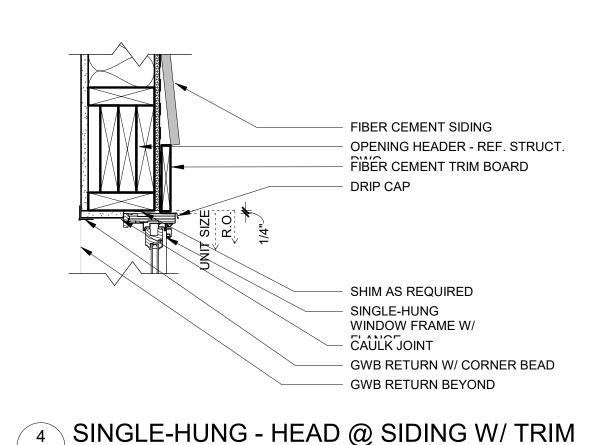














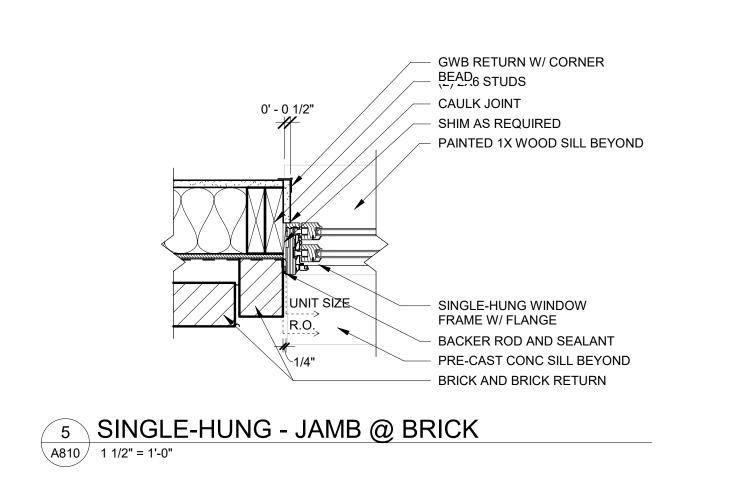


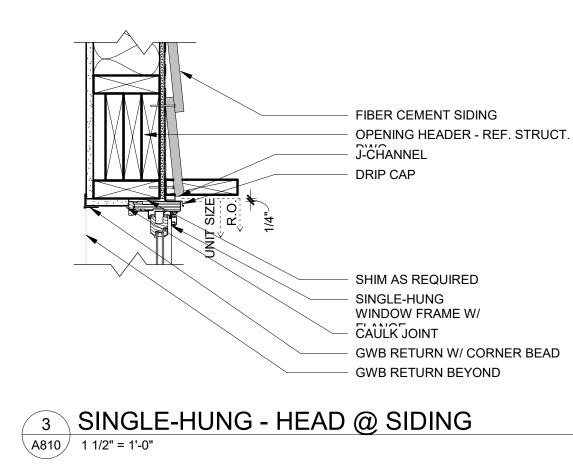


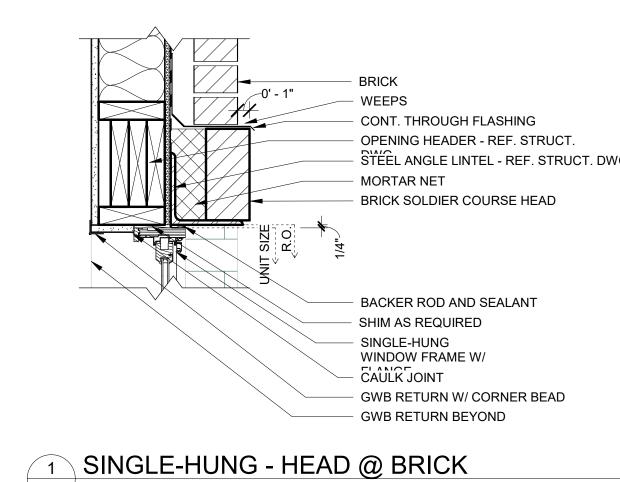


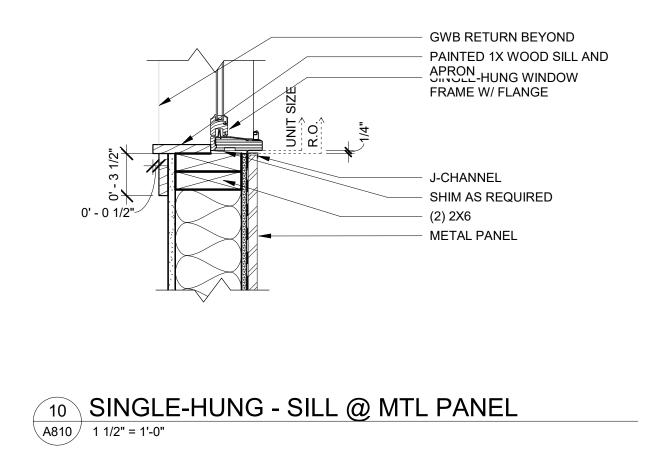

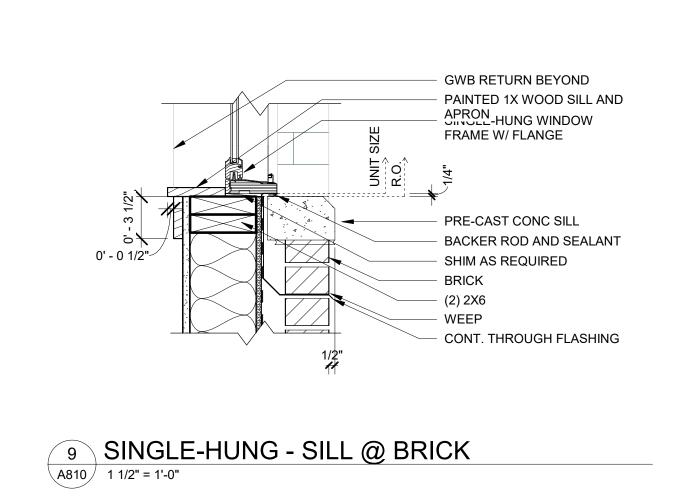


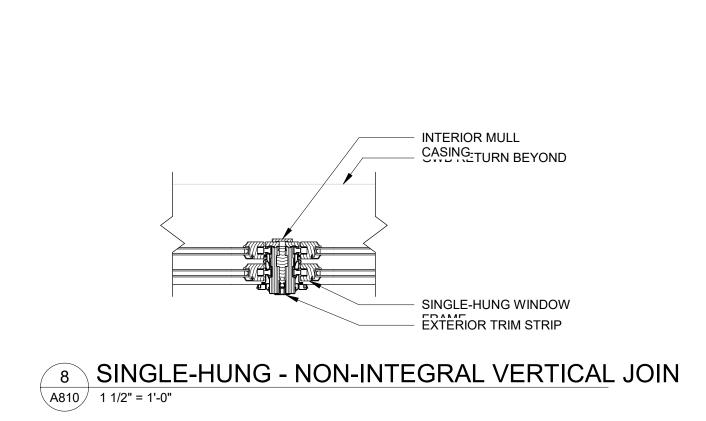


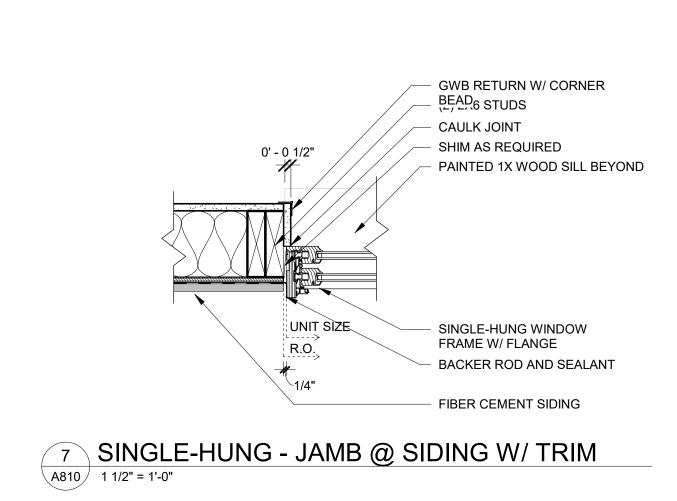

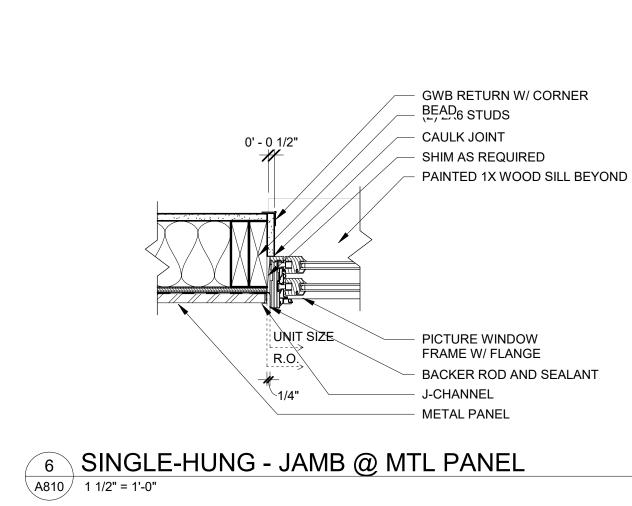

0' - 0 1/2"~

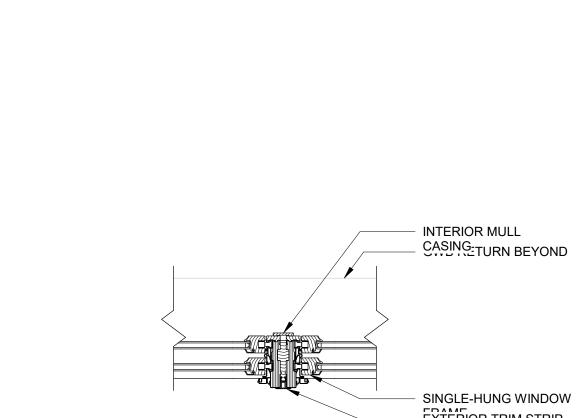

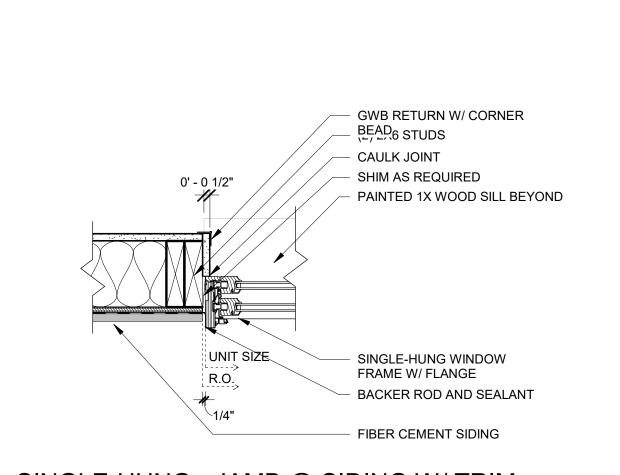

GWB RETURN BEYOND

- APRON-HUNG WINDOW FRAME W/ FLANGE


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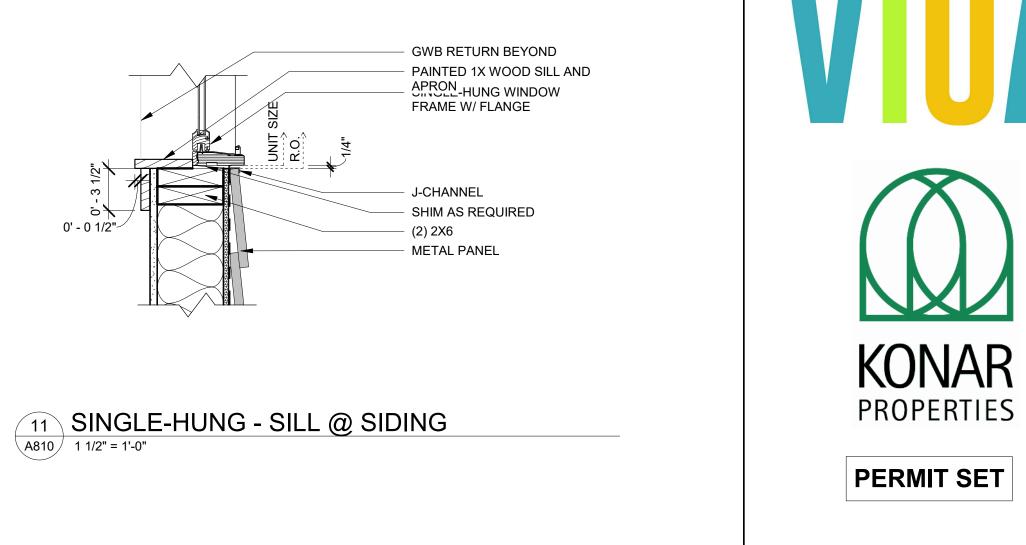
FIBER CEMENT SIDING


5-1/2" FIBER CEMENT TRIM BOARD


(2) 2X6

- PAINTED 1X WOOD SILL AND



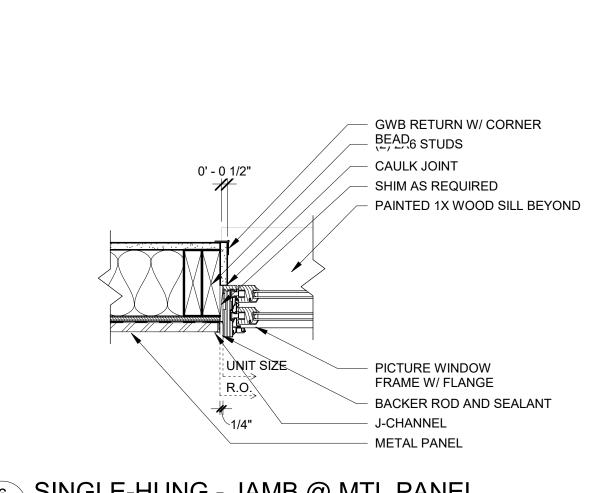

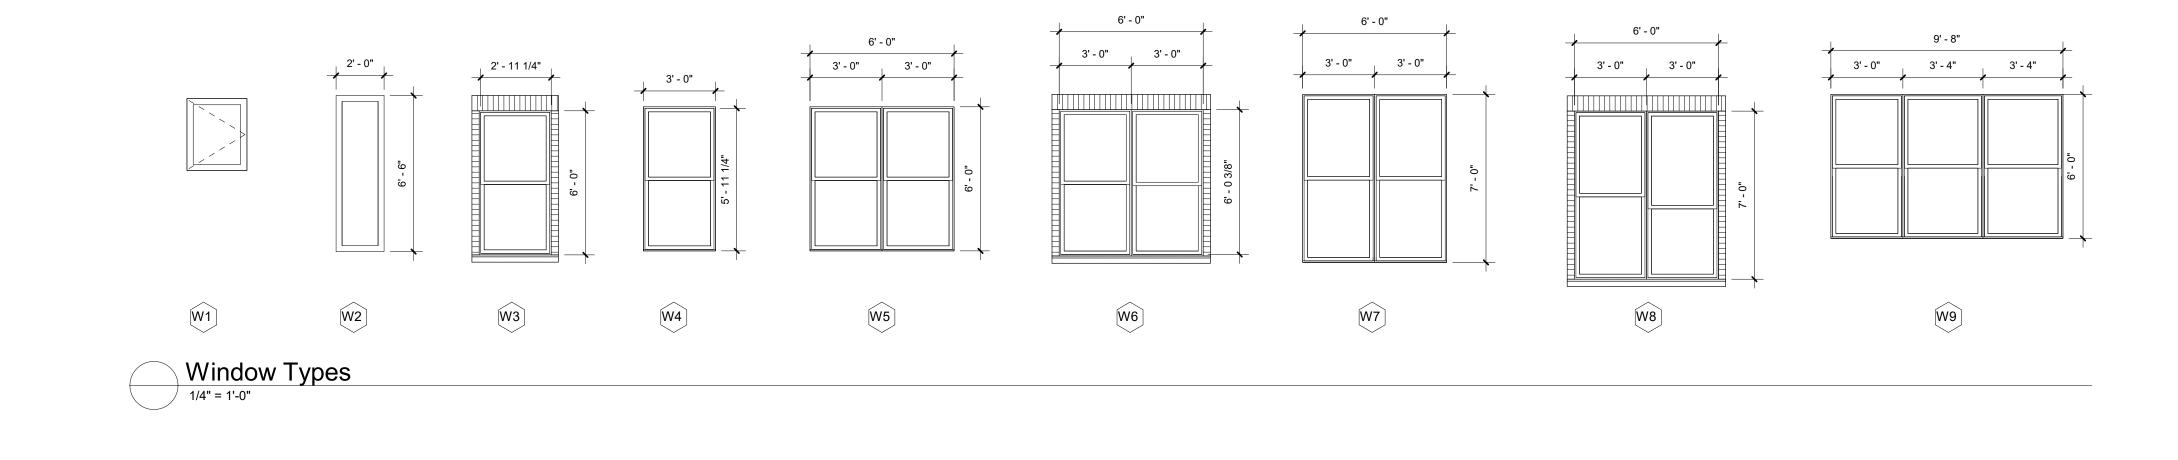

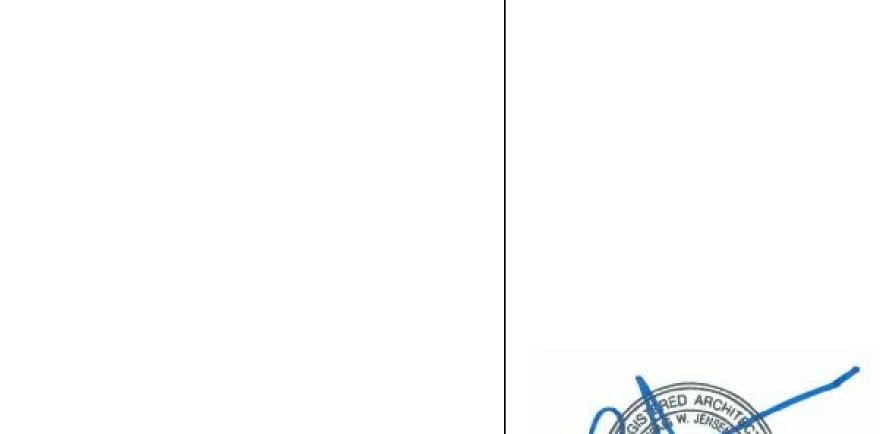

ARCHITECTS

**BUFFALO | ROCHESTER** 

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PERMIT SET

**GENERAL WINDOW NOTES** 

ADJACENT CONSTRUCTION.

CONSTRUCTION DETAILS.

MATERIAL & COLOR.

A812 ARE DRAWN BY WINDOW MFR WEATHER SHIELD.

1. ALL PROPOSED WINDOW DETAILS ON SHEETS A-810 THRU

SERIES' - ALUM CLAD WOOD WINDOWS WITH FACTORY AAMA 2605

2. ALL PROPOSED WINDOWS TO BE FROM MFR'S 'PREMIUM


FINISH ON THE EXTERIOR. INTERIOR TO BE PINE FACTORY PRIMED & PAINTED, COLOR TBD BY INTERIOR DESIGNER. 3. DRAWINGS ARE FOR COMPARING WINDOW PROFILES ONLY AND DOES NOT DETAIL METHOD FOR ATTACHMENT INTO

4. COORDINATE WITH WINDOW MFR FOR ALL BUILDING

STAINING, RESTORING OPERABILITY, REPLACING ANY

5. ALL ORIGINAL WOOD WINDOWS TO BE RESTORED WILL INCLUDE BUT WILL NOT BE LIMITED TO SCRAPING & PAINTING,

MISSING/BROKEN PARTS WITH SIMILAR QUALITY, MATCHING PROFILE,

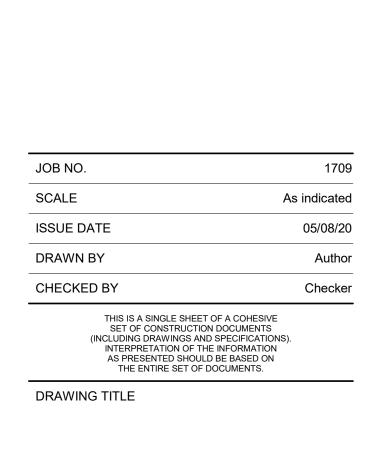

ADVENTURE PLACE

KONAR PROPERTIES

**BUILDING B** 


30 ADVENTURE PLACE, ROCHESTER, NEW YORK

14607
DESCRIPTION DATE


KEY PLAN

A810 PERMIT SET

WINDOW DETAILS

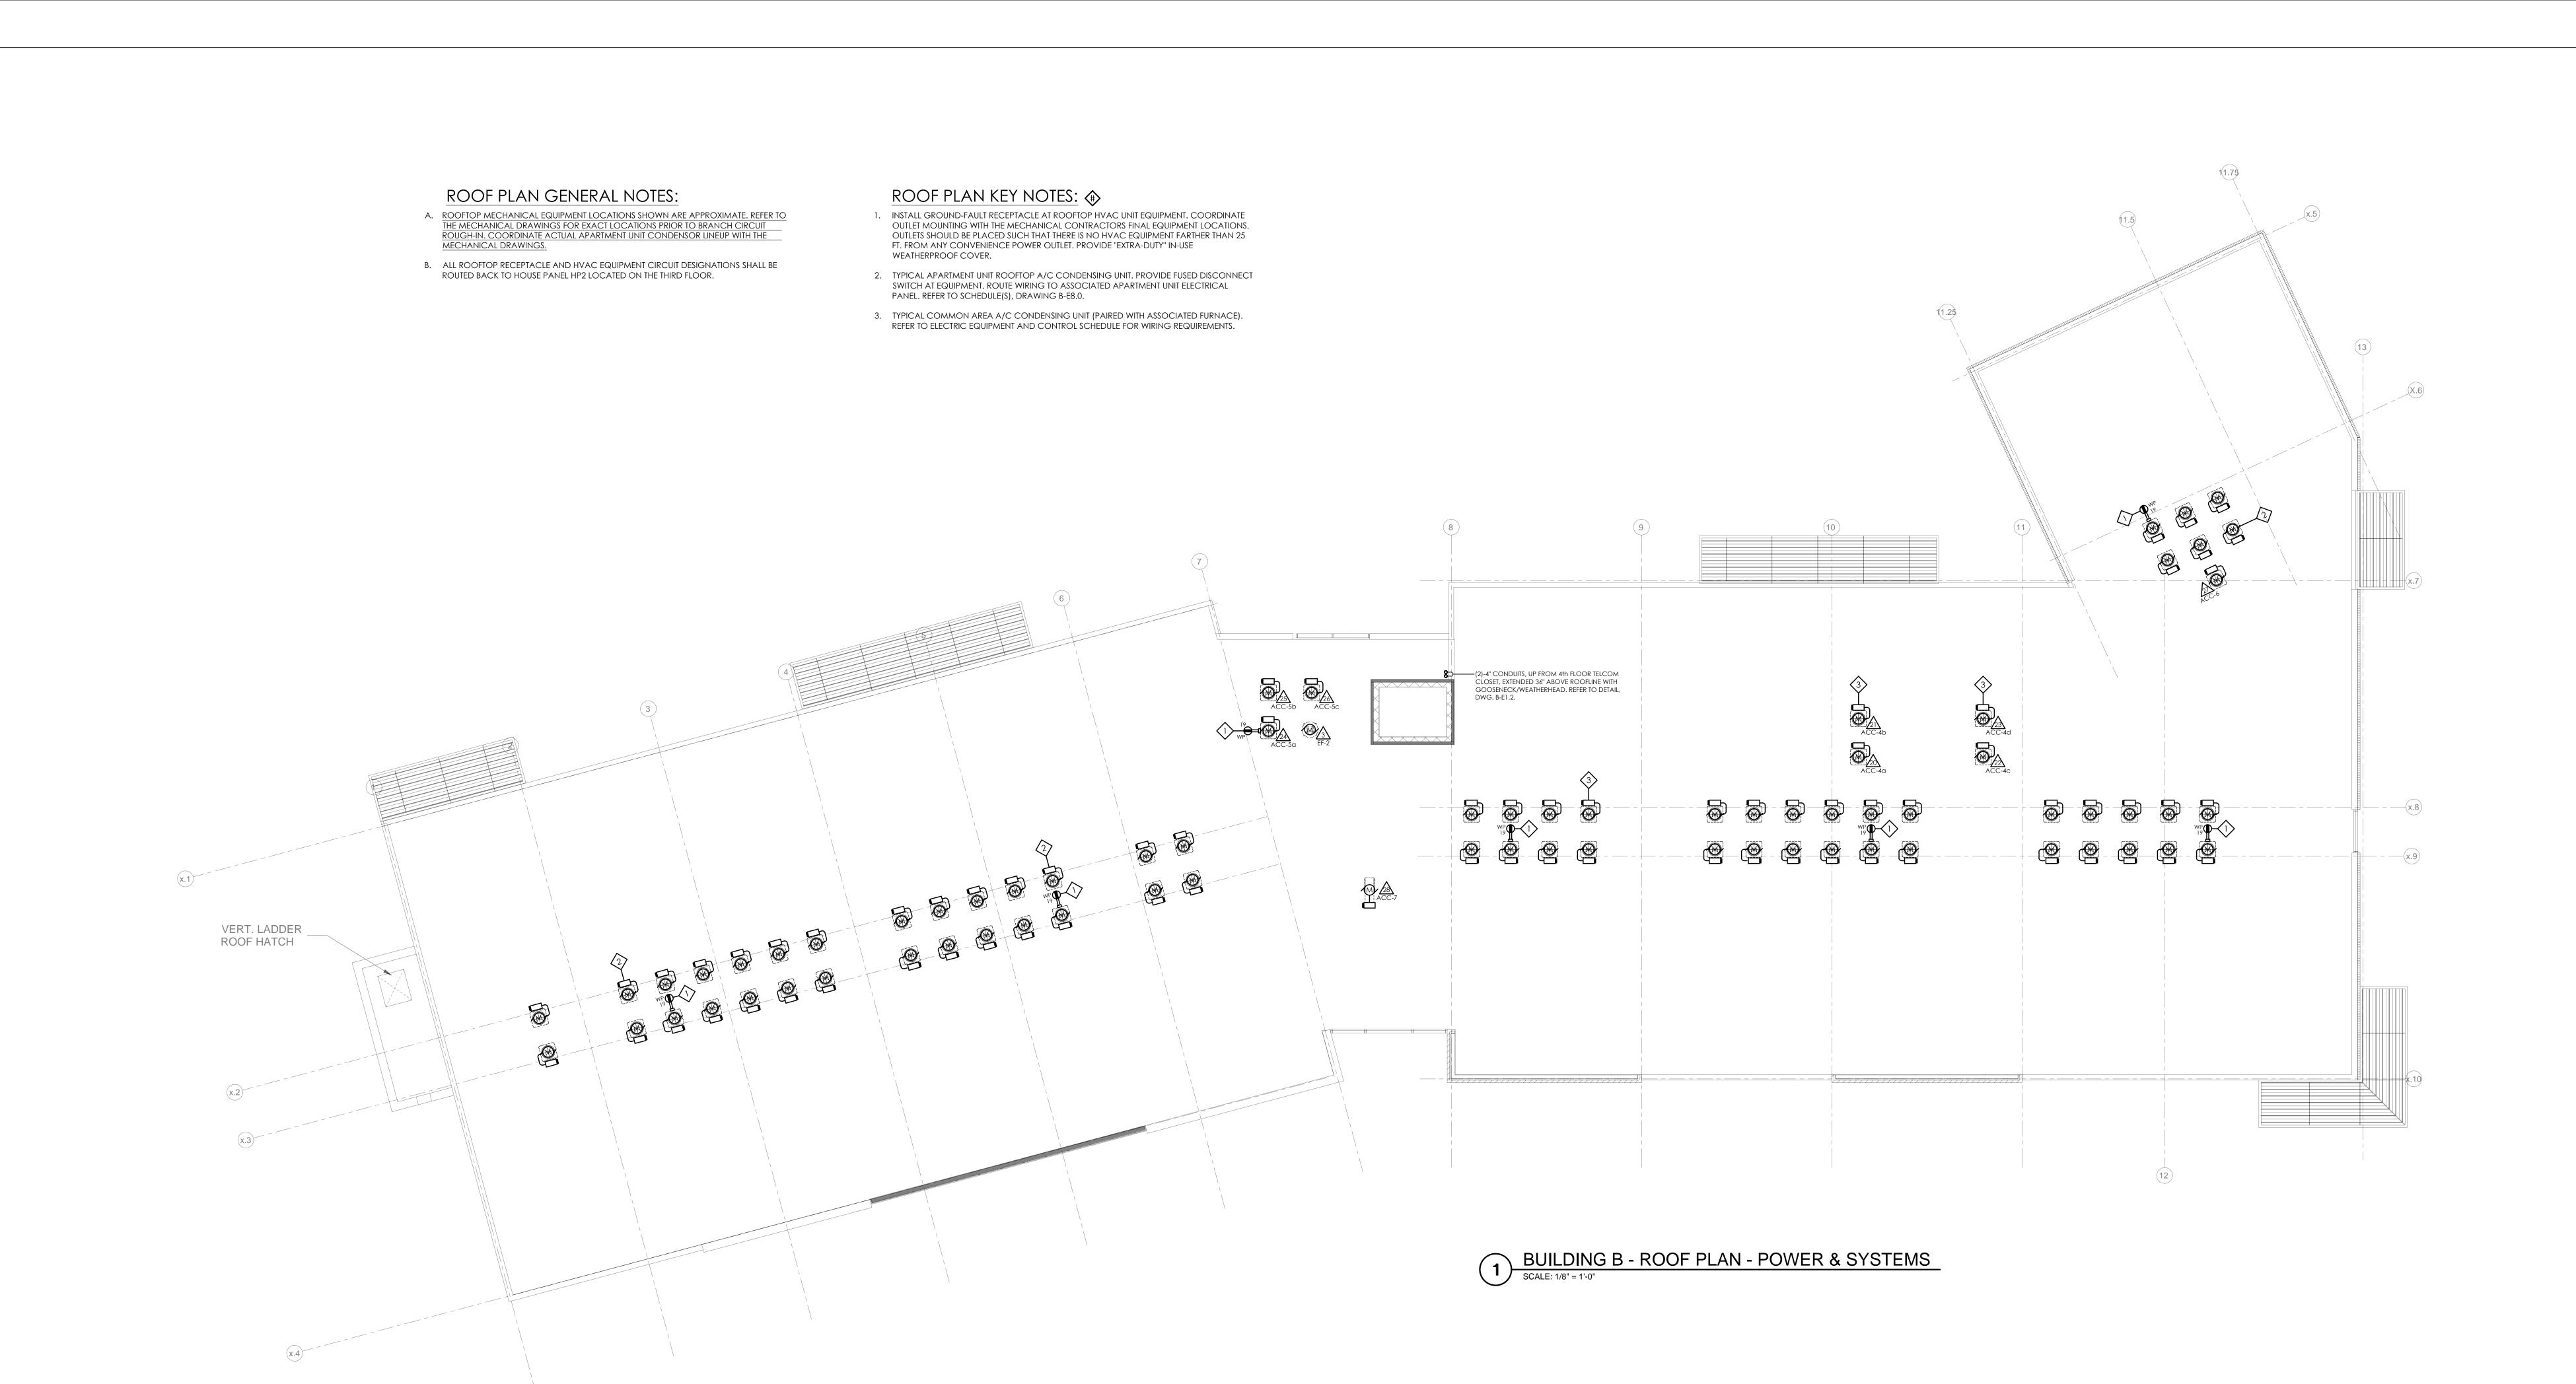




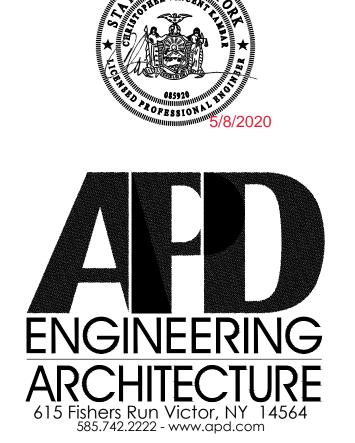





PERMIT SET

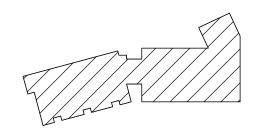

ADVENTURE PLA



VIDA - BUILDING B

30 ADVENTURE PLACE, ROCHESTER, NEW YORK 14607

REV.#	DESCRIPTION	DATE
JOB NO.		1709

JOB NO.		1709
SCALE		As Indicated
ISSUE DATE	Ξ	05/08/20
DRAWN BY		RAC
CHECKED E	BY	CVK
THIS IS A SINGLE SHEET OF A COHESIVE		

SET OF CONSTRUCTION DOCUMENTS
(INCLUDING DRAWINGS AND SPECIFICATIONS).
INTERPRETATION OF THE INFORMATION
AS PRESENTED SHOULD BE BASED ON
THE ENTIRE SET OF DOCUMENTS.

DRAWING TITLE

BLDG. B - ROOF PLAN - LIGHTING & POWER

B-E7.1