








PRELIMINARY/FINAL SITE PLANS for

302 INDEPENDENCE PLACE CONIFER REALTY, LLC

302 UNIVERSITY AVENUE

SITUATE IN:

CITY OF ROCHESTER - MONROE COUNTY - STATE OF NEW YORK

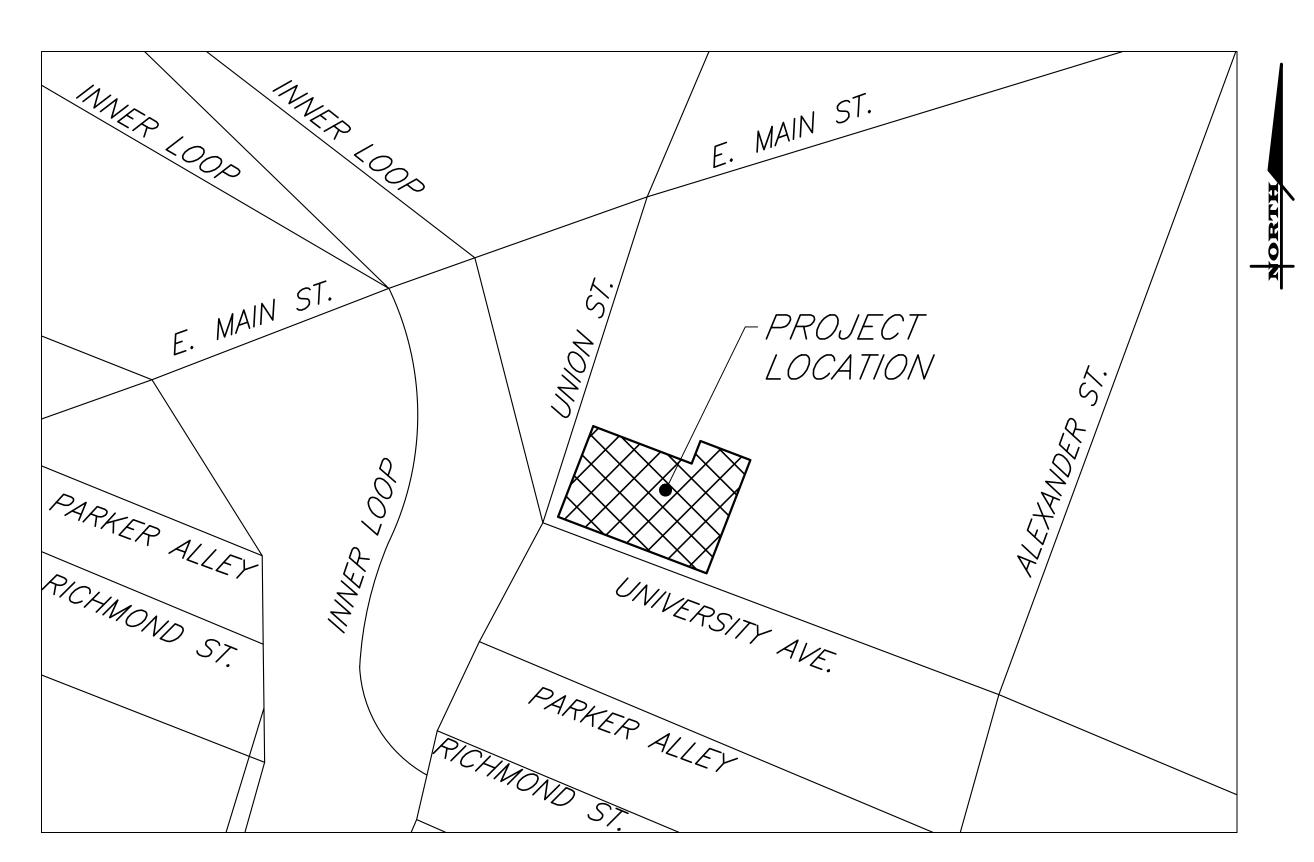

LOCATION MAP

NOT TO SCALE



ROCHESTER LOCATION

3 9 CASCADE DRIVE
ROCHESTER, NY 14614
5 8 5 - 4 5 8 - 7 7 7 0

ITHACA LOCATION

840 HANSHAW RD, STE 12
ITHACA, NY 14850
6 0 7 - 2 4 1 - 2 9 1 7

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		LIST OF DRAWINGS
No.	DWG. No.	Description
	COVER	
1	V1.0	EX. CONDITIONS AND DEMO PLAN
2	C1.0	SITE LAYOUT PLAN
3	C2.0	UTILITY PLAN
4	C3.0	GRADING AND EROSION CONTROL PLAN
5	C4.0	CONSTRUCTION DETAILS
6	C4.1	CONSTRUCTION DETAILS

NOTES

- 1. MAPPING THE EXISTING UNDERGROUND UTILITIES WERE PLOTTED BASED ON RECORD MAPPING SUPPLIED BY OTHERS. THE ENGINEER MAKES NO WARRANTY AS TO THE LOCATION, SIZE, TYPE, ELEVATION, AND/OR NUMBER OF EXISTING UTILITIES. THE CONTRACTOR SHALL BE RESPONSIBLE FOR DETERMINING THE HORIZONTAL AND VERTICAL LOCATION OF UTILITIES IN THE VICINITY OF THE NEW


 - SANITARY SEWERS WERE PLOTTED FROM RECORD MAPS RECEIVED FROM CITY OF ROCHESTER ON 03/25/2020 WATER SERVICES AND MAINS WERE PLOTTED FROM RECORD MAPS RECEIVED FROM RWB ON 03/25/2020
 - STORM SEWERS WERE PLOTTED FROM RECORD MAPS RECEIVED FROM CITY OF ROCHESTER ON 03/25/2020
 - UNDERGROUND GAS SERVICES AND MAINS WERE PLOTTED FROM RECORD MAPS RECEIVED FROM RG&E ON 03/25/2020 TEST PITS (P-1, P-2) WERE DUG ON 06/02/2020 BY MARATHON ENGINEERING TO CONFIRM GAS LINE LOCATION IN FIELD. • UNDERGROUND ELECTRIC LINES WERE PLOTTED FROM RECORD MAPS RECEIVED FROM RG&E ON 03/25/2020
- 2. STAKEOUT THE CONTRACTOR SHALL NOTIFY DIG SAFELY NEW YORK (1-800-962-7962) FOR A UTILITY STAKEOUT 48 HOURS IN ADVANCE OF COMMENCING WORK. STAKEOUT OF PRIVATE UTILITIES SHALL BE COORDINATED WITH THE OWNER.
- 3. BOUNDARY BOUNDARY INFORMATION WAS TAKEN FROM 'ALTA/NSPS LAND TITLE SURVEY #302-322 UNIVERSITY AVENUE' DATED 03/26/2020 AND IS SHOWN FOR GRAPHICAL REPRESENTATION ONLY.
- 4. DATUM THE VERTICAL DATUM WAS SET USING ELEVATION DATA TAKEN FROM A MAP TITLED 'ALTA/NSPS LAND TITLE SURVEY #302-322 UNIVERSITY AVENUE' DATED 03/26/2020. VERTICAL DATUM REFERENCES THE CITY OF ROCHESTER DATUM.
- 5. FLOODPLAIN THE PROPERTY IS LOCATED IN ZONE 'X' AND IS NOT LOCATED GRAPHICALLY IN THE FLOODPLAIN AS SHOWN ON COMMUNITY PANEL No 36055C 0211G, DATED 08/28/2008




TREE LINE

EXISTING DESCRIPTION LIGHT POLE POWER POLE GAS MAIN & VALVE ELECTRIC CONDUIT & STRUCTURE TELEPHONE CONDUIT & STRUCTURE CENTERLINE AND STATIONING PROPERTY LINE RIGHT-OF-WAY ——— × ——— FENCE (DESCRIPTION) ● 8"SA → SANITARY SEWER WITH MANHOLE O—8"ST→---□ STORM SEWER, MANHOLE & FIELD/DROP INLET WATER MAIN WITH HYDRANT & GATE VALVE CENTERLINE OF SWALE DRAINAGE FLOW ARROW SPOT ELEVATION

PARKING SPACE COUNT

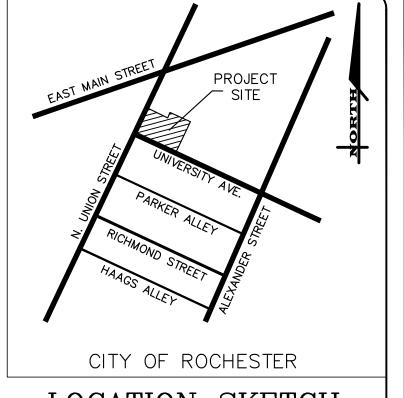

LOCATION SKETCH N.T.S.

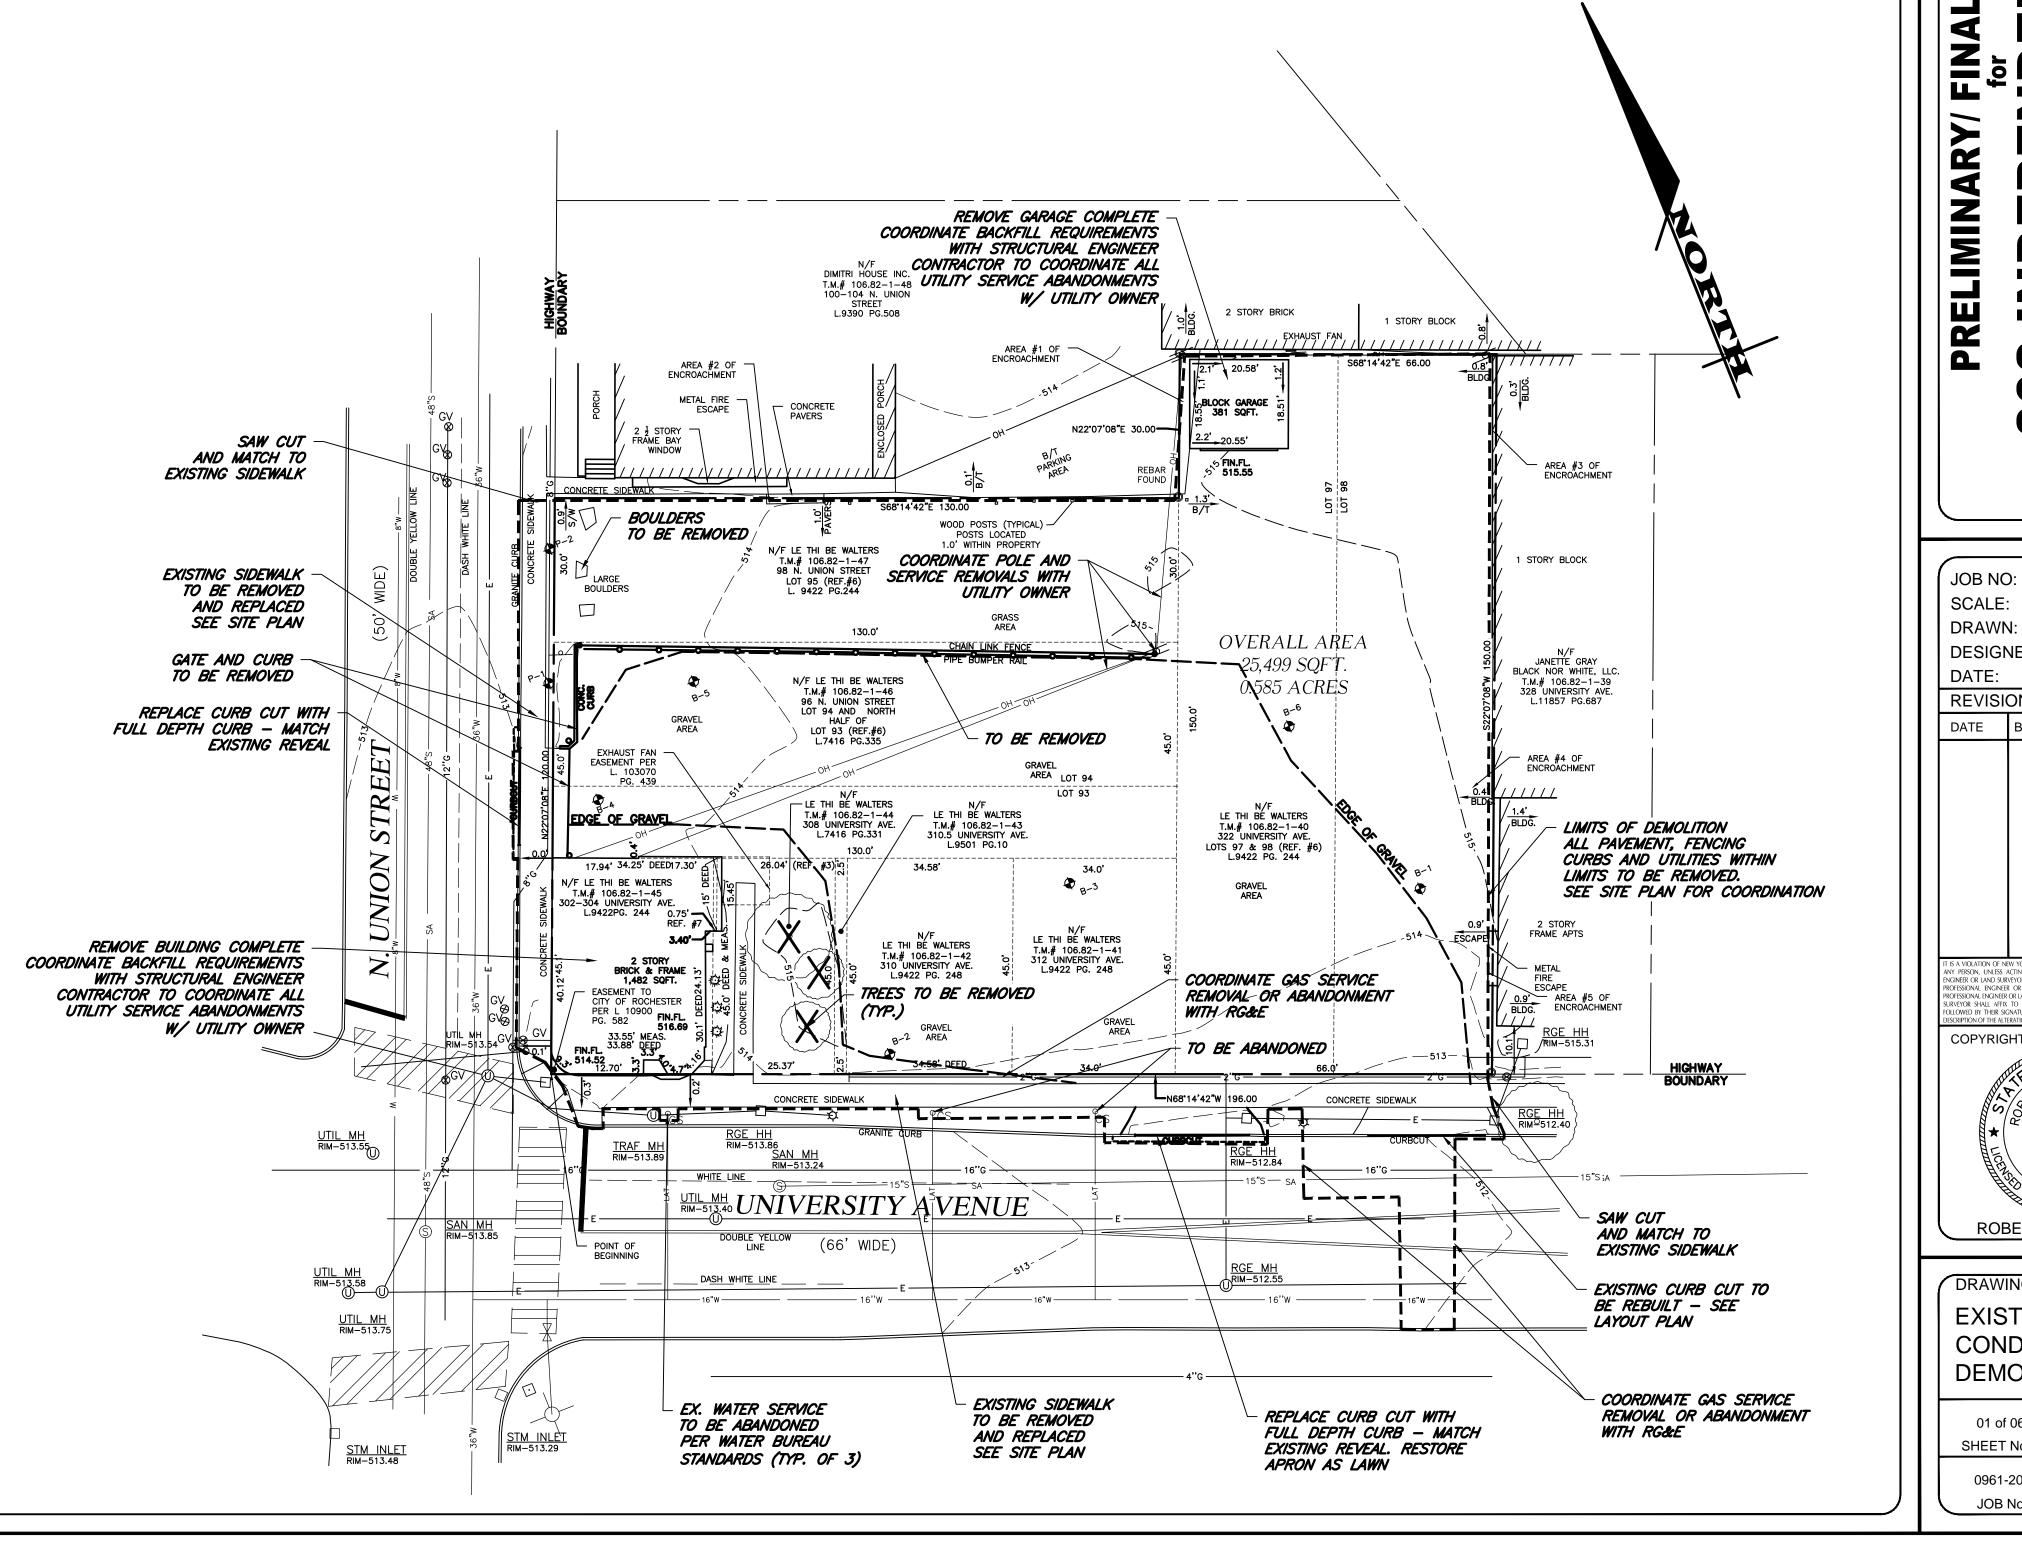



39 CASCADE DRIVE ROCHESTER, NY 14614 5 8 5 - 4 5 8 - 7 7 7 0 ITHACA LOCATION

840 HANSHAW RD, STE 12 ITHACA, NY 14850 6 0 7 - 2 4 1 - 2 9 1 7 www.marathoneng.com

0961-20

SCALE: 1"=20' DRAWN: RLB DESIGNED: MPT DATE: 07/15/2020 REVISIONS DATE BY REVISION COPYRIGHT©2020 MARATHON ENG. NO. 066924

DRAWING TITLE: **EXISTING** CONDITIONS AND **DEMOLITION PLAN**

ROBERT P. BRINGLEY

01 of 06 SHEET No: 0961-20 JOB No: DRAWING No:

- 1. APPLICABILITY THE NOTES AND INFORMATION PROVIDED ON THIS SHEET ARE APPLICABLE TO ALL "C" SERIES DRAWINGS. THE "C" SERIES DRAWINGS COVER SITE RELATED IMPROVEMENTS OUTSIDE THE BUILDING ENVELOPE. THE BUILDING ENVELOPE INCLUDES ALL AREA WITHIN 5' OUTSIDE OF THE BUILDING'S EXTERIOR WALL.
- 2. MAPPING THE EXISTING UNDERGROUND UTILITIES WERE PLOTTED BASED ON RECORD MAPPING SUPPLIED BY OTHERS. THE ENGINEER MAKES NO WARRANTY AS TO THE LOCATION, SIZE, TYPE, ELEVATION, AND/OR NUMBER OF EXISTING UTILITIES. THE CONTRACTOR SHALL BE RESPONSIBLE FOR DETERMINING THE HORIZONTAL AND VERTICAL LOCATION OF UTILITIES IN THE VICINITY OF THE NEW INFRASTRUCTURE.
- 3. STAKEOUT THE CONTRACTOR SHALL NOTIFY DIG SAFELY NEW YORK (1-800-962-7962) FOR A UTILITY STAKEOUT 48 HOURS IN ADVANCE OF COMMENCING WORK. STAKEOUT OF PRIVATE UTILITIES SHALL BE COORDINATED WITH THE
- 4. PROPERTY PROTECTION THE CONTRACTOR IS RESPONSIBLE FOR DAMAGE TO EXISTING PAVEMENT, CURBS, WALKS, LAWNS, TREES, ETC. CAUSED BY THEIR CONSTRUCTION OPERATIONS. ALL DAMAGE SHALL BE REPAIRED OR REPLACED BY THE CONTRACTOR TO THE OWNER'S SATISFACTION AT NO ADDITIONAL EXPENSE.
- 5. ACCESS THE CONTRACTOR SHALL PROVIDE SATISFACTORY VEHICULAR ACCESS TO ALL ADJOINING PROPERTIES, PRIVATE ROADWAYS, PARKING FACILITIES, AND PUBLIC STREETS DURING CONSTRUCTION.
- 6. SITE SAFETY PRIOR TO AND THROUGHOUT CONSTRUCTION, THE CONTRACTOR SHALL POST SIGNAGE IN CONFORMANCE WITH THE REQUIREMENTS OF THE LOCAL MUNICIPALITY AND OCCUPATIONAL HEALTH AND SAFETY ACT (OHSA). JOB SAFETY AND MAINTENANCE AND PROTECTION OF TRAFFIC IS THE RESPONSIBILITY OF THE CONTRACTOR.
- 7. EXCAVATIONS ALL EXCAVATIONS SHALL BE BACKFILLED/BARRICADED TO THE SATISFACTION OF THE OWNER'S REPRESENTATIVE AT THE CONCLUSION OF EACH WORKING DAY.
- 8. MAINTENANCE PUBLIC STREETS, PRIVATE DRIVES AND PARKING FACILITIES SHALL BE KEPT FREE OF FOREIGN MATERIALS. ALL AREAS SHALL BE SWEPT CLEAN AT THE END OF EACH WORKING DAY AND/OR AS DIRECTED BY THE OWNER'S ON-SITE REPRESENTATIVE.
- 9. CONSTRUCTION STORAGE STORAGE OF EQUIPMENT AND MATERIALS SHALL BE WITHIN A SPECIFIED AND SECURED AREA AS DETERMINED IN CONTRACT DOCUMENTS OR AS SPECIFIED BY THE OWNER'S ON-SITE
- 10. PERMIT(S) PRIOR TO CONSTRUCTION, THE CONTRACTOR SHALL OBTAIN THE NECESSARY PERMITS FROM THE APPLICABLE MUNICIPALITY OR AGENCY. THE CONTRACTOR IS RESPONSIBLE FOR ALL BONDS AND INSURANCES AND THE OWNER IS RESPONSIBLE FOR PERMIT FEES UNLESS OTHERWISE STATED IN THE OWNER/ CONTRACTOR AGREEMENT
- 11. INTERIM CONDITIONS THE CONTRACTOR IS RESPONSIBLE TO MAINTAIN POSITIVE DRAINAGE AWAY FROM BUILDINGS AND WITHIN PROJECT AREA TO A STABILIZED OUTLET THROUGHOUT THE CONSTRUCTION PERIOD. THIS MAY REQUIRE INTERIM GRADING, SHIMMING OF PAVEMENT ETC. THAT IS NOT SPECIFICALLY SHOWN ON THE PLANS AND SHALL BE THE RESPONSIBILITY OF THE CONTRACTOR.

CONSTRUCTION NOTES:

- STAKEOUT THE CONSTRUCTION STAKEOUT SHALL BE PERFORMED BY A LICENSED LAND SURVEYOR USING CONTROL PROVIDED ON THE "LAYOUT PLAN". THE BUILDING FOOTPRINT(S), DATED 06/19/20, WERE PROVIDED BY SWBR ARCHITECTS. DISCREPANCIES WITH BUILDING(S), CONTROL POINTS, AND/ OR TIE DIMENSIONS SHALL BE REPORTED TO THE DESIGN ENGINEER (PRIOR TO THE INSTALLATION OF IMPROVEMENTS) FOR COORDINATION AND CLARIFICATION.
- BOUNDARY BOUNDARY INFORMATION WAS TAKEN FROM PRE-CONSTRUCTION ALTA SURVEY PREPARED BY MAGDE LAND SURVEYING AND IS SHOWN FOR GRAPHICAL REPRESENTATION ONLY.
- 3. LAYOUT DIMENSIONS SHOWN, WHERE APPLICABLE, SHALL BE FROM THE FACE OF CURB UNLESS SPECIFICALLY CALLED OUT OTHERWISE.
- DEMOLITION CLEARING AND GRUBBING SHALL BE LIMITED TO THE SITE BOUNDARIES OR WITHIN THE "WORK LIMIT LINE" AS DEFINED ON THE PLAN. TREES AND OBJECTS DESIGNATED FOR REMOVAL SHALL BE COORDINATED AND FIELD VERIFIED WITH PROJECT ON-SITE REPRESENTATIVE. ALL MATERIALS SHALL BE LEGALLY DISPOSED OF OFF-SITE OR RETURNED TO OWNER AS DIRECTED BY CONTRACT DOCUMENTS. ALL ITEMS NOT SPECIFICALLY CALLED OUT TO BE REMOVED SHALL REMAIN.
- COORDINATION THE CONTRACTOR SHALL COORDINATE INSTALLATION OF UTILITY WORK WITH OTHER SITE UTILITIES (I.E. GAS, ELECTRIC, LIGHTING, COMMUNICATIONS) TO AVOID POTENTIAL INSTALLATION CONFLICTS.
- STAGING AS DEFINED BY THE CONTRACT DOCUMENTS THE CONTRACTOR SHALL CONSTRUCT A SECURE STAGING AREA FOR STORAGE OF EQUIPMENT, MATERIALS, EMPLOYEE PARKING AND OFFICE SPACE. IF THE AREA/METHOD IS NOT SPECIFICALLY DEFINED ON THE DOCUMENTS THEN IT SHALL BE COORDINATED WITH THE OWNER'S ON-SITE REPRESENTATIVE.
- 7. CLOSE-OUT THE CONTRACTOR'S WORK SCOPE INCLUDES BUT IS NOT LIMITED TO THE FOLLOWING AT PROJECT CLOSE-OUT TO THE SATISFACTION OF OWNER'S ON-SITE REPRESENTATIVE:
 - REMOVAL OF ANY CONSTRUCTION DEBRIS.
 - CLEANING PAVEMENT AND WALKWAY SURFACES.
 - RESTORATION OF ALL DISTURBED GRASS AND LANDSCAPED AREAS. • PROVIDING BONDS, GUARANTEES, CERTIFICATIONS, ETC. AS REQUIRED BY CONTRACT DOCUMENTS.
 - PROVIDING A RECORD DRAWING.

CITY OF ROCHESTER NOTES:

COMPLETION OF FINAL PUNCH LIST ITEMS.

- NEW CURB CUTS NEW CURB CUTS SHALL BE INSTALLED EITHER BY RESETTING EXISTING GRANITE CURB. EXISTING
- CURB JOINTS ARE TO BE REPOINTED WITH MASONRY MORTAR MIX. 2. ADA - ALL WORK IN THE RIGHT-OF-WAY ARE TO BE CONSTRUCTION IN ACORDANCE WITH THE 'AMERICANS WITH
- DISABILITIES ACT (ADA) AND THE 'PROPOSED GUIDELINES FOR PEDESTRIAN FACILITIES IN THE RIGHT-OF-WAY' (PROWAG) STREET TREES - STREET TREES IN THE WORK AREA SHALL BE PROTECTED WITH FENCING THROUGHOUT CONSTRUCTION. ANY DAMAGE TO THE EXISTING PLANTING BED MATERIAL IS TO REPAIRED OR REPLACED WITH NEW
- MATERIAL OF LIKE NATURE. COORDINATE WITH THE CITY FORESTER'S OFFICE. 4. CURB + SIDEWALK REPLACEMENT - CURBING SHALL BE RESET OR REPLACED IN FULL PIECES ONLY TO THE NEAREST JOINT. ANY CURB OR UNDERDRAIN DAMAGED DURING THE WORK SHALL BE FULLY REMOVED AND REPLACED.
- SIDEWALK SHALL BE REPLACED TO THE NEAREST CONTROL JOINT AND IN FULL FLAG SEGMENTS. PAVEMENTS- SHALL BE FULL DEPTH EXTENDING THROUGH THE BASE COURSE. RECYCLED MATERIALS ARE UNACCEPTABLE FOR BACKFILL OR SUBBASE COURSE MATERIALS.
- RIGHT-OF-WAY ALL WORK IN THE RIGHT-OF-WAY SHALL BE CONSTRUCTED IN ACCORDANCE WITH CITY OF ROCHESTER SPECIFICATIONS AND SHALL BE SECURED WITH A LETTER OF CREDIT WITH A 35% ADMINISTRATION COST

PROJECT STATISTICS

GENERAL:

1.1 PROPERTY OWNER -CONIFER REALTY, LLC

1000 UNIVERSITY AVENUE, SUITE 500 ROCHESTER NY 14607

1.2 PROPERTY ADDRESS - 96-98 N. UNION STREET 302-322 UNIVERSITY AVENUE CITY OF ROCHESTER

1.3 TAX ACCOUNT -106.82-1-40, 41, 42,43,44,45,46,47

1.4 PARCEL SIZE -0.585 Acres (TOTAL)

2. ZONING REGULATIONS:

2.1 ZONING DISTRICT - CCD-M - CENTER CITY - MAIN STREET DISTRICT (ARTICLE IX - SECTION 120-68)

2.2 CODE REQUIREMENTS -PROVIDED REQUIRED FRONT SETBACK 4' (UNION) - 1' (UNIVERSITY)* SIDE SETBACK - PARKING -BUILDING **BUILDING HEIGHT** 3 STORY MIN, 15 MAX 4 STORIES 19 SPACES


2 @ 11'

VEHICULAR ENTRANCES 2.3 MAJOR DEVIATION WAIVERS * -

1. SETBACK DICTATED BY SEPARATION TO GAS MAIN PER RG&E 2. 40% OF PARKING REQUIRED TO BE SHADED BY TREES AT FULL GROWTH

3. PARKING MUST HAVE PEDESTRIAN ACCESS TO STREET

4. SEE APPLICATION FOR FULL LIST OF WAIVERS

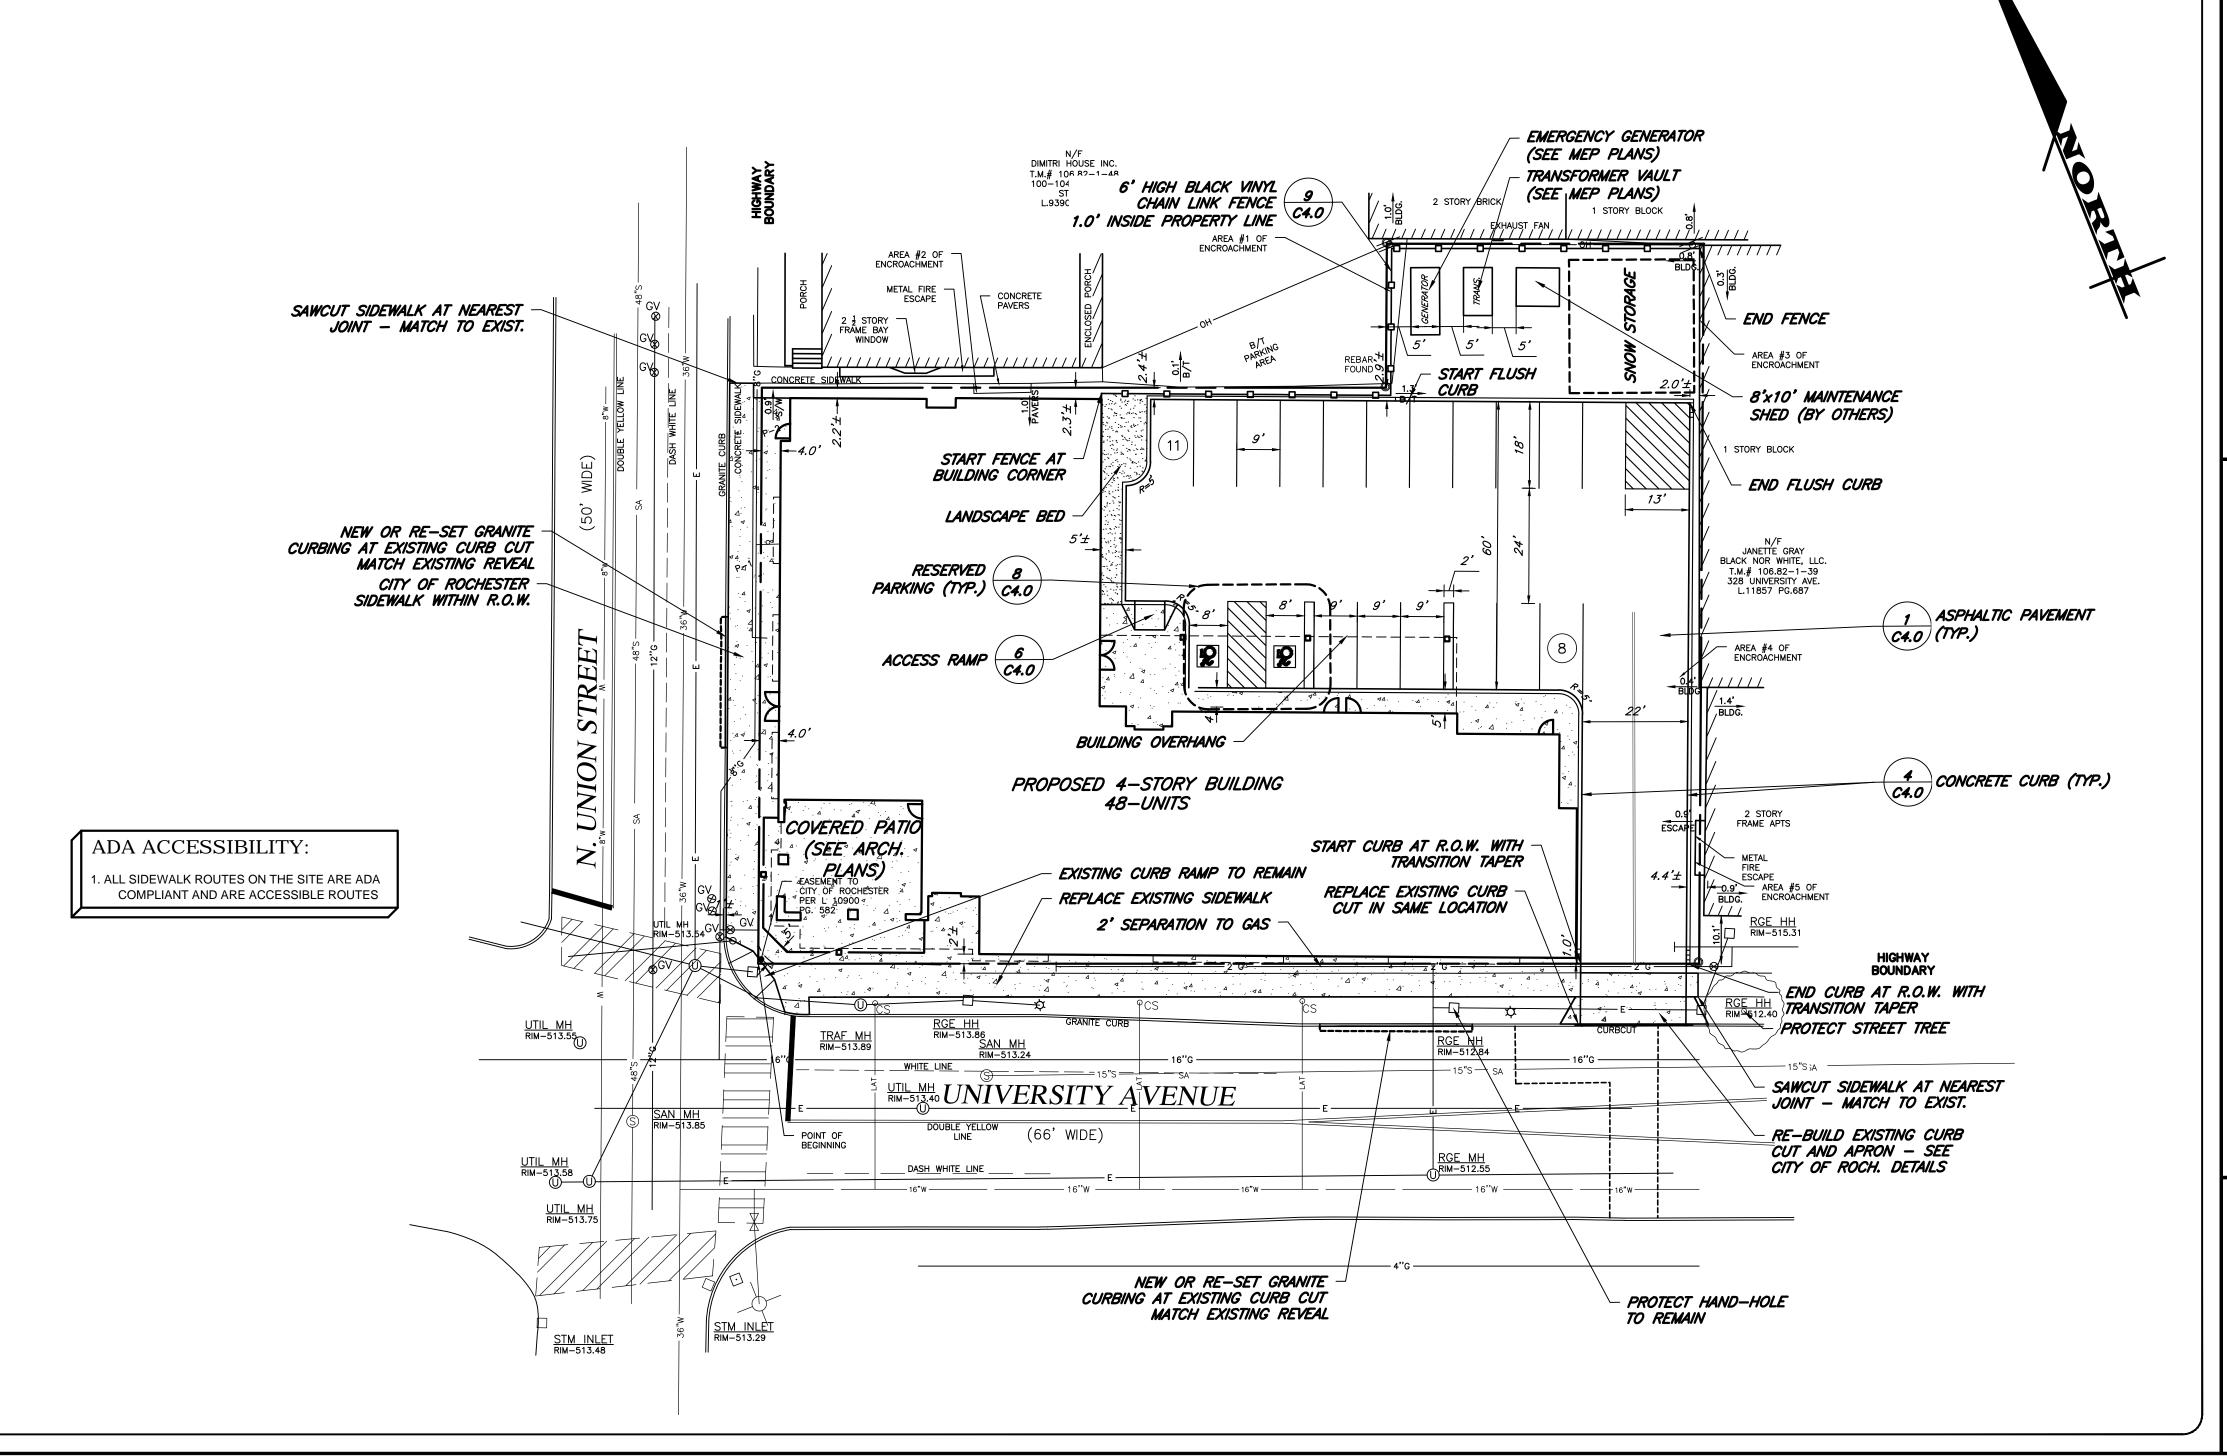

ENGINEERING

39 CASCADE DRIVE ROCHESTER, NY 14614 5 8 5 - 4 5 8 - 7 7 7 0 ITHACA LOCATION

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JOB NO: 0961-20 SCALE: 1"=20' DRAWN: MPT MPT DESIGNED: DATE: 07/28/2020 REVISIONS DATE BY REVISION IONAL ENGINEER OR LAND SURVEYOR. IF AN ITEM BEARING THE SEAL COPYRIGHT© 2020 MARATHON ENG.

ROBERT P. BRINGLEY DRAWING TITLE: LAYOUT PLAN 2 of 6 SHEET No: 0961-20 DRAWING No: JOB No:

- MAINS PIPING SHALL BE POLYVINYL CHLORIDE (PVC) WITH ENDS SUITABLE FOR ELASTOMERIC GASKET JOINTS, AND A MINIMUM WALL THICKNESS OF SDR-35. PIPING AND FITTINGS SHALL MEET:
- ASTM D-3034 (4" THRU 15")
 ASTM F-679 (18" THRU 48")
- LATERALS PIPING SHALL BE POLYVINYL CHLORIDE (PVC) WITH ENDS SUITABLE FOR ELASTOMERIC GASKET JOINTS, AND A MINIMUM WALL THICKNESS OF
- SDR-21. PIPING AND FITTINGS SHALL MEET ASTM D-2241.

 JOINTING MATERIALS SHALL BE BELL-AND-SPIGOT WITH INTEGRAL PUSH ON TYPE ELASTOMERIC GASKET JOINTS, GASKET MATERIAL TO BE NEOPRENE
- MEETING ASTM D-3212.

 MANHOLES SHALL BE PRECAST CONCRETE WITH NEOPRENE GASKETS MEETING ASTM C-478 & ASTM C-443.

SANITARY SEWER MUST COMPLY WITH THE EFFLUENT LIMITS OF THE LOCAL AND/OR THE MONROE COUNTY SEWER USE LAW.

- 1.2 INFILTRATION/ EXFILTRATION MAXIMUM ALLOWABLE INFILTRATION OR EXFILTRATION SHALL NOT EXCEED 100 GALLONS PER INCH DIAMETER PER MILE OF PIPE PER DAY FOR THE SANITARY SEWER. IF AN AIR TEST IS USED, THE TEST AS A MINIMUM SHALL CONFORM TO THE PROCEDURE DESCRIBED IN ASTM DESIGNATION C828-86 ENTITLED PRACTICE FOR LOW PRESSURE AIR TEST OF VITRIFIED CLAY PIPE LINES. SANITARY MANHOLES SHALL BE VISUALLY INSPECTED AND TESTED FOR LEAKAGE BY EX FILTRATION OR VACUUM. VACUUM TESTING OF MANHOLES SHALL COMPLY WITH THE METHOD OUTLINED IN THE NEW YORK STATE DEPARTMENT OF ENVIRONMENTAL CONSERVATION TECHNICAL INFORMATION PAMPHLET (TIP) NO. 15 (REVISED).
- STATE DEPARTMENT OF ENVIRONMENTAL CONSERVATION TECHNICAL INFORMATION PAMPHLET (TIP) NO. 15 (REVISED).

 1.3 FLOOR DRAINS FLOOR DRAINS, IF CONSTRUCTED IN THE PROJECT. MUST BE CONNECTED TO THE SANITARY SEWER. NOTE: FLOOR DRAINS DO NOT INCLUDE FOUNDATION OR FOOTER DRAINS INSTALLED TO INTERCEPT UNCONTAMINATED GROUND WATER. ALL DISCHARGES FROM THE FLOOR DRAINS TO THE
- 1.4 TESTING DEFLECTION TESTS SHALL BE PERFORMED ON ALL FLEXIBLE PIPE. THE TEST SHALL BE CONDUCTED AFTER THE FINAL BACKFILL HAS BEEN IN PLACE AT LEAST 30 DAYS. NO PIPE SHALL EXCEED A DEFLECTION OF 5%. IF THE DEFLECTION TEST IS TO BE RUN USING A RIGID BALL OR MANDREL. IT SHALL HAVE A DIAMETER EQUAL TO 95% OF THE INSIDE DIAMETER OF THE PIPE. THE TEST SHALL BE PERFORMED WITHOUT MECHANICAL PULLING DEVICES.
- 1.5 SEPARATION MINIMUM VERTICAL SEPARATION BETWEEN WATER MAINS AND SEWER LINES SHALL BE 18 INCHES MEASURED FROM THE OUTSIDE OF THE PIPES AT THE POINT OF CROSSING. ONE FULL STANDARD LAYING LENGTH OF WATER MAIN SHALL BE CENTERED UNDER OR OVER THE SEWER SO THAT BOTH JOINTS WILL BE AS FAR FROM THE SEWER AS POSSIBLE. IN ADDITION. WHEN THE WATER MAIN PASSES UNDER A SEWER, ADEQUATE STRUCTURAL SUPPORT (COMPACTED SELECTED FILL) SHALL BE PROVIDED FOR THE SEWER TO PREVENT EXCESSIVE DEFLECTION OF JOINTS AND SETTLING OF THE SEWER ON THE WATER MAIN. MINIMUM HORIZONTAL SEPARATION BETWEEN PARALLEL WATER MAINS AND SEWER PIPES (INCLUDING MANHOLES AND VAULTS) SHALL BE 10 FEET MEASURED FROM THE OUTSIDE OF THE PIPES. MANHOLES OR VAULTS.
- 2. STORM
- 2.1 REGULATIONS STORM SEWERS AND APPURTENANCES SHALL BE CONSTRUCTED IN CONFORMANCE WITH THE LATEST REGULATIONS OF THE MUNICIPALITY.
- 2.2 MATERIALS THE CONTRACTOR MAY USE THE FOLLOWING PIPE MATERIAL FOR THE MAIN SEWER AS ALLOWED BY THE MUNICIPALITY, PROVIDING THAT THE ROUGHNESS COEFFICIENT ("N" FACTOR) IS 0.013 OR BETTER:
 - REINFORCED CONCRETE PIPE (RCP), CLASS III
 - CORRUGATED STEEL PIPE (CSP), 16 GAUGE
 HIGH DENSITY CORRUGATED POLYETHYLENE PIPE (PE), AASHTO M-29, TYPE S, ASTM D-3350.
- 2.3 ROOF DRAINAGE ALL ROOF DRAINAGE SHALL BE COLLECTED AND PIPED TO THE STORM SEWER SYSTEM UNLESS SPECIFIED OTHERWISE.
- 2.4 TESTING UPON COMPLETION OF SYSTEM INSTALLATION, THE MAIN SEWER SYSTEM AND LEADS TO STRUCTURES SHALL BE FLUSHED AND LAMPED TO THE SATISFACTION OF THE MUNICIPALITY.

3. WATER

3.1 MCDPH STANDARD WATER MAIN EXTENSION NOTES

3.1.1 THE WATER MAIN AND TEMPORARY BYPASS PIPE SHALL BE DISINFECTED EQUAL TO AWWA STANDARD FOR DISINFECTING WATER MAINS, DESIGNATION C651, BY USING THE CONTINUOUS FEED METHOD. FOLLOWING DISINFECTION, THE WATER MAIN AND BYPASS PIPE SHALL BE FLUSHED UNTIL THE CHLORINE CONCENTRATION IN THE WATER LEAVING THE MAIN IS NO HIGHER THAN THAT GENERALLY PREVAILING IN THE SYSTEM. THE INTERIOR OF ALL WATER MAIN PIPE, VALVES, FITTINGS AND SERVICES FOUR (4) INCHES AND LARGER, INCLUDING NEW HYDRANT BRANCHES CONNECTED TO EXISTING WATER MAINS, NOT RECEIVING 24-HOUR CHLORINE DISINFECTION CONTACT TIME MUST BE SPRAY OR SWAB DISINFECTED WITH A MINIMUM 1% - 5% SOLUTION OF CHLORINE NO MORE THAN 30-MINITES PRIOR TO INSTALLATION. ADDITIONALLY, THE EXTERIOR SURFACES OF EXISTING PIPE AND FITTINGS THAT NEW PIPE AND FITTINGS WILL BE CONNECTED TO MUST BE THOROUGHLY CLEANED AND DISINFECTED. THE MAXIMUM DISTANCE BETWEEN DISINFECTION/SAMPLING TAPS ON NEW WATER MAIN AND BYPASS PIPE SHALL BE 1,000 FEET. THE SAMPLING POINT(S) MUST BE DECONTAMINATED BY FLAMING. FIRE HYDRANTS ARE NOT ACCEPTABLE SAMPLING POINTS. THE MONROE COUNTY DEPARTMENT OF PUBLIC HEALTH (MCDPH) MUST RECEIVE AT LEAST 48-HOUR ADVANCE NOTIFICATION REQUESTING SAMPLING SERVICES. THE CONTRACTOR SHALL CALL 585-753-5057 TO ARRANGE FOR SAMPLING SERVICES AND IS RESPONSIBLE FOR PAYING ALL MCDPH SAMPLING FEES. SAMPLING WILL NOT BE PERFORMED PRIOR TO RECEIPT FROM A NEW YORK STATE LICENSED OR REGISTERED DESIGN PROFESSIONAL (ENGINEER, ARCHITECT OR LAND SURVEYOR WITH A SPECIAL EXEMPTION UNDER SECTION 7208(N) OF THE EDUCATION LAW) CERTIFYING THAT THE WATER SUPPLY IMPROVEMENTS, TESTING AND DISINFECTION PROCEDURES WERE COMPLETED IN ACCORDANCE WITH THE APPROVED PLANS, REPORTS, SPECIFICATIONS AND ANY APPROVED AMENDMENTS. THE DEPARTMENT WILL COLLECT SAMPLES FOR FREE CHLORINE RESIDUAL, TOTAL COLIFORM, ESCHERICHIA COLI (E. COLI) AND TURBIDITY. THE WATER MAIN AND BYPASS PIPE SHALL NOT BE PLACED INTO SERVICE UNTIL SO AUTHORIZED BY THE MCDPH.

UNLESS OTHERWISE NOTED OR SHOWN ON THE APPROVED PLANS, THE MINIMUM VERTICAL SEPARATION BETWEEN WATER MAINS AND SEWER PIPE LINES SHALL BE 18-INCHES MEASURED FROM THE OUTSIDE OF THE PIPES AT THE POINT OF CROSSING. ONE FULL STANDARD LAYING LENGTH OF WATER MAIN SHALL BE CENTERED UNDER OR OVER THE SEWER SO THAT BOTH JOINTS WILL BE AS FAR FROM THE SEWER AS POSSIBLE. IN ADDITION, WHEN THE WATER MAIN PASSES UNDER A SEWER, ADEQUATE STRUCTURAL SUPPORT (COMPACTED SELECTED FILL) SHALL BE PROVIDED FOR THE SEWER TO PREVENT EXCESSIVE DEFLECTION OF JOINTS AND SETTLING OF THE SEWER ON THE WATER MAIN. UNLESS OTHERWISE NOTED OR SHOWN ON THE APPROVED PLANS, THE MINIMUM HORIZONTAL SEPARATION BETWEEN PARALLEL WATER MAINS AND SEWER PIPES (INCLUDING MANHOLES AND VAULTS) SHALL BE 10-FEET MEASURED FROM THE OUTSIDE OF THE PIPES,

- MANHOLES OR VAULTS.

 3.1.3 WHEN INSTALLING FIRE HYDRANTS, SHOULD GROUND WATER BE ENCOUNTERED WITHIN SEVEN (7) FEET OF FINISHED GRADE, FIRE HYDRANT WEEP HOLES (DRAINS) SHALL BE PLUGGED.
- 3.1.4 THE NEW WATER MAIN SHALL BE PRESSURE/LEAKAGE TESTED IN ACCORDANCE WITH THE MINIMUM REQUIREMENTS OF THE AWWA STANDARD C600 (LATEST REVISION) OR IN ACCORDANCE WITH MORE STRINGENT REQUIREMENTS IMPOSED BY THE SUPPLIER OF WATER. FOR CITY OF ROCHESTER WATER MAINS, PRESSURE/LEAKAGE TESTING SHALL BE PERFORMED IN ACCORDANCE WITH SUBSECTION 3.05 OF CITY OF ROCHESTER WATER BUREAU SPECIFICATION S900 -
- 3.2 RWB WATER MAIN AND SERVICE NOTES
- 3.2.1 WATER MAINS AND APPURTENANCES TO BE CONSTRUCTED IN ACCORDANCE WITH THE REGULATIONS AND SPECIFICATIONS OF THE ROCHESTER WATER BUREAU.
 ALL PIPE PRODUCTS, FITTINGS AND ACCESSORIES SHALL CONFORM TO THE LATEST ROCHESTER WATER BUREAU (RWB) APPROVED PRODUCTS LIST WHICH CAN BE FOUND ON THE CITY WEB SITE: HTTP://WWW.CITYOFROCHESTER.GOV/WATERDOCUMENTS/.

3.2.2 ALL NEW WATER MAINS SHALL BE INSTALLED WITH A MINIMUM COVER DEPTH FROM PROPOSED FINISHED GRADE OF 4.5 FEET FOR DOMESTIC MAINS AND 5.0 FEET FOR

- HOLLY MAINS.

 3.2.3 THE ROCHESTER WATER BUREAU REQUIRES THAT A HYDRANT USE PERMIT BE OBTAINED BY THE CONTRACTOR PRIOR TO USING ANY HYDRANT AS A SOURCE OF
- 3.2.3 THE ROCHESTER WATER BUREAU REQUIRES THAT A HYDRANT USE PERMIT BE OBTAINED BY THE CONTRACTOR PRIOR TO USING ANY HYDRANT AS A SOURCE OF WATER SUPPLY. THE PERMIT REQUIRES THE USE OF A WATER METER AND A BACKFLOW PREVENTER. THE WATER BUREAU WILL SUPPLY A WATER METER AND BACKFLOW PREVENTER WITH THE PERMIT. THE PERMIT FEE INCLUDES A REFUNDABLE DEPOSIT FOR THE USE OF THE WATER METER AND BACKFLOW PREVENTER.

 3.2.4 FOR EXISTING VALVES AND CURB STOPS THAT ARE LOCATED ON WATER MAINS AND WATER SERVICES WHICH ARE TO BE RETAINED, THE EXISTING VALVE AND CURB
- BOXES SHALL BE ADJUSTED TO GRADE OR REPLACED AS SHOWN ON THE PLANS OR DIRECTED BY THE PROJECT MANAGER.

 3.2.5 FOR ALL ABANDONED WATER MAIN AND HYDRANT BRANCHES, THE CONTRACTOR SHALL PLUG ALL CUT AND OPEN ENDS WITH 12-INCHES OF CONCRETE. THE
- CONTRACTOR SHALL LEAVE ABANDONED MAIN LINE, HYDRANT BRANCH AND SERVICE VALVES IN THE CLOSED POSITION.

 3.2.6 THE CONTRACTOR SHALL EXERCISE CAUTION WHEN WORKING NEAR WATER MAINS WHICH ARE TO BE RETAINED. NO VIBRATORY EQUIPMENT IS TO BE USED OVER OR ADJACENT TO EXISTING WATER MAINS.
- 3.2.7 APPROPRIATE MEASURES SHALL BE TAKEN TO PREVENT DIRT, DEBRIS, SURFACE AND GROUND WATER FROM CONTAMINATING THE WATER MAIN. THE WATER LEVEL IN THE EXCAVATION AT OPEN PIPE ENDS SHALL NEVER BE LESS THAN 12 INCHES BELOW THE INVERT OF THE WATER MAIN. WHENEVER AN OPEN PIPE END IS LEFT
- UNATTENDED, IT SHALL BE COVERED IN A WATER TIGHT MANNER.

 3.2.8 ALL GATE VALVES REQUIRE MECHANICAL JOINT RESTRAINT WITHIN 18-FEET OF THE VALVE.
- 3.2.9 ALL NEW DUCTILE IRON WATER MAIN SHALL BE INSTALLED WITH POLYETHYLENE ENCASEMENT AND MAGNESIUM ANODES FOR CATHODIC PROTECTION.
 3.2.10 ALL SERVICE TAPS ON PVC/PVCO WATER MAIN REQUIRE SERVICE SADDLES.
- 3.2.10 ALL SERVICE TAPS ON PVC/PVCO WATER MAIN REQUIRE SERVICE SADDLES.3.2.11 STAINLESS STEEL INSERTS ARE REQUIRED ON ALL POLYETHYLENE (PE) SERVICE FITTINGS.
- 3.2.12 TRACER WIRE IS REQUIRED ON ALL BURIED NON-METALLIC WATER MAINS AND WATER SERVICES.
 3.2.13 A PRECONSTRUCTION MEETING IS REQUIRED WITH THE ROCHESTER WATER BUREAU AFTER THE ISSUING OF A PERMIT, BUT BEFORE CONSTRUCTION OF THE WATER MAIN OR SERVICE BEGIN. CONTACT THE ROCHESTER WATER BUREAU AT (585) 428-7500 AND REQUEST TO SPEAK TO WATER ENGINEERING TO SCHEDULE THE MEETING.

ROCHESTER PURE WATERS DISTRICT

CITY OF ROCHESTER WATER BUREAU

PPROVED OILY FOR WATER FACILITY WORK SHOWN WITHIN THE PUBLIC
IGHT-OF-WAY, UP TO AND INCLUDING THE CURB VALVE, AND INCLUDING THE
VATER METER VALUT NEAR THE RIGHT-OF-WAY, IF APPLICABLE. THE OWNER,
EVEL OPER OR THEIR PILUMBER IS RESPONSIBLE FOR ACQUIRING ALL NECESSA

IF A BACKFLOW PREVENTION DEVICE IS REQUIRED, THE WATER BUREAU WILL NOT ISSUE A WATER SERVICE PERMIT UNTIL THE PLANS FOR THE BACKFLOW PREVENTION DEVICE HAVE BEEN APPROVED BY THE MONROE COUNTY

BACKFLOW DEVICE REQUIRED BACKFLOW DEVICE NOT REQUIRED

MITS FROM THE CITY BEFORE BEGINNING ANY WORK.

PARTMENT OF PUBLIC HEALTH

MCPW - Rochester Pure Waters District Sewer Notes:

- MCPW Rochester Pure Waters District Sewer Notes:

 1. This plan requires approval and issuance of a plumbing permit from the CITY OF ROCHESTER PLUMBING DEPARTMENT.
- 2. Prior to construction, a SEWER CONNECTION PERMIT must be obtained from the Monroe County Pure Waters (MCPW) Permit Office at 145 Paul Road, Building 11, Rochester. New York 14624, phone # 753-7600 (opt. 5).
- SEWER CONNECTION PERMIT(S) can only be issued to a plumber licensed in the City of Rochester and who is fully insured and bonded in the Rochester Pure Waters District (RPWD). Payment (check or money order to "RPWD") of all applicable permit fees must be paid prior to permit issuance.
 The RPWD shall be notified forty-eight hours in advance of a connection or tap. [753-7600 (opt. 5)]. The Contractor shall make all required
- taps to the RPWD sewers. All taps and connections to District utilities must be witnessed by a District Inspector.

 5. Sanitary/Storm/Combination sewer lateral(s) and appurtenances shall be constructed in conformance with the *Requirements of the Rochester Pure Waters District*.
- 6. Cleanouts shall be installed on all 4" and 6" diameter sewer laterals at the Right-Of-Way (ROW) line, or the sewer easement line where applicable. (The sewer easement, right-of-way and/or property line must be staked out prior to installation of lot line cleanouts to ensure proper location of the cleanouts. [refer to cleanout detail for proper installation]).7. If an existing lateral is to be utilized, the plumber/contractor must ensure that the lateral is in good condition and is free of debris (dirt, mud, stone, roots, etc.) via a video taped inspection performed by the plumber/contractor or his/her/their agent. Prior to connection, the video taped
- inspection of the existing lateral must be presented to the District for review and approval to utilize an existing lateral. It is the responsibility of the builder or their agent to clean and/or replace the pipe/lateral as needed.
- 8. Any new portion of a sewer lateral installed within the public Right-of-Way and sewer easement must be SDR-21 PVC.9. Any existing laterals not utilized must be abandoned to Monroe County Pure Waters (MCPW) standards at the property line or, where applicable, the sewer easement line.
- 10. Floor drains if constructed, shall be connected to the sanitary/combination sewer. Floor drains do not include foundation/footer drains. Note:

 All discharges to the sanitary/combination sewer must comply with the effluent limits of the local and/or Monroe County Sewer Use Law.

 11. Any portion of a sewer/lateral with less than four-feet (4') of cover will require concrete encasement. Sewers/Laterals with less than three-feet (3') of cover are not allowed.
- 12. The requirements of the highway/property owner shall be adhered to for items above the pipe bedding, including, but not limited to, maintenance and protection of traffic, backfill material and surface restoration.

 U + U (0961) LUMINAIRE SCHEDULE

 TYP SYMBOL DESCRIPTION
 MOUNTING/BALLAST

 PK4 合 (1) "PK-4" GLEON-AF-04-LED-E1-T4W
 16' Square 2' Conc. Reveal 18' Total Height

UTILITIES ELEVATED UPON EXCAVATION OF THE TRENCHES AND CONFLICTS

IMMEDIATELY REPORTED TO THE DESIGN ENGINEER FOR CLARIFICATION.

1. ALL PROPOSED LATERALS SHALL HAVE CROSSINGS WITH EXISTING

2. MINIMUM SEPARATIONS SHALL BE 12" VERTICAL FOR ALL UTILITY

Monroe County Department of Public Health


These plans for Public Water System Extension /
Improvement are hereby approved pursuant to
10NYCRR5 of the State Sanitary Code subject to
conditions of Approval

Director of Public Health

By Public Health Engineer Date

CROSSINGS UNLESS NOTED OTHERWISE

SPECIAL NOTES:

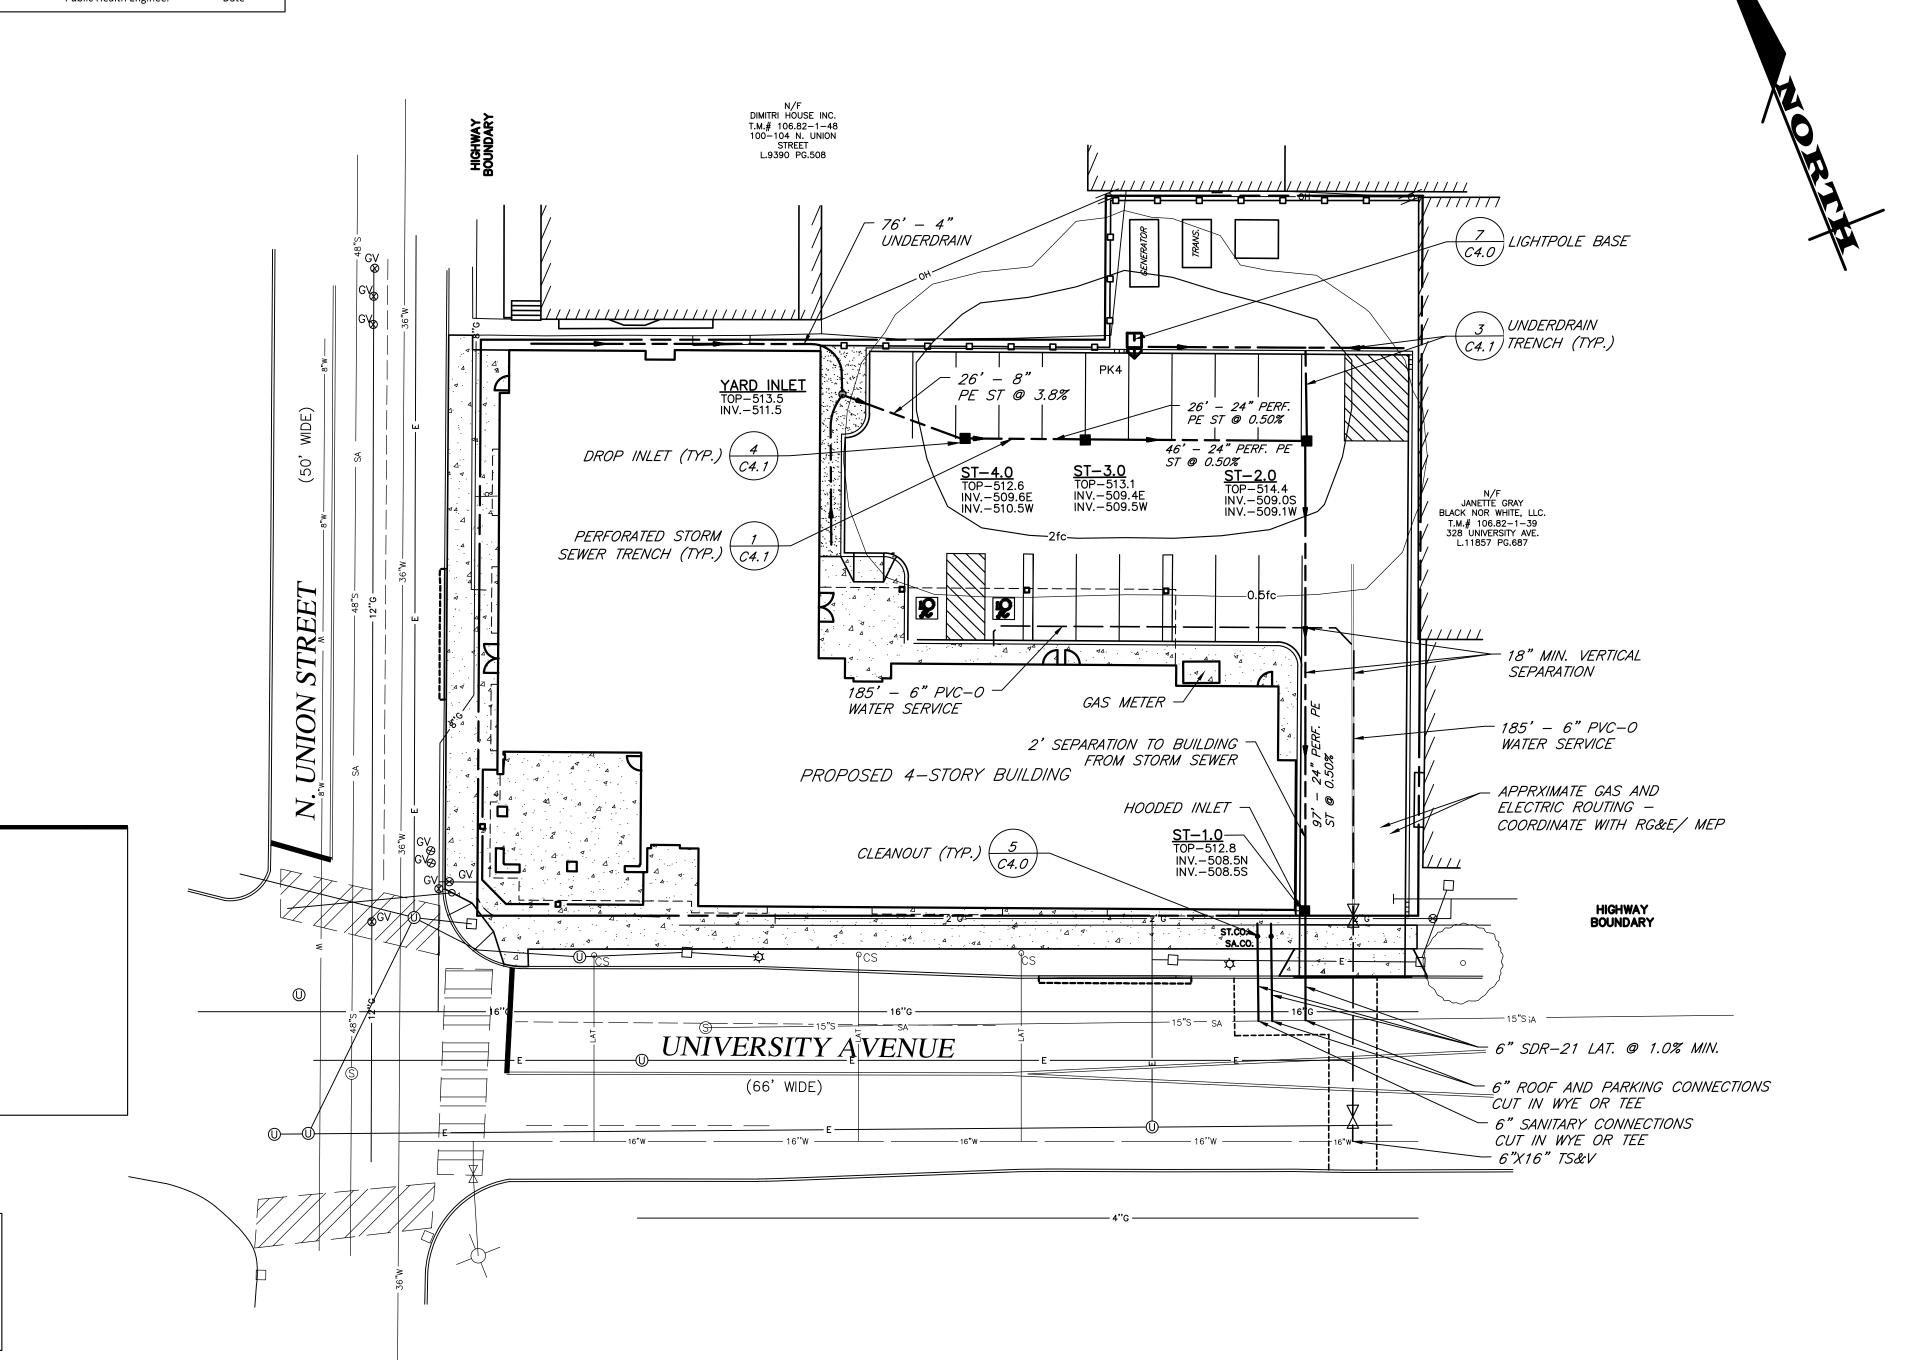

MARATHON ENGINEERING

ROCHESTER LOCATION

3 9 CASCADE DRIVE
ROCHESTER, NY 14614
5 8 5 - 4 5 8 - 7 7 7 0

1THACA LOCATION

840 HANSHAW RD, STE 12

ITHACA, NY 14850
607-241-2917

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CE PLACI TY, LLC

ER REALT

UNIVERSITY AV

0961-20

JOB NO:

DRAWN: MPT

DESIGNED: MPT

DATE: 07/28/2020

REVISIONS

DATE BY REVISION

BY REVISION

TI IS A VIOLATION OF NEW YORK STATE EDUCATION LAW ARTICLE 145, SECTION 7209 FOR ANY PERSON, UNLESS ACTING UNDER THE DIRECTION OF A LICENSED PROFESSIONAL ENGINEER OR LAND SURVEYOR, IF AN ITEM BEARING THE SEAL OF A PROFESSIONAL ENGINEER OR LAND SURVEYOR IF AN ITEM BEARING THE SEAL OF A PROFESSIONAL ENGINEER OR LAND SURVEYOR IF AN ITEM BEARING THE SEAL OF A PROFESSIONAL ENGINEER OR LAND SURVEYOR IS ALTERED, THE ALTERNIG ENGINEER OR LAND THE DESCRIPTION OF THE ALTERNION.

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DRAWING TITLE:
UTILITY PLAN

3 of 6
SHEET No:
0961-20

C2.0

DRAWING No:

JOB No:

EARTHWORK

THESE NOTES DO NOT SUPPLANT THE GEOTECHNICAL REPORT OF RECORD BUT ARE INTENDED AS A GENERAL GUIDE TO

- 1. PREPARATION PRIOR TO START OF EARTHWORK OPERATIONS THE CONTRACTOR SHALL COMPLETE THE FOLLOWING APPLICABLE ITEMS AS DEFINED BY CONTRACT DOCUMENTS:
 - SITE DEMOLITION REMOVAL AND DISPOSAL OFF-SITE IN A LEGAL MANNER; STRUCTURES, UTILITIES,
 - PAVEMENTS, ETC. • CLEARING AND GRUBBING - REMOVAL AND DISPOSAL OFF-SITE IN A LEGAL MANNER; TREES, BRUSH,
 - STUMPS, ETC. • TOPSOIL STRIPPING - STRIP AND STOCKPILE TOPSOIL FOR REUSE. EXCESS TOPSOIL MAY BE REMOVED
 - FROM SITE WITH APPROVAL BY OWNER AND MUNICIPALITY.
- 2. RESPONSIBILITY THE CONTRACTOR IS RESPONSIBLE FOR:
 - ESTIMATE COMPLETION OF A QUANTITY TAKEOFF TO DETERMINE THE VOLUME OF CUT, FILL, AND TOPSOIL. COMPARE AND COORDINATE WITH INFORMATION PROVIDED BY THE DESIGN ENGINEER.
 - GRADE TOLERANCES ESTABLISHING DESIGN SUBGRADE ELEVATIONS TO WITHIN ONE TENTH OF ONE FOOT
 - (0.10') IN PAVEMENT AREAS (INCLUDING WALKS) AND TO WITHIN THIRTY-THREE HUNDREDTHS OF ONE FOOT (0.33') FOR ALL REMAINING AREAS. • COMPACTION - ACHIEVING THE SPECIFIED MINIMUM COMPACTION VALUES FOR EMBANKMENT/FILL AREAS.
 - THE TERMS "FILL" AND EMBANKMENT" ARE INTERCHANGEABLE. • CUTS - ONCE EXCAVATIONS ARE SHAPED TO THE DESIGN GRADES THE AREAS SHALL BE PROTECTED TO ASSURE THAT THE INTEGRITY OF MATERIAL IS NOT COMPROMISED BY CONSTRUCTION VEHICLES AND/OR IMPROPER DRAINAGE. AREAS DETERMINED BY CONTRACTOR TO BE NOT SUITABLE FOR SUBGRADE PLACEMENT SHALL BE IMMEDIATELY REPORTED WHEN THE SUBGRADE IS ESTABLISHED TO OWNER'S REPRESENTATIVE. STABILIZATION MEASURES FOR CUT AREAS MAY BE CONSIDERED BY OWNER'S REPRESENTATIVE AS A CHANGE TO THE BASE CONTRACT.
- 3. TESTING THE FOLLOWING MAXIMUM DRY DENSITIES SHALL BE ACHIEVED AS MEASURED BY THE MODIFIED
- PROCTOR METHOD ASTM D-1557: • 95% UNDER PAVEMENTS, WALKS, AND IN STRUCTURAL FILL AREAS
- 85% IN REMAINING AREAS

THE AGREEMENT BETWEEN THE OWNER AND CONTRACTOR SHALL DEFINE THE NUMBER OF TESTS AND RESPONSIBILITY. WE RECOMMEND IN EMBANKMENT AREAS ONE PER LIFT AND/OR ONE PER 1,000 CUBIC YARDS.


- 4. LIFT THICKNESS THE MAXIMUM LIFT THICKNESS UNDER PAVEMENTS, WALKS, AND STRUCTURAL FILLS SHALL BE 12 INCHES. HAND OPERATED COMPACTION FILLS SHALL NOT EXCEED 6 INCHES.
- 5. PROOF ROLLING THE OWNER'S REPRESENTATIVE SHALL REQUEST A PROOF ROLL (I.E. LOADED TEN WHEELER) OF SUBGRADE AREAS PRIOR TO PLACEMENT OF SUBBASE MATERIALS. AREAS THAT "FAIL" SHALL BE REMOVED AND REPLACED TO ACHIEVE A PASSING SUBGRADE.

EROSION CONTROL

- 1. INSPECTION EROSION CONTROL (EC) MEASURES INSTALLED AND MAINTAINED BY THE SITE WORK CONTRACTOR ARE SUBJECT TO THE REVIEW AND APPROVAL OF THE: MUNICIPALITY, DESIGN ENGINEER, AND OWNER'S REPRESENTATIVE. IMMEDIATE ACTION BY THE CONTRACTOR SHALL BE TAKEN IF ADDITIONAL OR CORRECTIVE MEASURES ARE REQUIRED BY ANY ONE OF THESE CITED REVIEWERS.
- 2. PRE-CONSTRUCTION THE APPROPRIATE EROSION CONTROL MEASURES AS DEFINED BY THE CONSTRUCTION DOCUMENTS SHALL BE INSTALLED PRIOR TO THE START OF ANY CONSTRUCTION ACTIVITIES.
- 3. SLOPES UPON COMPLETION OF GRADING, SLOPES WITH A GRADIENT OF ONE FOOT VERTICAL TO THREE FEET HORIZONTAL (1 ON 3) OR GREATER SHALL BE: TOPSOILED, SEEDED, FERTILIZED AND MULCHED OR TREATED AS SPECIFIED ON CONTRACT DRAWINGS.
- 4. DUST THE CONTRACTOR SHALL APPLY WATER AND/OR CALCIUM CHLORIDE, AS CONDITIONS WARRANT, TO CONTROL WIND BORN EROSION. THIS MEASURE APPLIES TO: HAUL ROADS, CUT AND FILL OPERATIONS, SUB-BASE AND ANY OTHER EXPOSED SURFACES.
- 5. OPERATION & MAINTENANCE THROUGHOUT THE PERIOD OF CONSTRUCTION AND PRIOR TO ESTABLISHING FINAL GROUND COVER THE SITE CONTRACTOR IS RESPONSIBLE FOR THE OPERATION AND MAINTENANCE OF THE TEMPORARY EROSION CONTROL MEASURES.
- 6. WORK STOPPAGE ALL DISTURBED AREAS NOT TO BE WORKED WITHIN 21 DAYS MUST BE SEEDED WITHIN 14 DAYS FROM THE LAST CONSTRUCTION ACTIVITY IN THAT AREA.
- 7. SEQUENCE THE CONTRACTOR SHALL INSTALL EROSION CONTROL MEASURES IN THE FOLLOWING SEQUENCE
- UNLESS AUTHORIZED OTHERWISE AT PRE-CONSTRUCTION MEETING: • INSTALL PERIMETER SEDIMENT CONTROLS, I.E. EROSION FENCING.
- NSTALL STABILIZED CONSTRUCTION ENTRANCE. PROTECT VEGETATION TO REMAIN.
- CLEAR/GRUB AND CONSTRUCT DIVERSIONARY SWALES, AND SEDIMENT BASINS. COMPLETE CLEARING AND GRUBBING OPERATION.
- PLACE EROSION CONTROL MEASURES AT TOPSOIL STOCKPILES AND STRIP TOPSOIL.
- CONSTRUCT SWALES AND SILTATION DEVICES AS EARTHWORK OPERATIONS PROGRESS. MAINTAIN EROSION CONTROL MEASURES AND PLACE ADDITIONAL MEASURES AS EARTHWORK AND
- UNDERGROUND UTILITIES ARE CONSTRUCTED.
- RESTORE AREAS AS DEFINED BY CONTRACT DOCUMENTS.
- REMOVE EROSION CONTROL MEASURES AS AREAS ARE REESTABLISHED WITH GROUND COVER.

- ALL SIDEWALKS SHALL BE 5% MAX. IN THE
- DIRECTION OF TRAVEL AND 2% MAX. CROSS SLOPE. - ADA PARKING SPACES SHALL BE 2% MAXIMUM

SLOPE IN ANY DIRECTION.

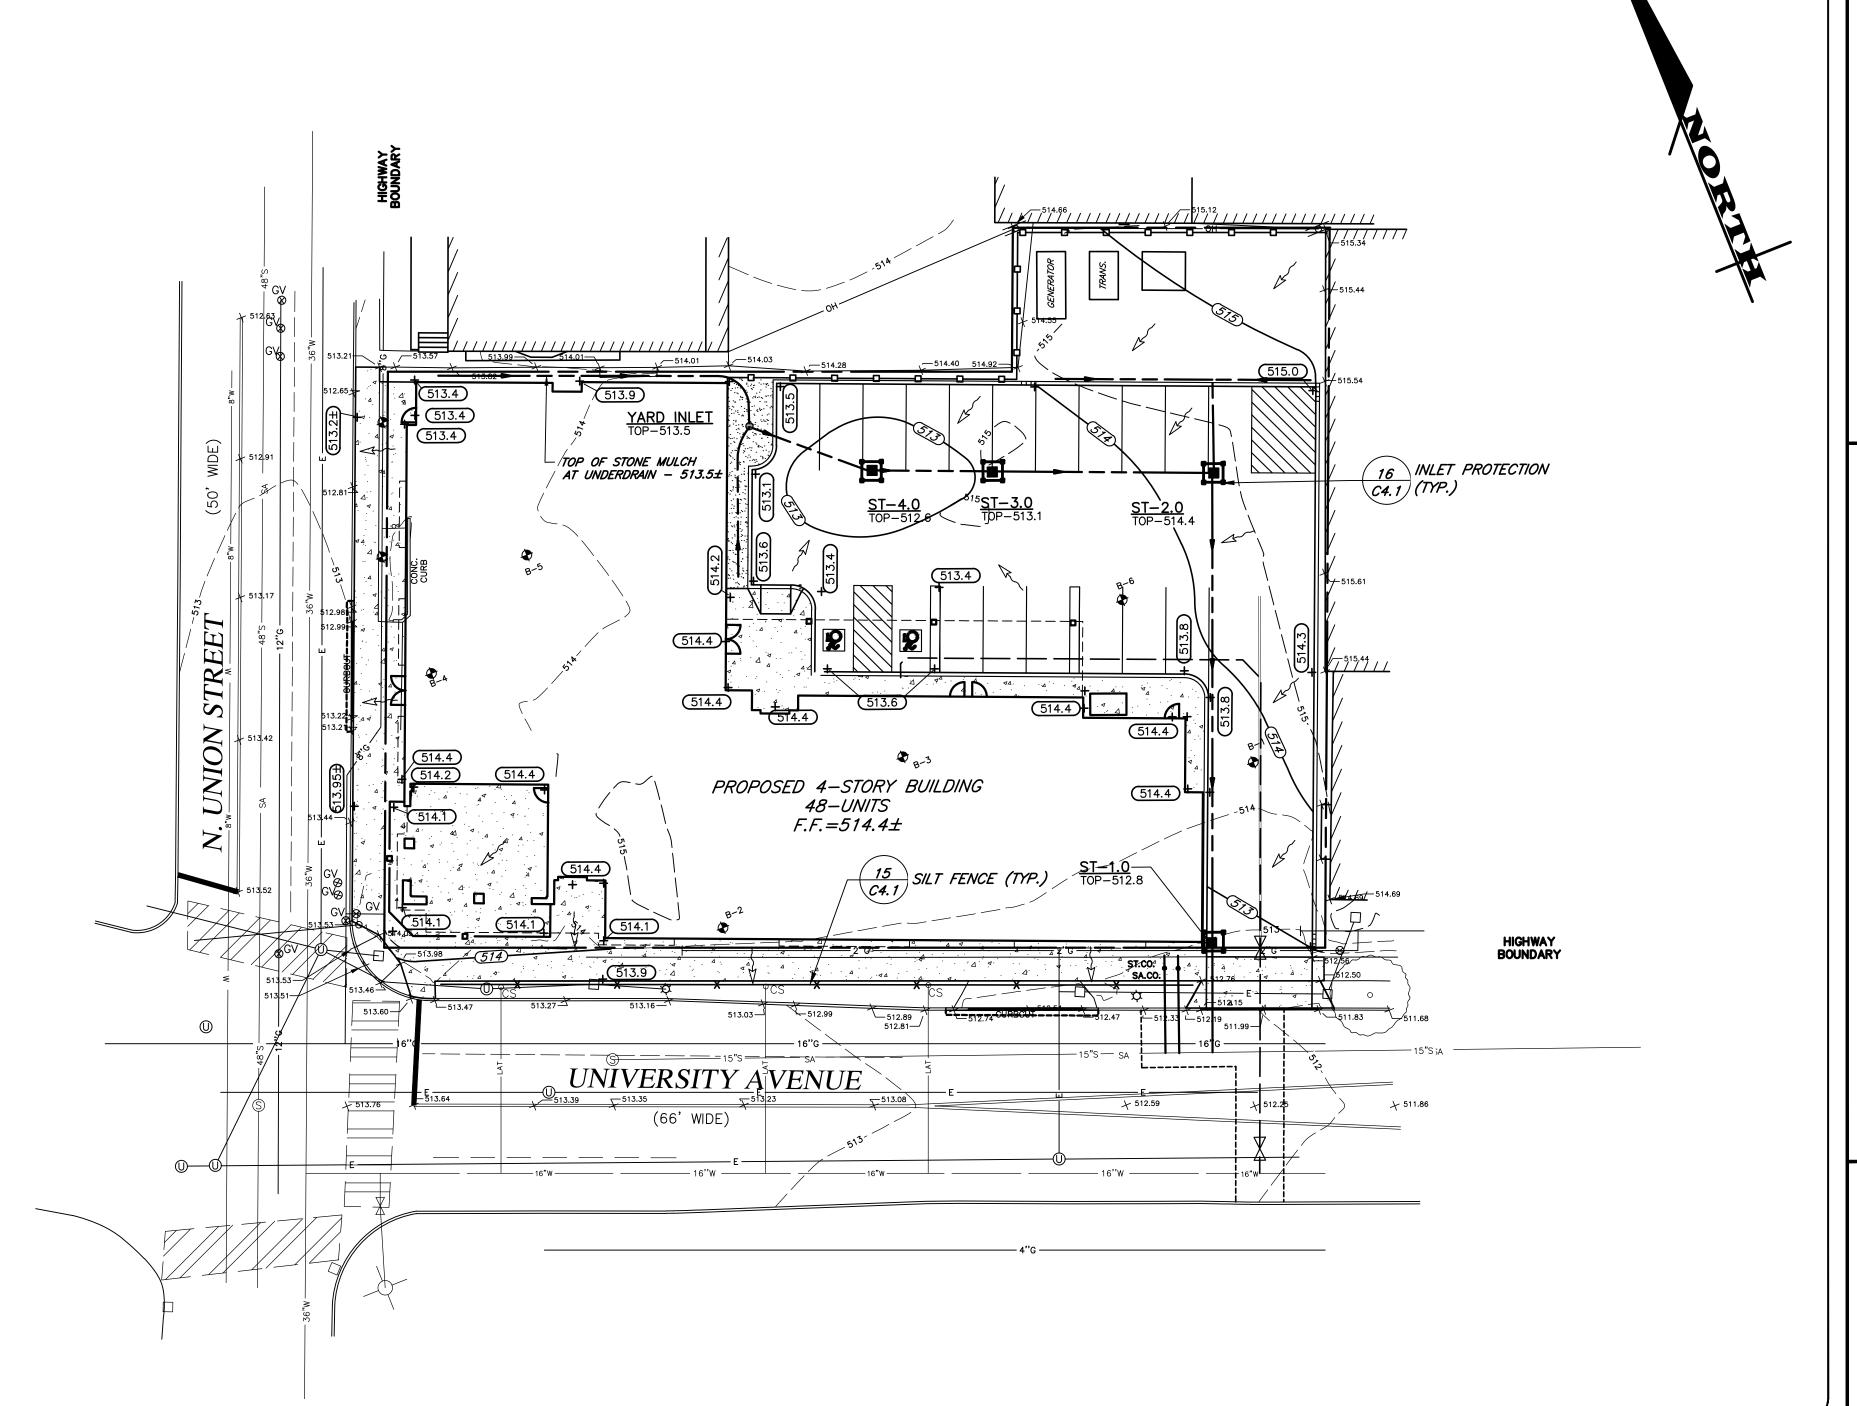



39 CASCADE DRIVE ROCHESTER, NY 14614 5 8 5 - 4 5 8 - 7 7 7 0

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ITHACA, NY 14850 6 0 7 - 2 4 1 - 2 9 1 7 www.marathoneng.com


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DRAWING TITLE: **GRADING AND** E.C. PLAN SHEET No: 0961-20

DRAWING No:

JOB No:

ROBERT P. BRINGLEY

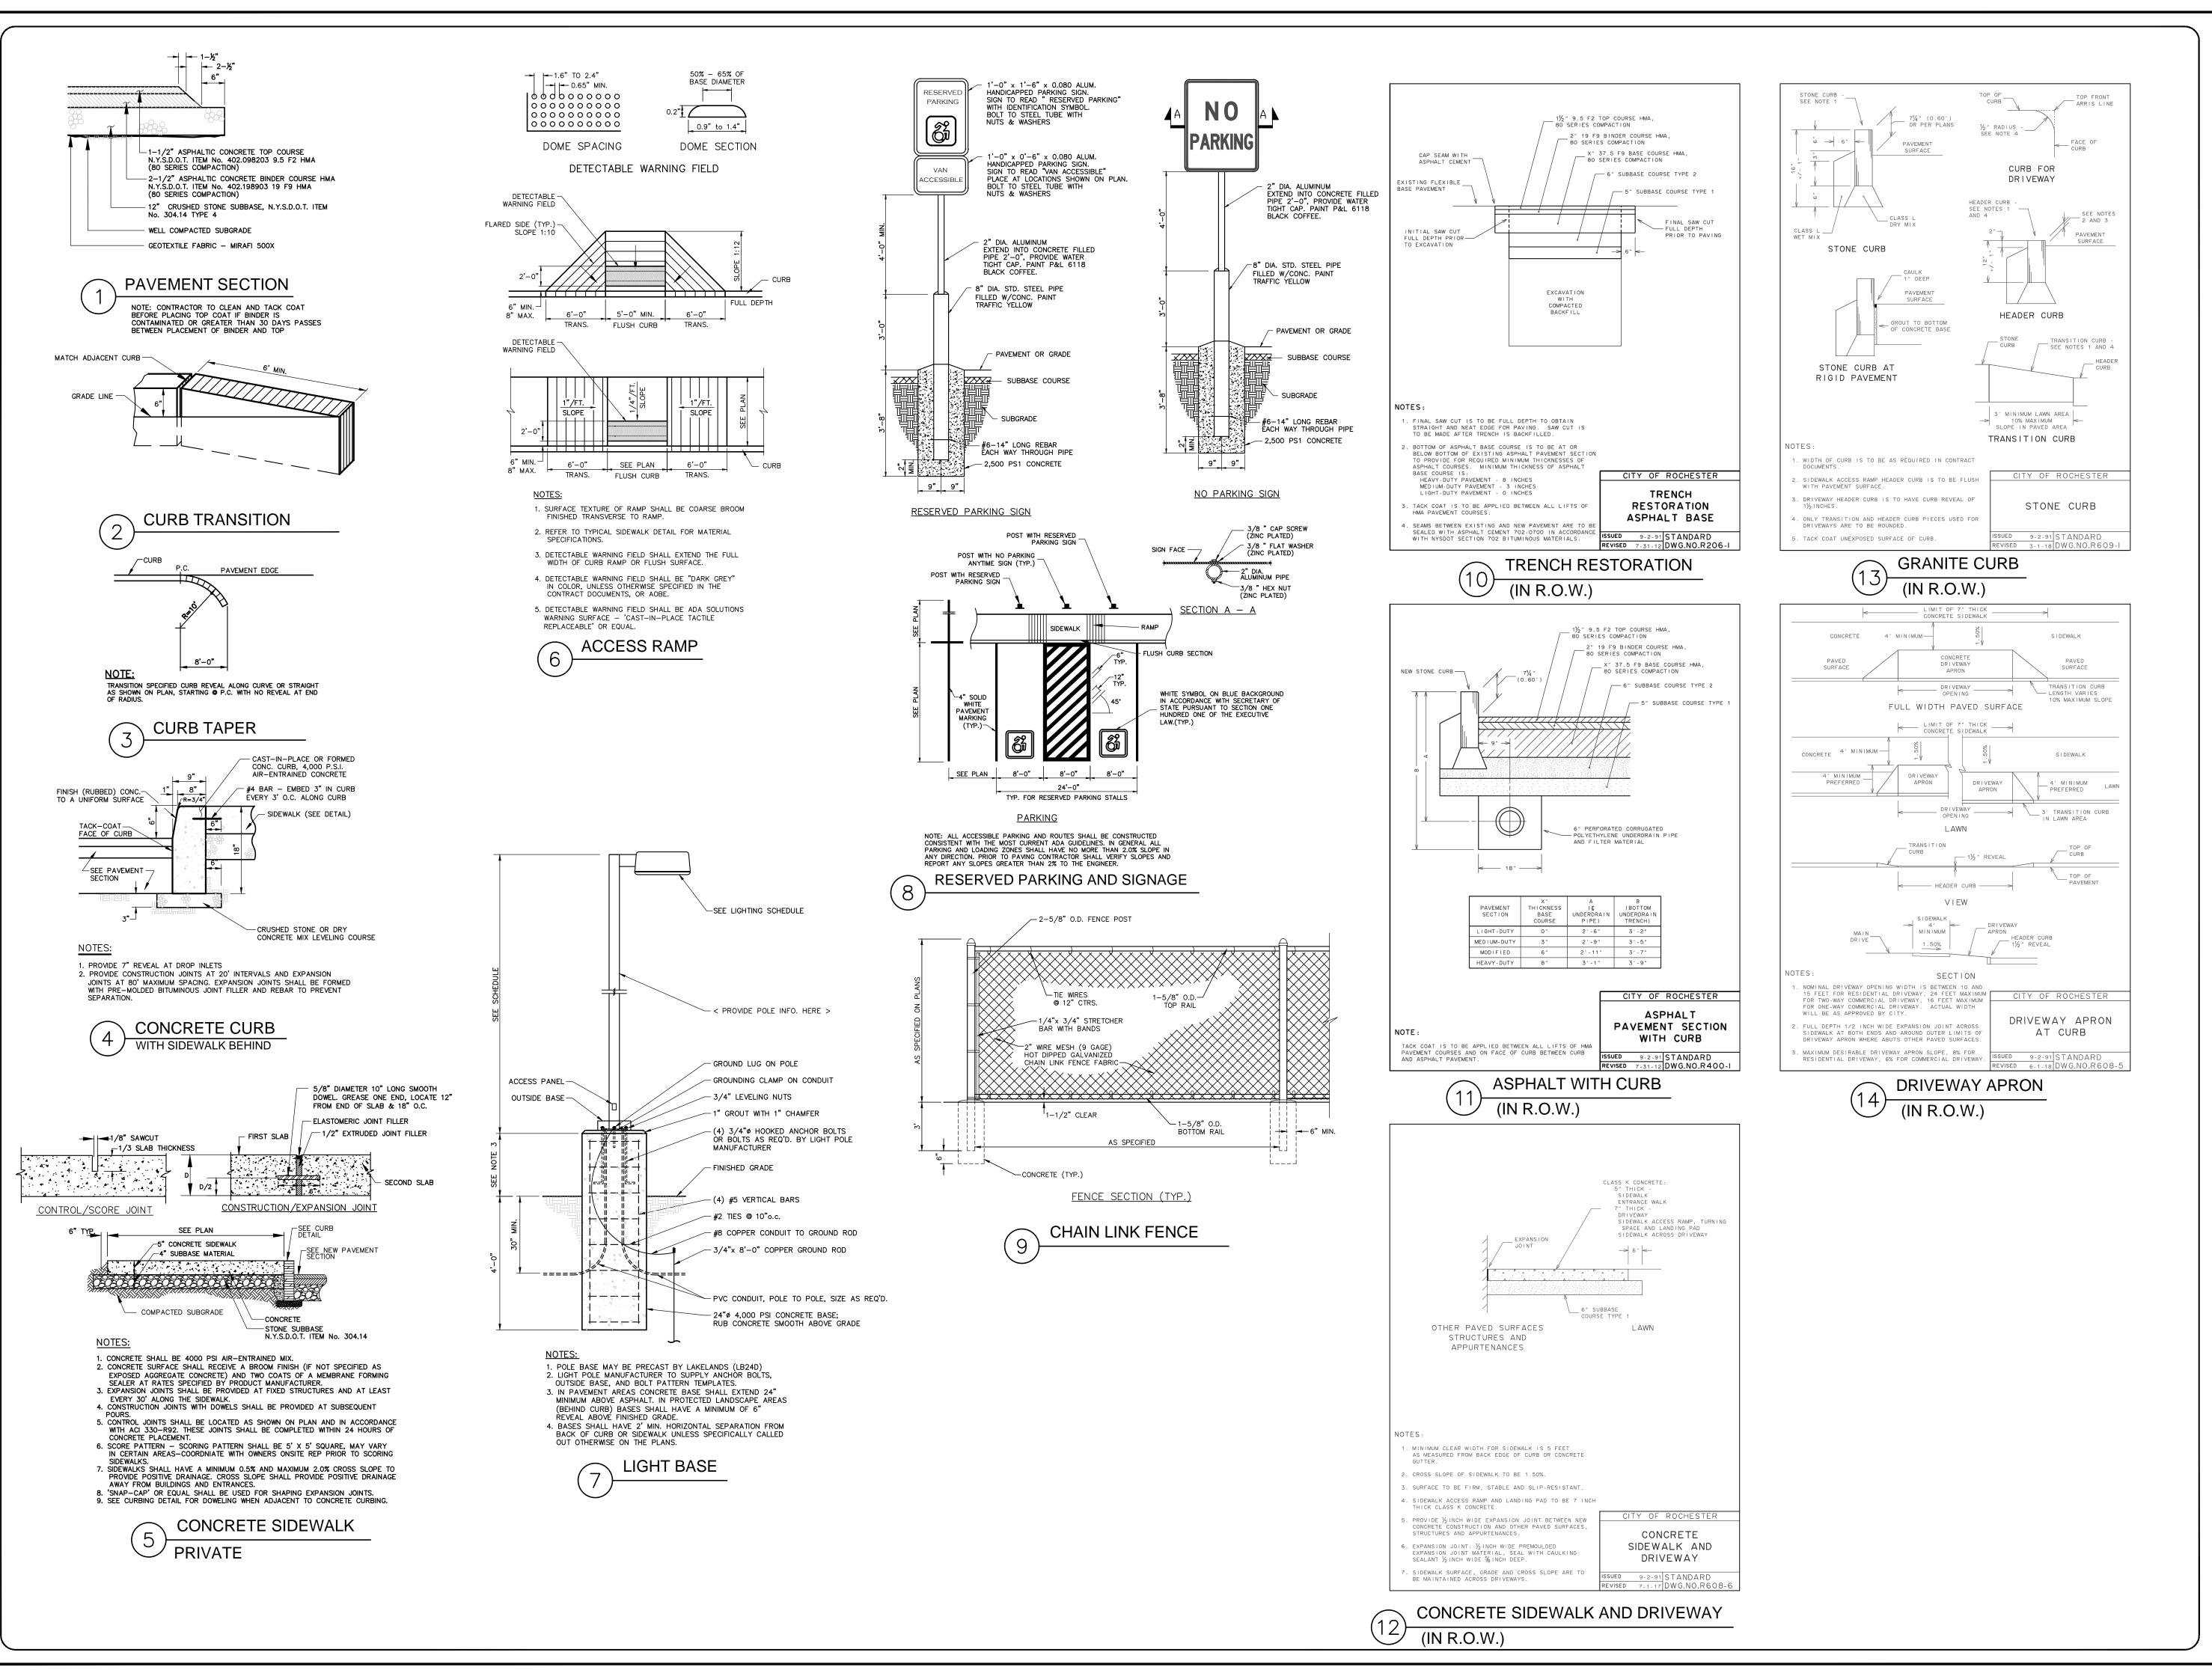

MARATHON ENGINEERING ROCHESTER LOCATION

> 39 CASCADE DRIVE ROCHESTER, NY 14614 5 8 5 - 4 5 8 - 7 7 7 0 ITHACA LOCATION 840 HANSHAW RD, STE 12 ITHACA, NY 14850 6 0 7 - 2 4 1 - 2 9 1 7

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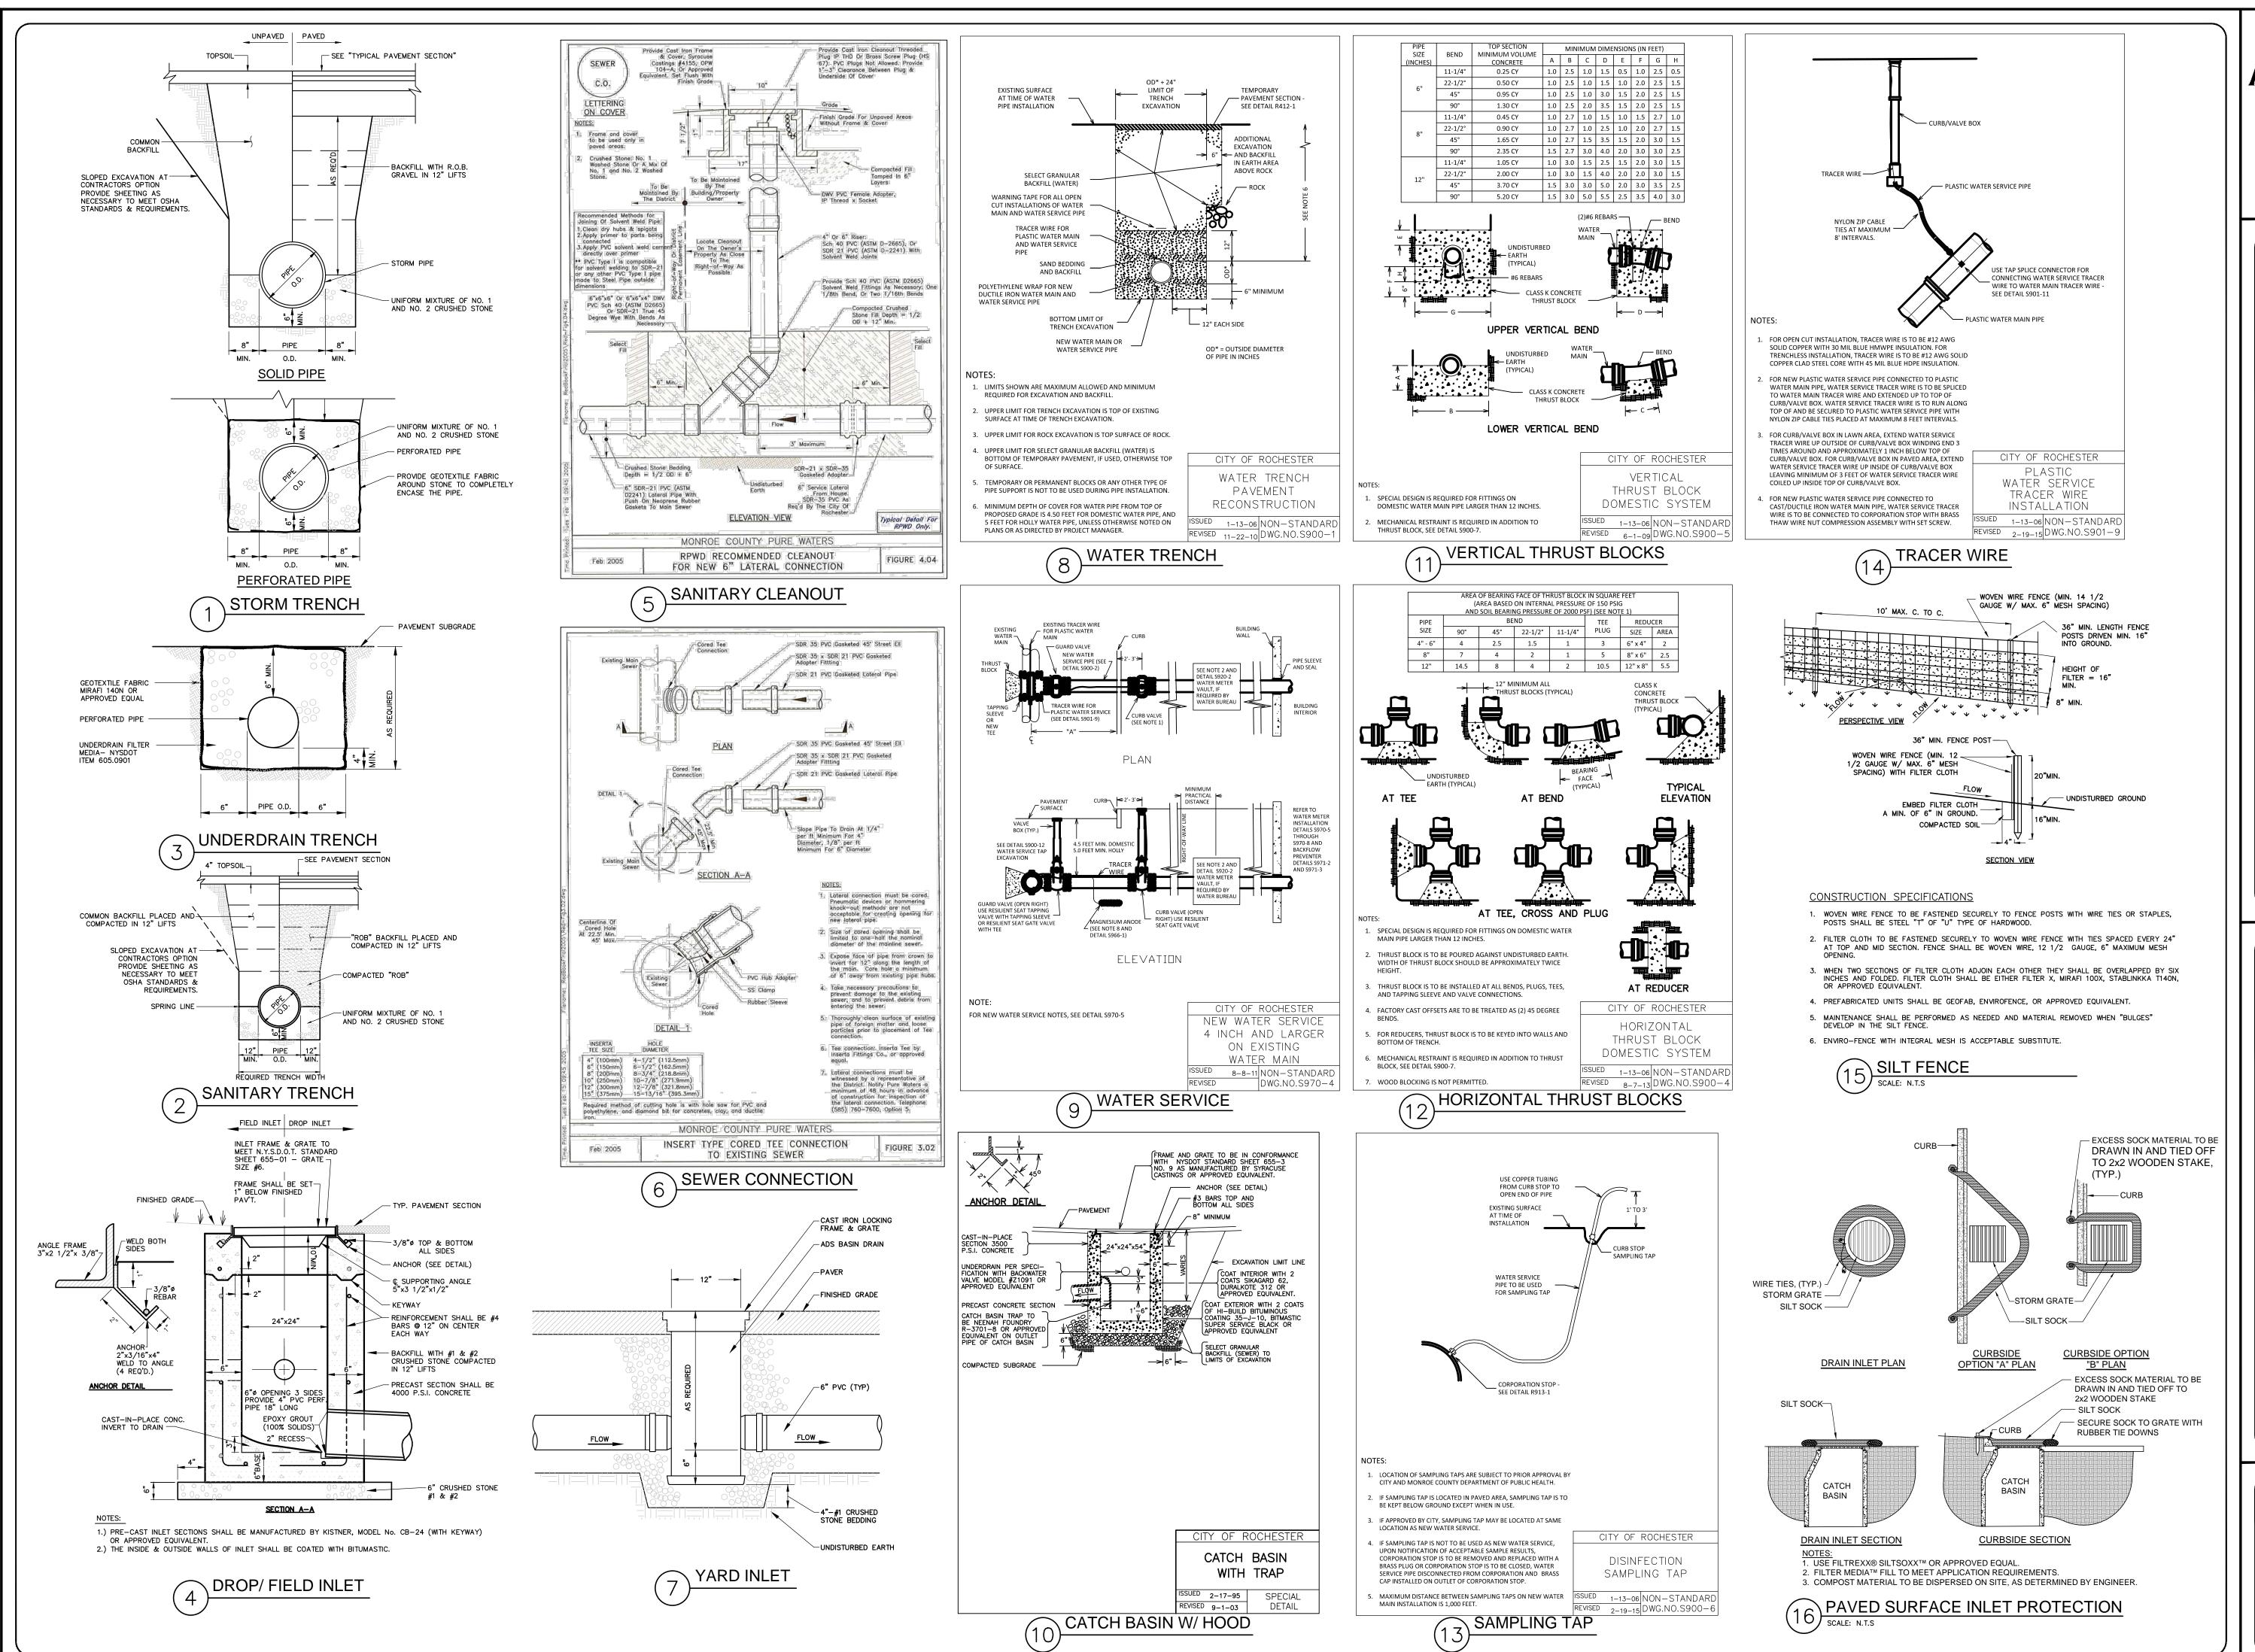
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ROBERT P. BRINGLEY DRAWING TITLE: CONSTRUCTION **DETAILS** SHEET No:

DRAWING No:

0961-20

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> 39 CASCADE DRIVE ROCHESTER, NY 14614 ITHACA LOCATION

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DRAWING TITLE: CONSTRUCTION **DETAILS**

ROBERT P. BRINGLEY

SHEET No: 0961-20 JOB No: DRAWING No:

1. Dimensions are to face of framing, UON. DESCRIPTION NO. 2. See drawings A-420 & A-423 for typical information in Residential Units Doors are to be installed with their hinge side 4" from adjacent perpendicular wall, unless otherwise shown. See jamb details on A-601. 4. Resilient channels are to be on corridor side of unit walls, TYP. Where braced wall panels occur, resilient channels are to be interrupted by braced wall panel. Ensure finished surface of drywall is flush at transitions between resilient channel and braced wall panel substrates and at locations where resilient channels ends but wall continues. 5. CG = corner guards 6. V/HAU = Visual/Hearing Accommodating Units 7. Refer to G-006 for Unit Accessibility INDICATES (TYPE A) ACCESSIBLE UNIT 29' - 6 1/2" 6' - 5 1/2" 59' - 0" 30' - 0" 10' - 0" 1 BDRM Type I 156 1 BDRM Type I 155 154 A-202 1 Trash 117 Janitor 116 49 SF 54 SF 118 Above Overhang -5" Concrete Floor 241 SF Corridor 2 115 514 SF Storage - 111A -Maintenance / Utility 4 SF 289 SF Elevator D D D D 101A 114 Mechanical 112 505 SF 234 SF 77 SF 113 241 SF Corridor 1 105 743 SF Entry Lobby
101
415 SF A-420 2 **(**A-202 30' - 0" 38 SF (103) 40 SF Outside Patio -77 SF 1 BDRM Type I 1 BDRM Type I 1 BDRM Type I 150 151 152 1/2" RESILIENT CHANNELS (WHERE INDICATED ON PLANS) -Low Enclosed Fence 1/2" PLYWOOD 10' - 8" SHIM M.O. 30' - 1 3/4" 11' - 10 1/4" 123' - 2" BLOCKING FASTENERS 165' - 2" HANDRAIL/ A-201 CRASH RAIL -**CORRIDOR SIDE** Typical Section Detail - Handrail / Crash Rail
3" = 1'-0"

PLAN KEY NOTES



585 232 8300 | rochester@swbr.com

GENERAL NOTES

Drawn By: Author
Checked By: Checker
Project Manager: DG

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Revisions

University & Union Apartments

302 University Avenue Rochester NY, 14607 SWBR Project Number 20565.00


Conifer Realty LLC 1000 University Avenue, Suite 500 Rochester, NY 14607

A-101

First Floor Plan

08/01/2020 HCR Submission Set

Exterior Elevation Keynotes				
No.	Keynote Description			
1	Building Signage			
2	Aluminum Storefront Sliding Door System			
3	Aluminum Storefront Window System			
4	Single-Hung Vinyl Window			
5	Smooth Finished Water Manage EIFS with score pattern as indicated - Color 1			
6	Smooth Finished Water Manage EIFS with score pattern as indicated - Color 2			
7	Smooth Finished Water Manage EIFS with score pattern as indicated - Color 3			
8	Prefinished Vinyl Horizontal Lap Siding - Color 1			
9.	Prefinished Vinyl Horizontal Lap Siding - Color 2			
10	Brick			
11	EPDM Overhang at Main Entrance			
12	Fixed Vinyl Window			
13	Panel Infill			
14	Continuous Trim. Typical			
15	Large Format Masonry base with Metal Wrapped column above.			
16	Vinyl Trim Board			
17	Window Shade			

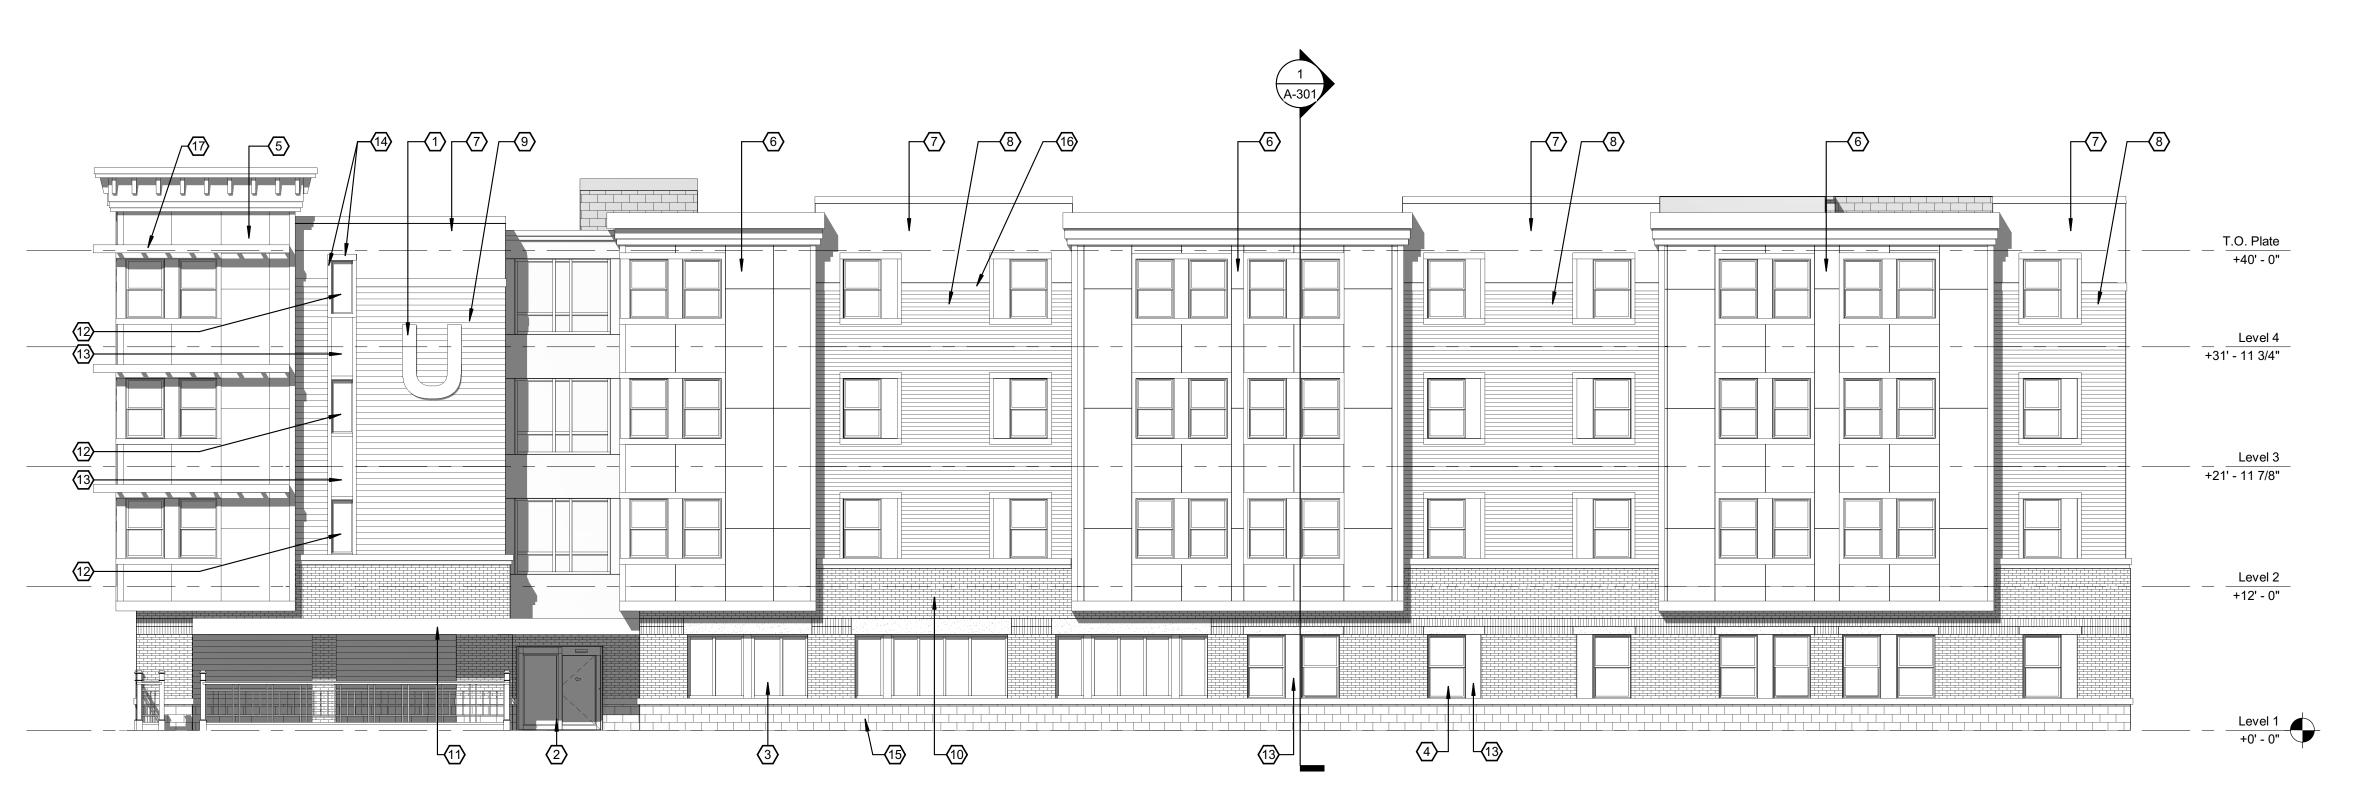

3 EXTERIOR ELEVATION - SOUTH

1/8" = 1'-0"



EXTERIOR ELEVATION - NORTH

Drawn By: Author Checked By: Checker

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Project Manager: DG

Revisions

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Rochester NY, 14607 SWBR Project Number 20565.00


Conifer Realty LLC 1000 University Avenue, Suite 500 Rochester, NY 14607

A-201

Exterior Elevation and Details

08/01/2020 HCR Submission Set

. <u>* *</u>				
		Exterior Elevation Keynotes		
N	lo.	Keynote Description		
	•			
	1	Building Signage		
	2	Aluminum Storefront Sliding Door System		
•	3	Aluminum Storefront Window System		
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	5	Smooth Finished Water Manage EIFS with score pattern as indicated - Color		
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	14	Continuous Trim. Typical		
	15	Large Format Masonry base with Metal Wrapped column above.		
	16	Vinyl Trim Board		
	17	Window Shade		

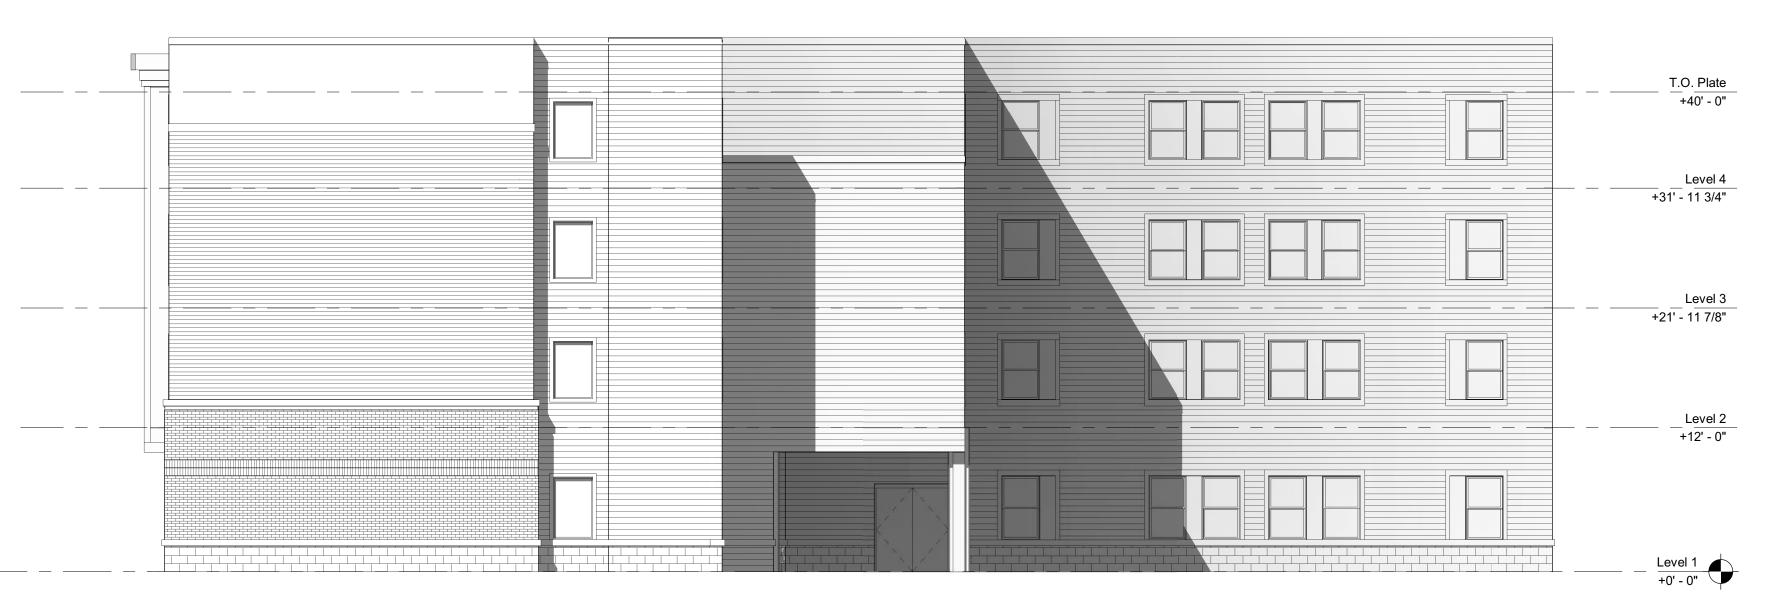

2 EXTERIOR ELEVATION - EAST
1/8" = 1'-0"



1 EXTERIOR ELEVATION - WEST

SWBR

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Drawn By: Author
Checked By: Checker
Project Manager: DG

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Revisions

University & Union Apartments
302 University Avenue
Rochester NY, 14607

SWBR Project Number 20565.00

Conifer Realty LLC
1000 University Avenue, Suite
500 Rochester,
NY 14607

A-202

Exterior Elevation and Details

08/01/2020 HCR Submission Set