
CITY OF ROCHESTER, NEW YORK

DEPARTMENT OF PARKS, RECREATION AND HUMAN SERVICES

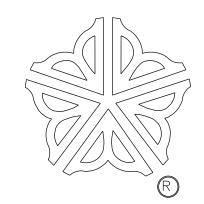

CARTER RECREATION CENTER

SITE IMPROVEMENTS

PROJECT NO. 20042

JULY 15, 2002

GENERAL NOTES

- 1. The horizontal and vertical location information (for the site's existing conditions) included in this drawing set has been obtained from a survey map entitled "Carter Recreation Center—Playground and Site Topography" prepared by the Department of Environmental Services, Bureau of Engineering Services, Office of Maps and Surveys, City of Rochester, New York, dated march 12, 1997.
- 2. The contractor shall be responsible for field verification of all existing and proposed horizontal and vertical location information shown on these plans for both bidding and construction purposes. Any discrepancies shall be reported immediately to the owner's representative.
- 3. The contractor shall have all utilities and infrastructure field located and marked by the responsible public or private agency prior to the start of construction, and shall maintain all location stakes and markings throughout the construction process.
- 4. Prior to the start of construction, the contractor shall field verify the location, pipe sizes, and invert elevations of any existing sewers to be affected by the project.
- 5. Provide the owner's representative with at least seven days notice for any required interruption of a utility service. Written permission from the owner's representative is required before the utility service can be interrupted. A temporary service may be required by the owner.
- 6. The contractor shall be responsible for any damage to pavement, curbs, plantings, utilities, and any other existing site features to remain caused by his operations. All such damage shall be replaced in kind by the contractor at his expense.
- 7. The contractor shall not disturb any area outside the project limits.
- 8. The contractor shall preserve and protect all existing trees, shrubs, and groundcovers within and adjacent to the project site except for those specifically identified on these plans and approved for removal in the field by the owner's representative. See tree protection detail 9—16.
- 9. The contractor shall be responsible for maintaining the construction site in a safe and orderly condition throughout the construction period. The contractor shall pay particular attention to pedestrian safety issues. The contractor shall take all necessary precautions and use barriers and other devices, as necessary, to keep pedestrians out of the construction zone.
- 10. The contractor shall maintain the project site in a neat and orderly state and take the necessary steps to minimize the migration of dust and debris from the project site. Construction travel routes and all areas adjacent to the construction site shall be checked daily and cleaned, as necessary, to remove any accumulation of mud, dust, or construction debris.
- 11. Prior to completion of the project, the contractor shall check, and clean all manholes, catch basins, drain inlets, and other drainage system components within the project limits and in the drainage path of the project site so that they are free from all debris, silt, etc.
- 12. The contractor shall be responsible for obtaining any required municipal construction permits and/or inspections.
- 13. The contractor is advised to carefully review all of the additional project requirements contained within the project manual, City of Rochester Standard Construction Contract documents, and the remainder of this drawing set.

ABBREVIATIONS

&	AND
@	AT
APPROX.	APPROXIMATE
ASPH.	ASPHALT
A.S.T.M.	AMERICAN SOCIETY FOR TESTING AND MATERIALS
C.B.	CATCH BASIN
C -	CENTER LINE
CLR.	CLEAR
CONC. C.O.	CONCRETE
D.I.	CLEAN OUT DRAIN INLET
E	ELECTRIC LINE
E.J.	EXPANSION JOINT
ELEV.	ELEVATION
EQ.	EQUAL
G.	GAS LINE
G.V.	GAS VALVE
H.H.	HAND HOLE
+H.P.	HIGH POINT
HYD.	HYDRANT
INV.	INVERT ELEVATION
I.J. L.P./L—POLE	ISOLATION JOINT
+L.P.	LIGHT POLE LOW POINT
тс.г. М.Н.	MANHOLE
MIN.	MINIMUM
MAX.	MAXIMUM
N. Y. S. D. O. T.	NEW YORK STATE DEPARTMENT OF TRANSPORTATION
P.B.	PULL BOX
P	PROPERTY LINE
P.O.B.	POINT OF BEGINNING
P.P.	POWER POLE
PT.	POINT
P.V.C.	POLYVINYL CHLORIDE
R	RADIUS
R.G.E.	ROCHESTER GAS AND ELECTRIC
RIM R.O.W.	RIM ELEVATION RIGHT OF WAY
SAN.	SANITARY SEWER
ST.	STORM SEWER
STD.	STANDARD
T/TEL.	TELEPHONE
TC/BC	TOP/BOTTOM OF CURB
T.H.	SOIL TEST HOLE
TR/BR	TOP/BOTTOM OF RAMP
TYP.	TYPICAL
V.C.P.	VITRIFIED CLAY PIPE
V.T.P. W	VITRIFIED TILE PIPE WATER LINE
VV	WATER LINE

WOOD LIGHT POLE


WATER VALVE

WITH

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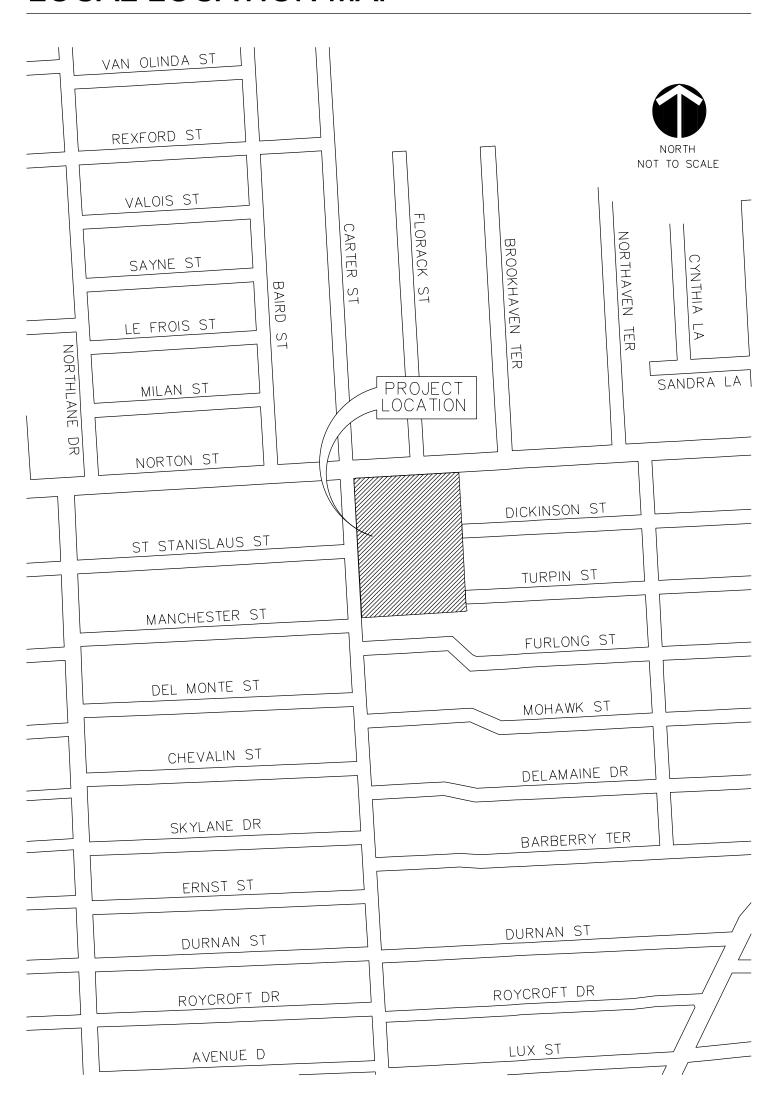
REGIONAL LOCATION MAP




W.L.P.

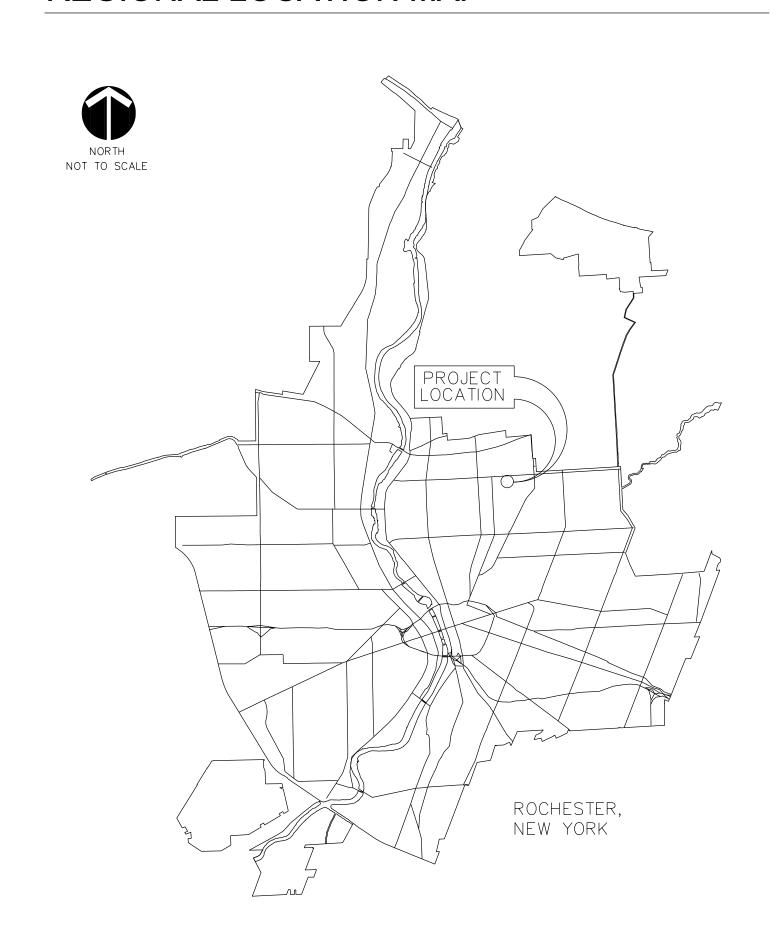W.V.

LOCAL LOCATION MAP



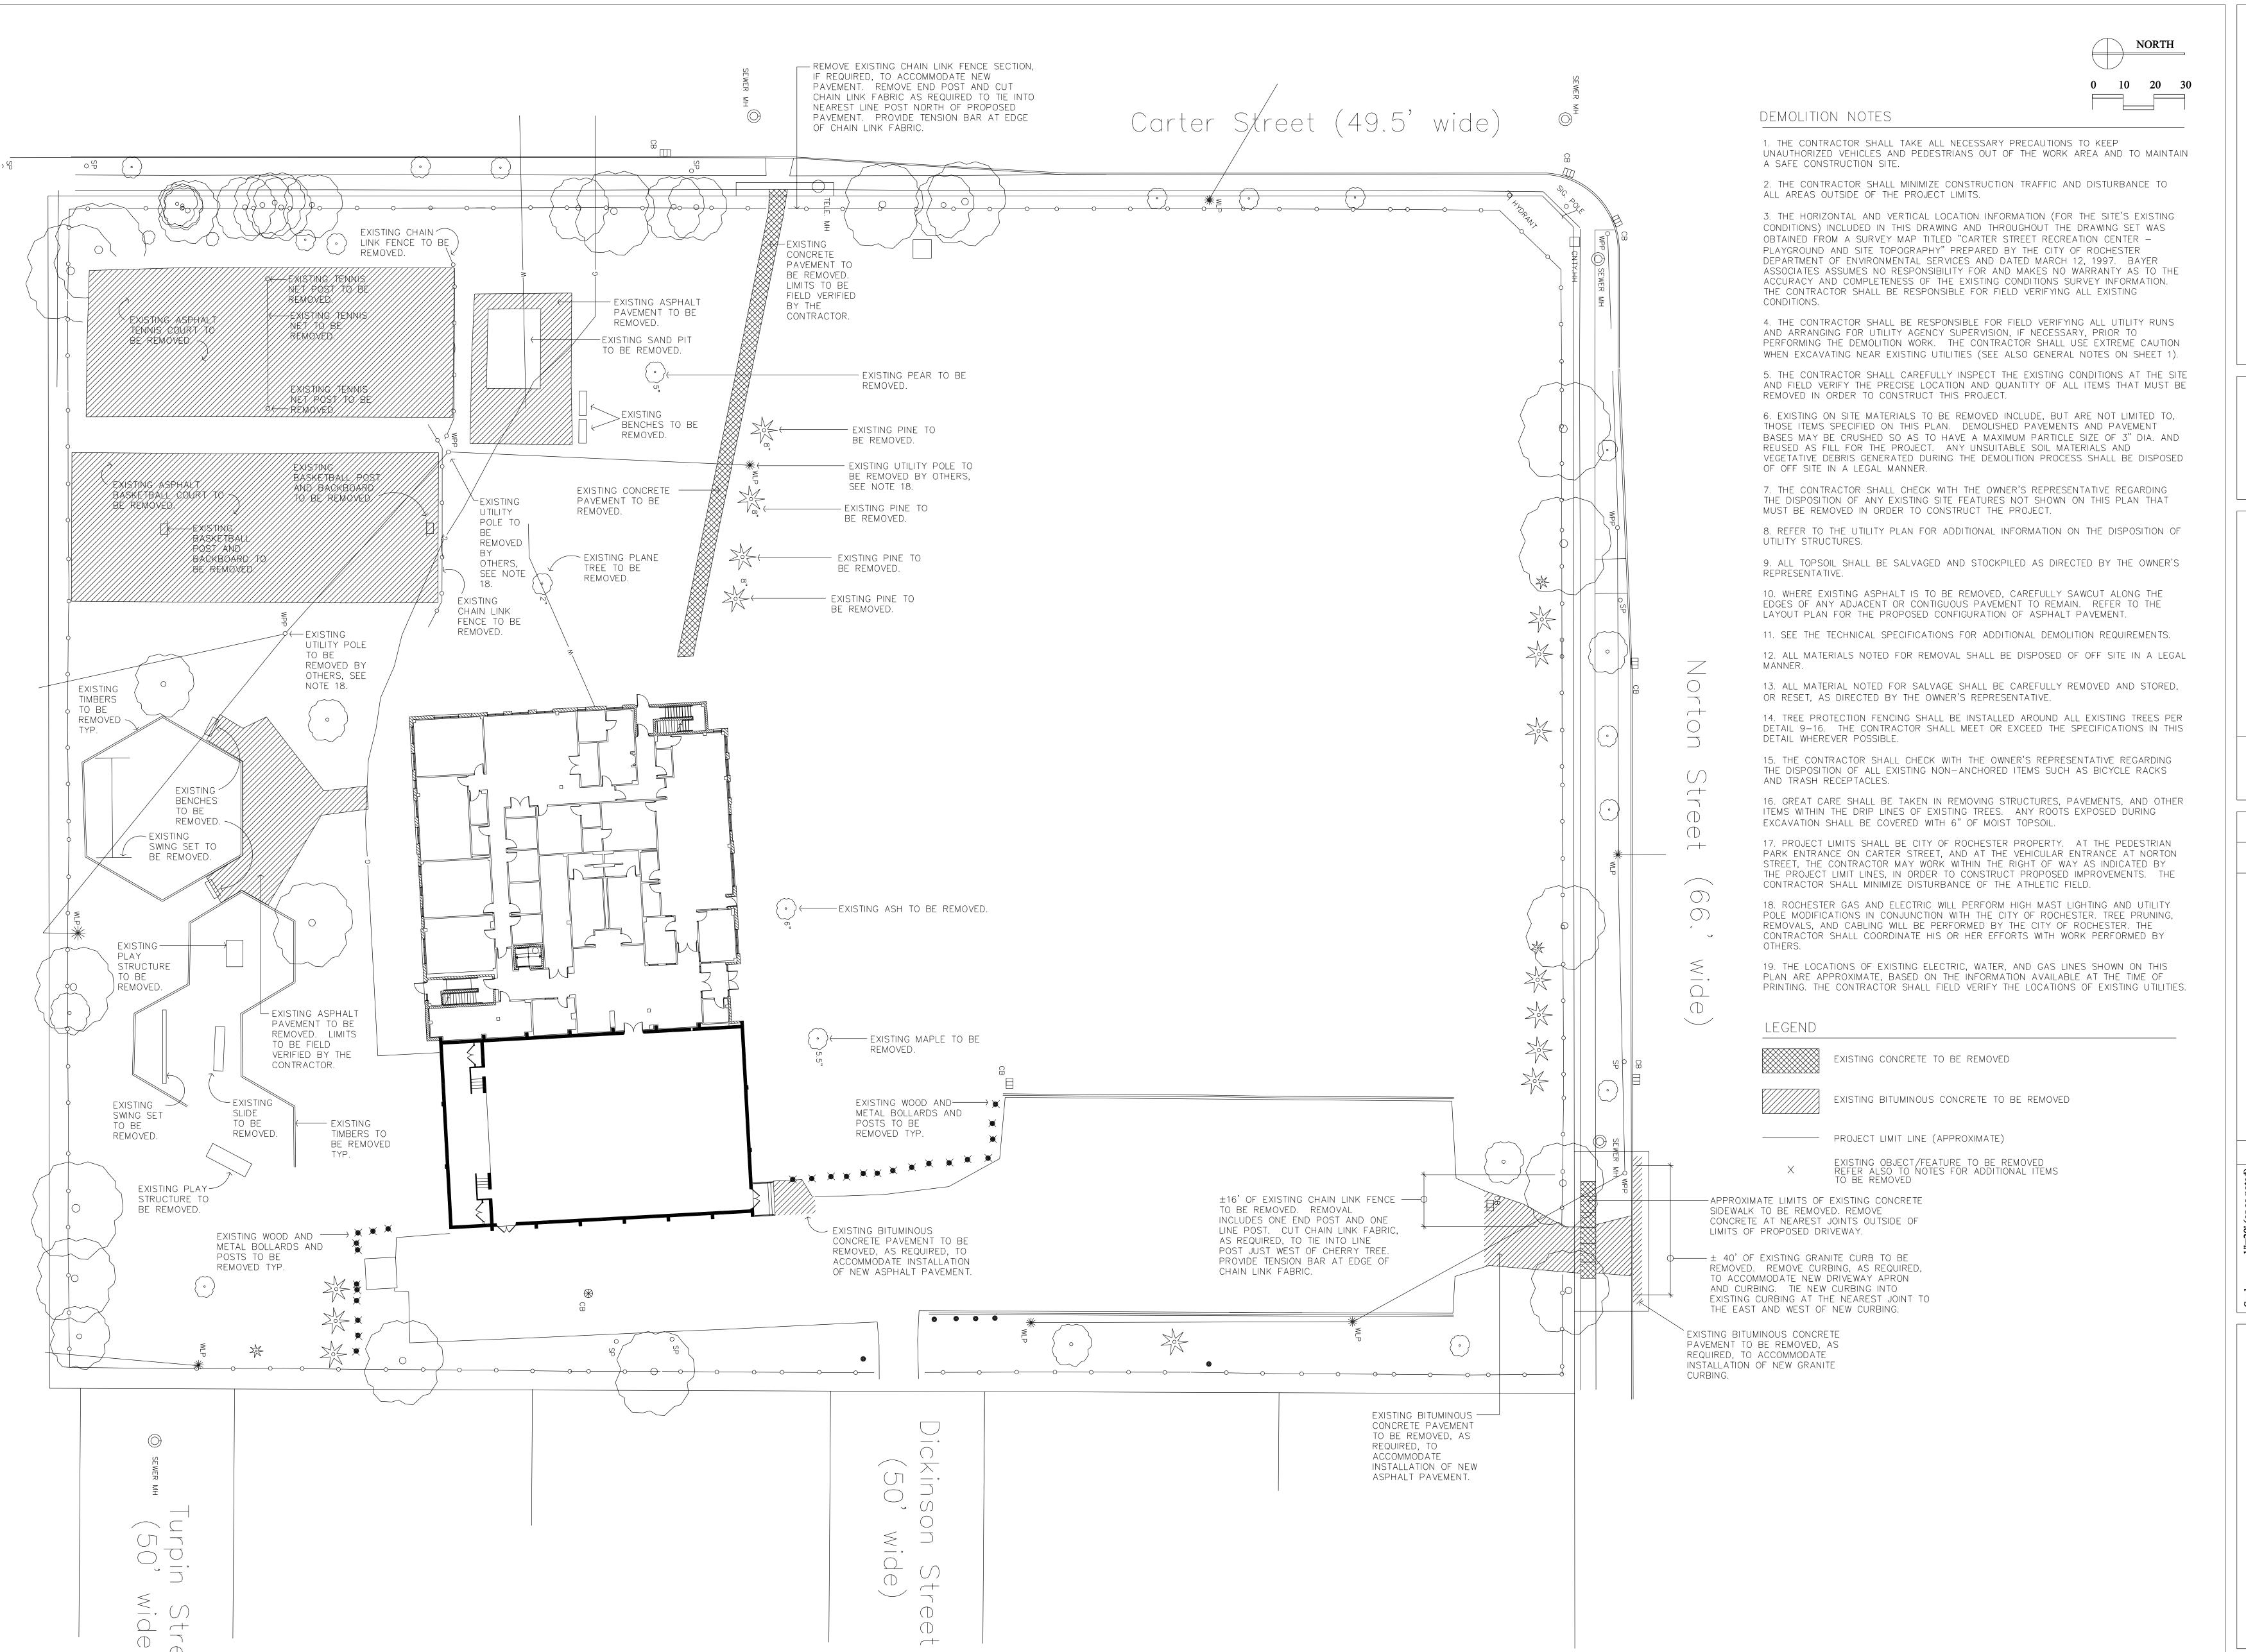

BAYER ASSOCIATE
LANDSCAPE ARCHITECTURE and PLANNI
4705 Main St., P.O. Box 220, Hemlock, NY 14466 (585) 367-8

Bureau of Environmental Services

Bureau of Engineering Services

City of Rochester, New York

Project Landscape Architect Jeffery J. Mroczek

Engineer in Charge Joann D. Beck, RLA

 Checked By:
 MHB

 Drawn By:
 RHW

 Design By:
 Bayer Assoc.

 Date:
 7/15/02

 Project No:
 20042

 No.
 Revisions

CARTER RECREATION CENTE
SITE IMPROVEMENTS
DEMOLITION PLAN

BAYER ASSOCIATES

LANDSCAPE ARCHITECTURE and PLANNING

Bureau of Engineering Services
City of Rochester, New York

Landscape Architect Jeffery J. Mroczek
er in Charge Joann D. Beck, RLA
lgineer George H. Stam, PE

 Checked By:
 MHB

 Drawn By:
 RHW

 Design By:
 Bayer Assoc.

 Date:
 7/15/02

CARTER RECREATIC
SITE IMPROVE



1. ALL LAYOUT DIMENSIONS IN THIS DRAWING SET SHALL BE FIELD VERIFIED BY THE CONTRACTOR. ANY DISCREPANCIES SHALL BE REPORTED IMMEDIATELY TO THE

2. THE CONTRACTOR SHALL ADHERE TO WRITTEN DIMENSIONS. DRAWINGS WITHIN THIS SET SHALL NOT BE SCALED.

3. ALL ANGLES ARE 90° UNLESS OTHERWISE NOTED.

OWNER'S REPRESENTATIVE FOR DECISION.

Carter Street (49.5' wide)

— TENNIS COURT
BITUMINOUS CONCRETE
PAVEMENT, SEE DETAIL
1-9.

8'X8' UNIT PAVER INLAY— TYP. SEE DETAILS 12-9 AND 14-9. UNIT PAVERS ARE PART OF ADD ALTERNATE NO. 8.

EXPANSION JOINT — TYP. SEE DETAIL

CONTROL JOINT TYP. -SEE DETAIL 8-9.

PEDESTRIAN GRADE

CONCRETE PAVEMENT

TYP. SEE DETAIL 8-9.

PEDESTRIAN GRADE
BITUMINOUS CONCRETE
PAVEMENT, TYP. SEE
DETAIL 3-9.

PLAYGROUND SAFETY SURFACE, SEE DETAIL 2-10.

EXISTING CONCRETE WALKWAY

— PEDESTRIAN GRADE BITUMINOUS CONCRETE PAVEMENT TYP. SEE DETAIL 3-9.

— PEDESTRIAN GRADE
BITUMINOUS CONCRETE
PAVEMENT TYP. SEE
DETAIL 3-9.

4'X4' UNIT PAVER INLAY TYP. SEE DETAILS 12-9 AND 13-9. UNIT PAVERS ARE PART OF ADD ALTERNATE NO. 8.

0 0 0

wide)

4. CONTROL AND EXPANSION JOINTS SHALL BE PLACED IN THE LOCATIONS INDICATED ON THIS DRAWING.

5. ISOLATION JOINTS SHALL BE PLACED WHEREVER PROPOSED CONCRETE PAVEMENT ABUTS CURBING, MOWING STRIPS, UTILITY STRUCTURES, EXISTING CONCRETE, AND ELSEWHERE AS INDICATED ON THIS DRAWING.

6. ADD ALTERNATE NO. 8 CALLS FOR THE SUBSTITUTION OF UNIT PAVERS PER DETAILS 12-9, 13-9, AND 14-9 FOR PEDESTRIAN GRADE CONCRETE PAVEMENT WHERE INDICATED IN THIS PLAN. FOR THE BASE BID, ALL UNIT PAVER AREAS SHALL BE BID AS PEDESTRIAN GRADE CONCRETE PAVEMENT PER DETAIL 8-9, AND SCORED ALONG A 4'X4' GRID AS SHOWN ON THIS PLAN.

7. ADD ALTERNATE NO. 9 CALLS FOR THE SUBSTITUTION OF COLORED CONCRETE PER DETAIL 8-9 FOR PEDESTRIAN CONCRETE IN THE WATER PLAY AREA ONLY (SEE DETAIL 3-12 FOR THE LIMITS OF THE WATER PLAY AREA).

8. ADD ALTERNATE NO. 10 CALLS FOR THE SUBSTITUTION OF POURED RUBBER SAFETY SURFACE PER DETAIL 5-9 FOR PEDESTRIAN GRADE CONCRETE PAVEMENT WITHIN THE WATER PLAY AREA (SEE DETAIL 3-12 FOR THE LIMITS OF THE WATER PLAY AREA). FOR THE BASE BID, THE WATER PLAY AREA SHALL BE BID AS PEDESTRIAN GRADE CONCRETE PER DETAIL 8-9 AND SCORED ALONG AN 8'X8' GRID AS SHOWN ON THIS PLAN.


LEGEND PEDESTRIAN GRADE CONCRETE PAVEMENT SEE DETAIL 8-9. EXPANSION JOINT IN CONCRETE PAVEMENT SEE DETAIL 6-9. ISOLATION JOINT IN CONCRETE PAVEMENT SEE DETAIL 6-9. VEHICULAR GRADE CONCRETE PAVEMENT SEE DETAIL 7-9. PEDESTRIAN GRADE BITUMINOUS CONCRETE PAVEMENT SEE DETAIL 3-9. VEHICULAR GRADE BITUMINOUS CONCRETE PAVEMENT SEE DETAIL 2-9. PLAYGROUND SAFETY SURFACE SEE DETAIL 2—10.

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- VEHICULAR GRADE
BITUMINOUS CONCRETE
DRIVEWAY APRON, SEE
DETAILS 2-9 AND
10-9.

VEHICULAR GRADE BITUMINOUS CONCRETE PAVEMENT, SEE DETAIL 2-9.



BAYER ASSOCIATES

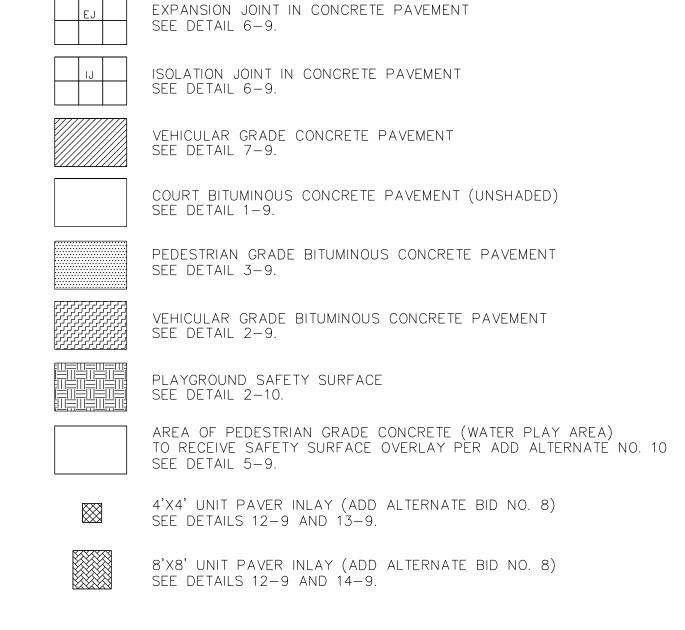ANDSCAPE ARCHITECTURE and PLANNING

Bureau of Engineering Services

City of Rochester, New York

Architect Jeffery J. Mroczek

Joann D. Beck, RLA

 Scale:
 1"=20" (or as noted)

 Checked By:
 MHB

 Drawn By:
 RHW


 Design By:
 Bayer Assoc.

 Date:
 7/15/02


 Project No:
 20042

 No.
 Revisions

SITE IMPROVEMENTS
GRADING PLAN

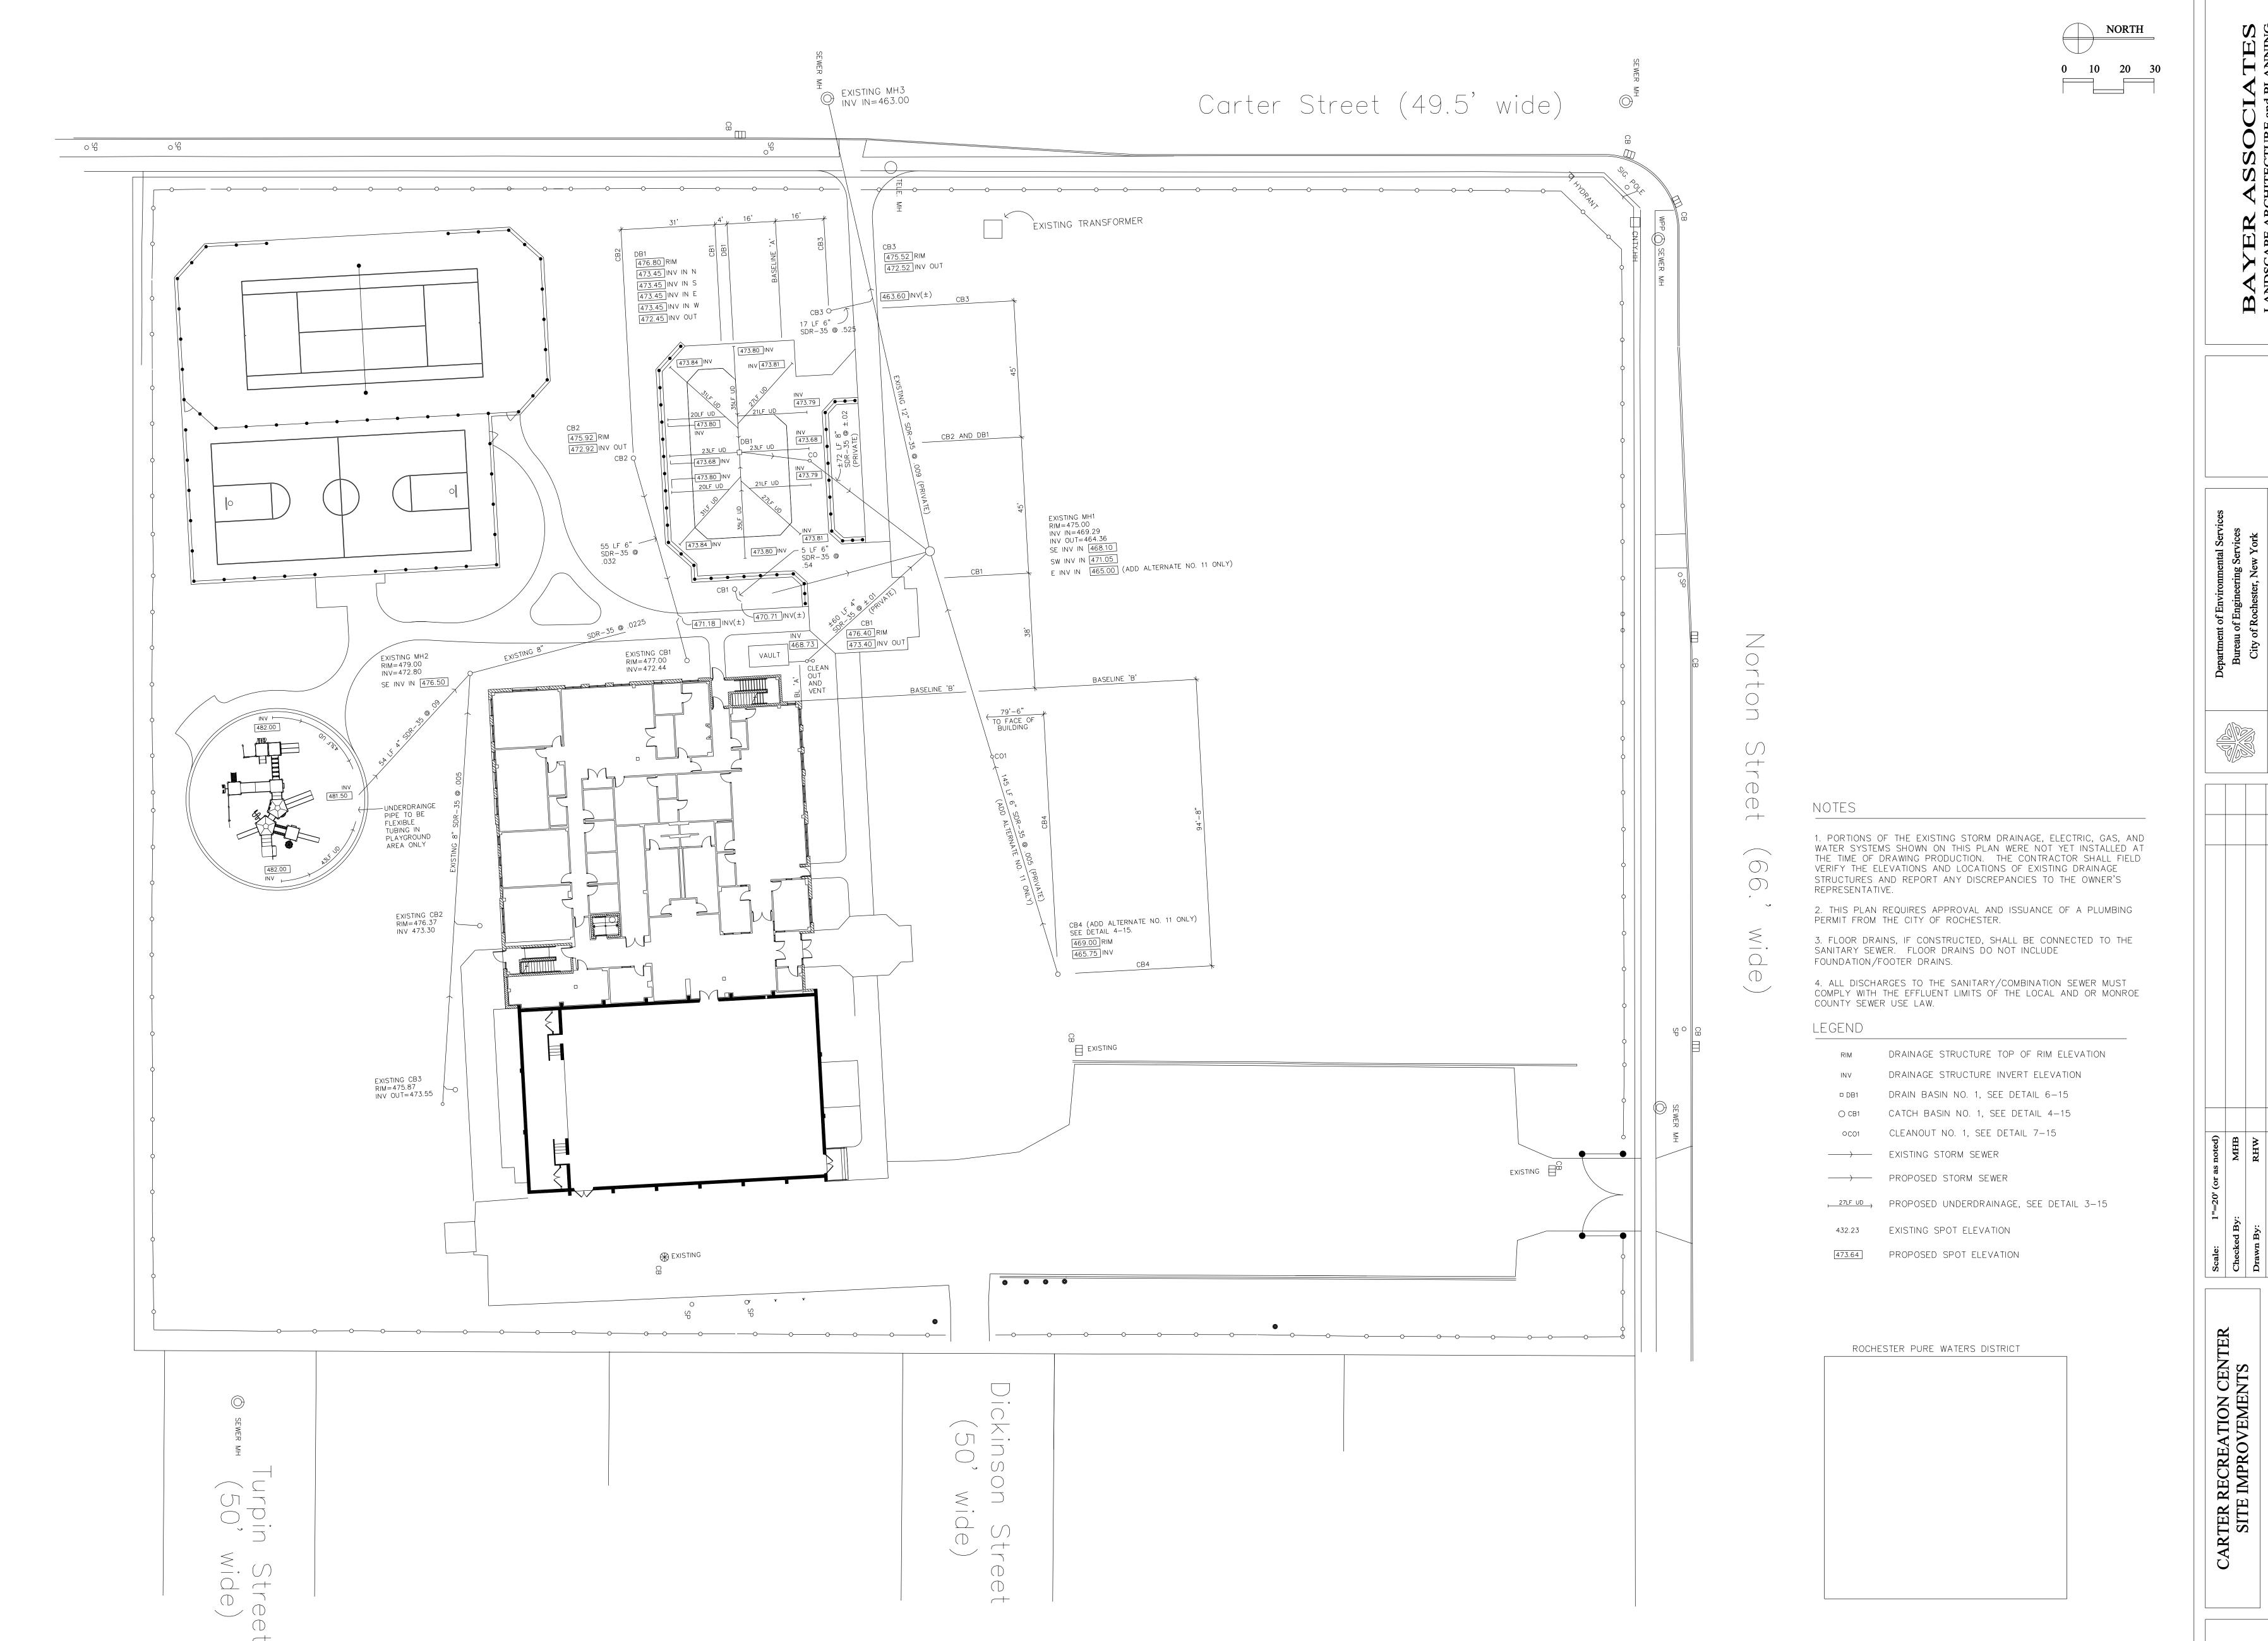

of 18

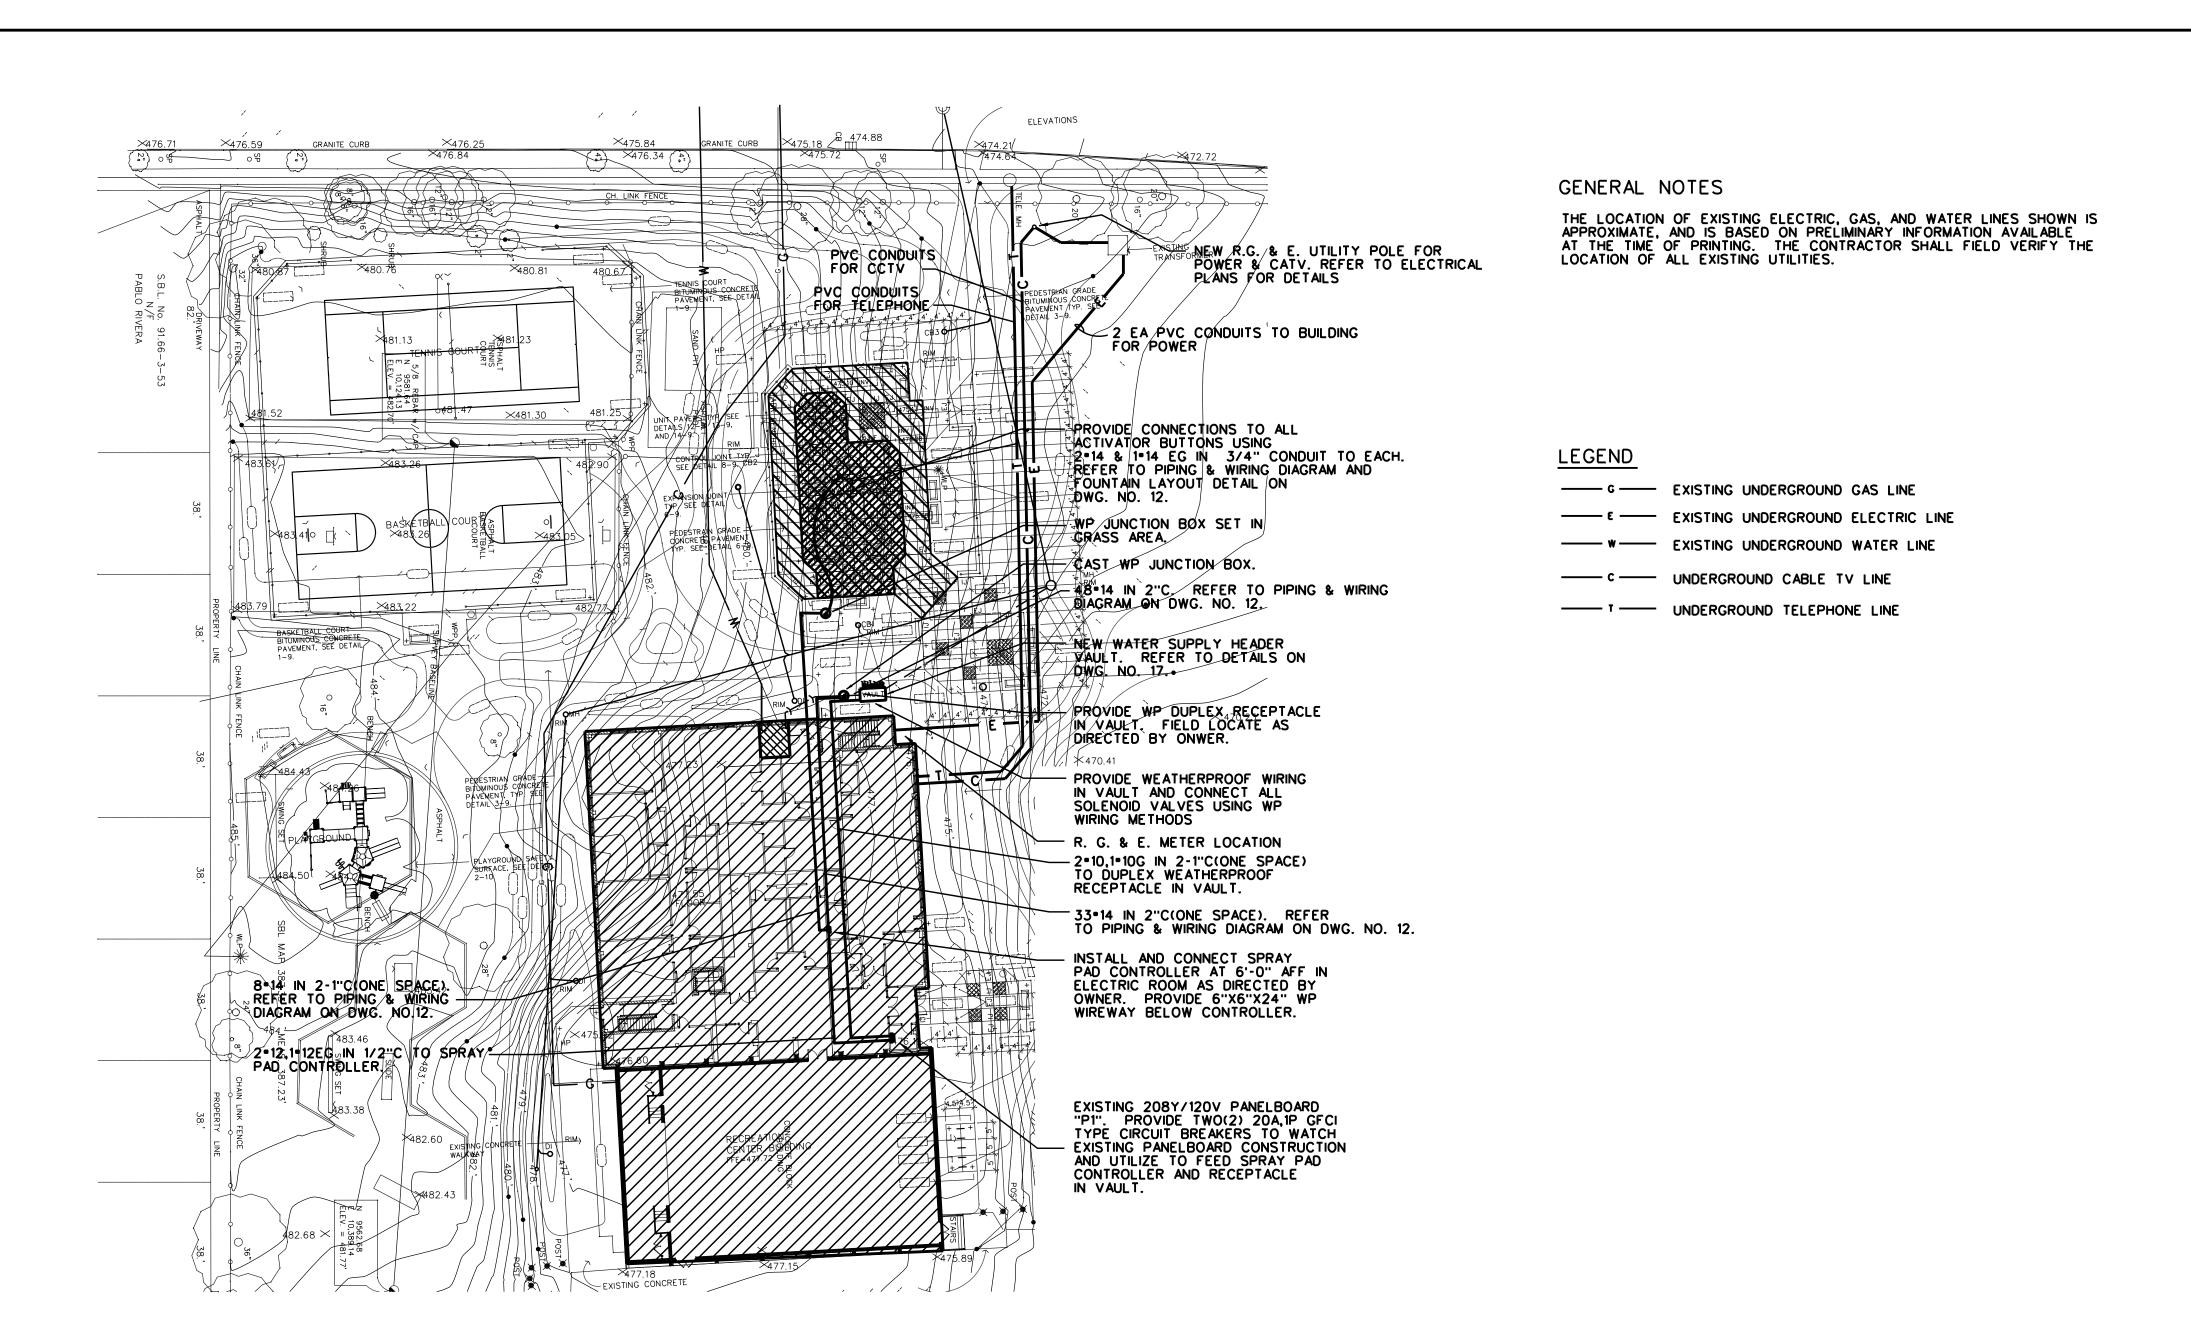

1 SITE PLAN- ELECTRICAL WORK NORTH

7 NOT TO SCALE

ENGINEERING P.C.

M/E *010290

MECHANICAL/ELECTRICAL
ENGINEERING CONSULTANTS

tent of Environmental Services

au of Engineering Services

of Rochester, New York

Jeffery J. Mroczek

Joann D. Beck, RLA


George H. Stam, PE


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Project Landscape Archi


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 As Noted
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CARTER RECREATION CENTER
SITE IMPROVEMENTS




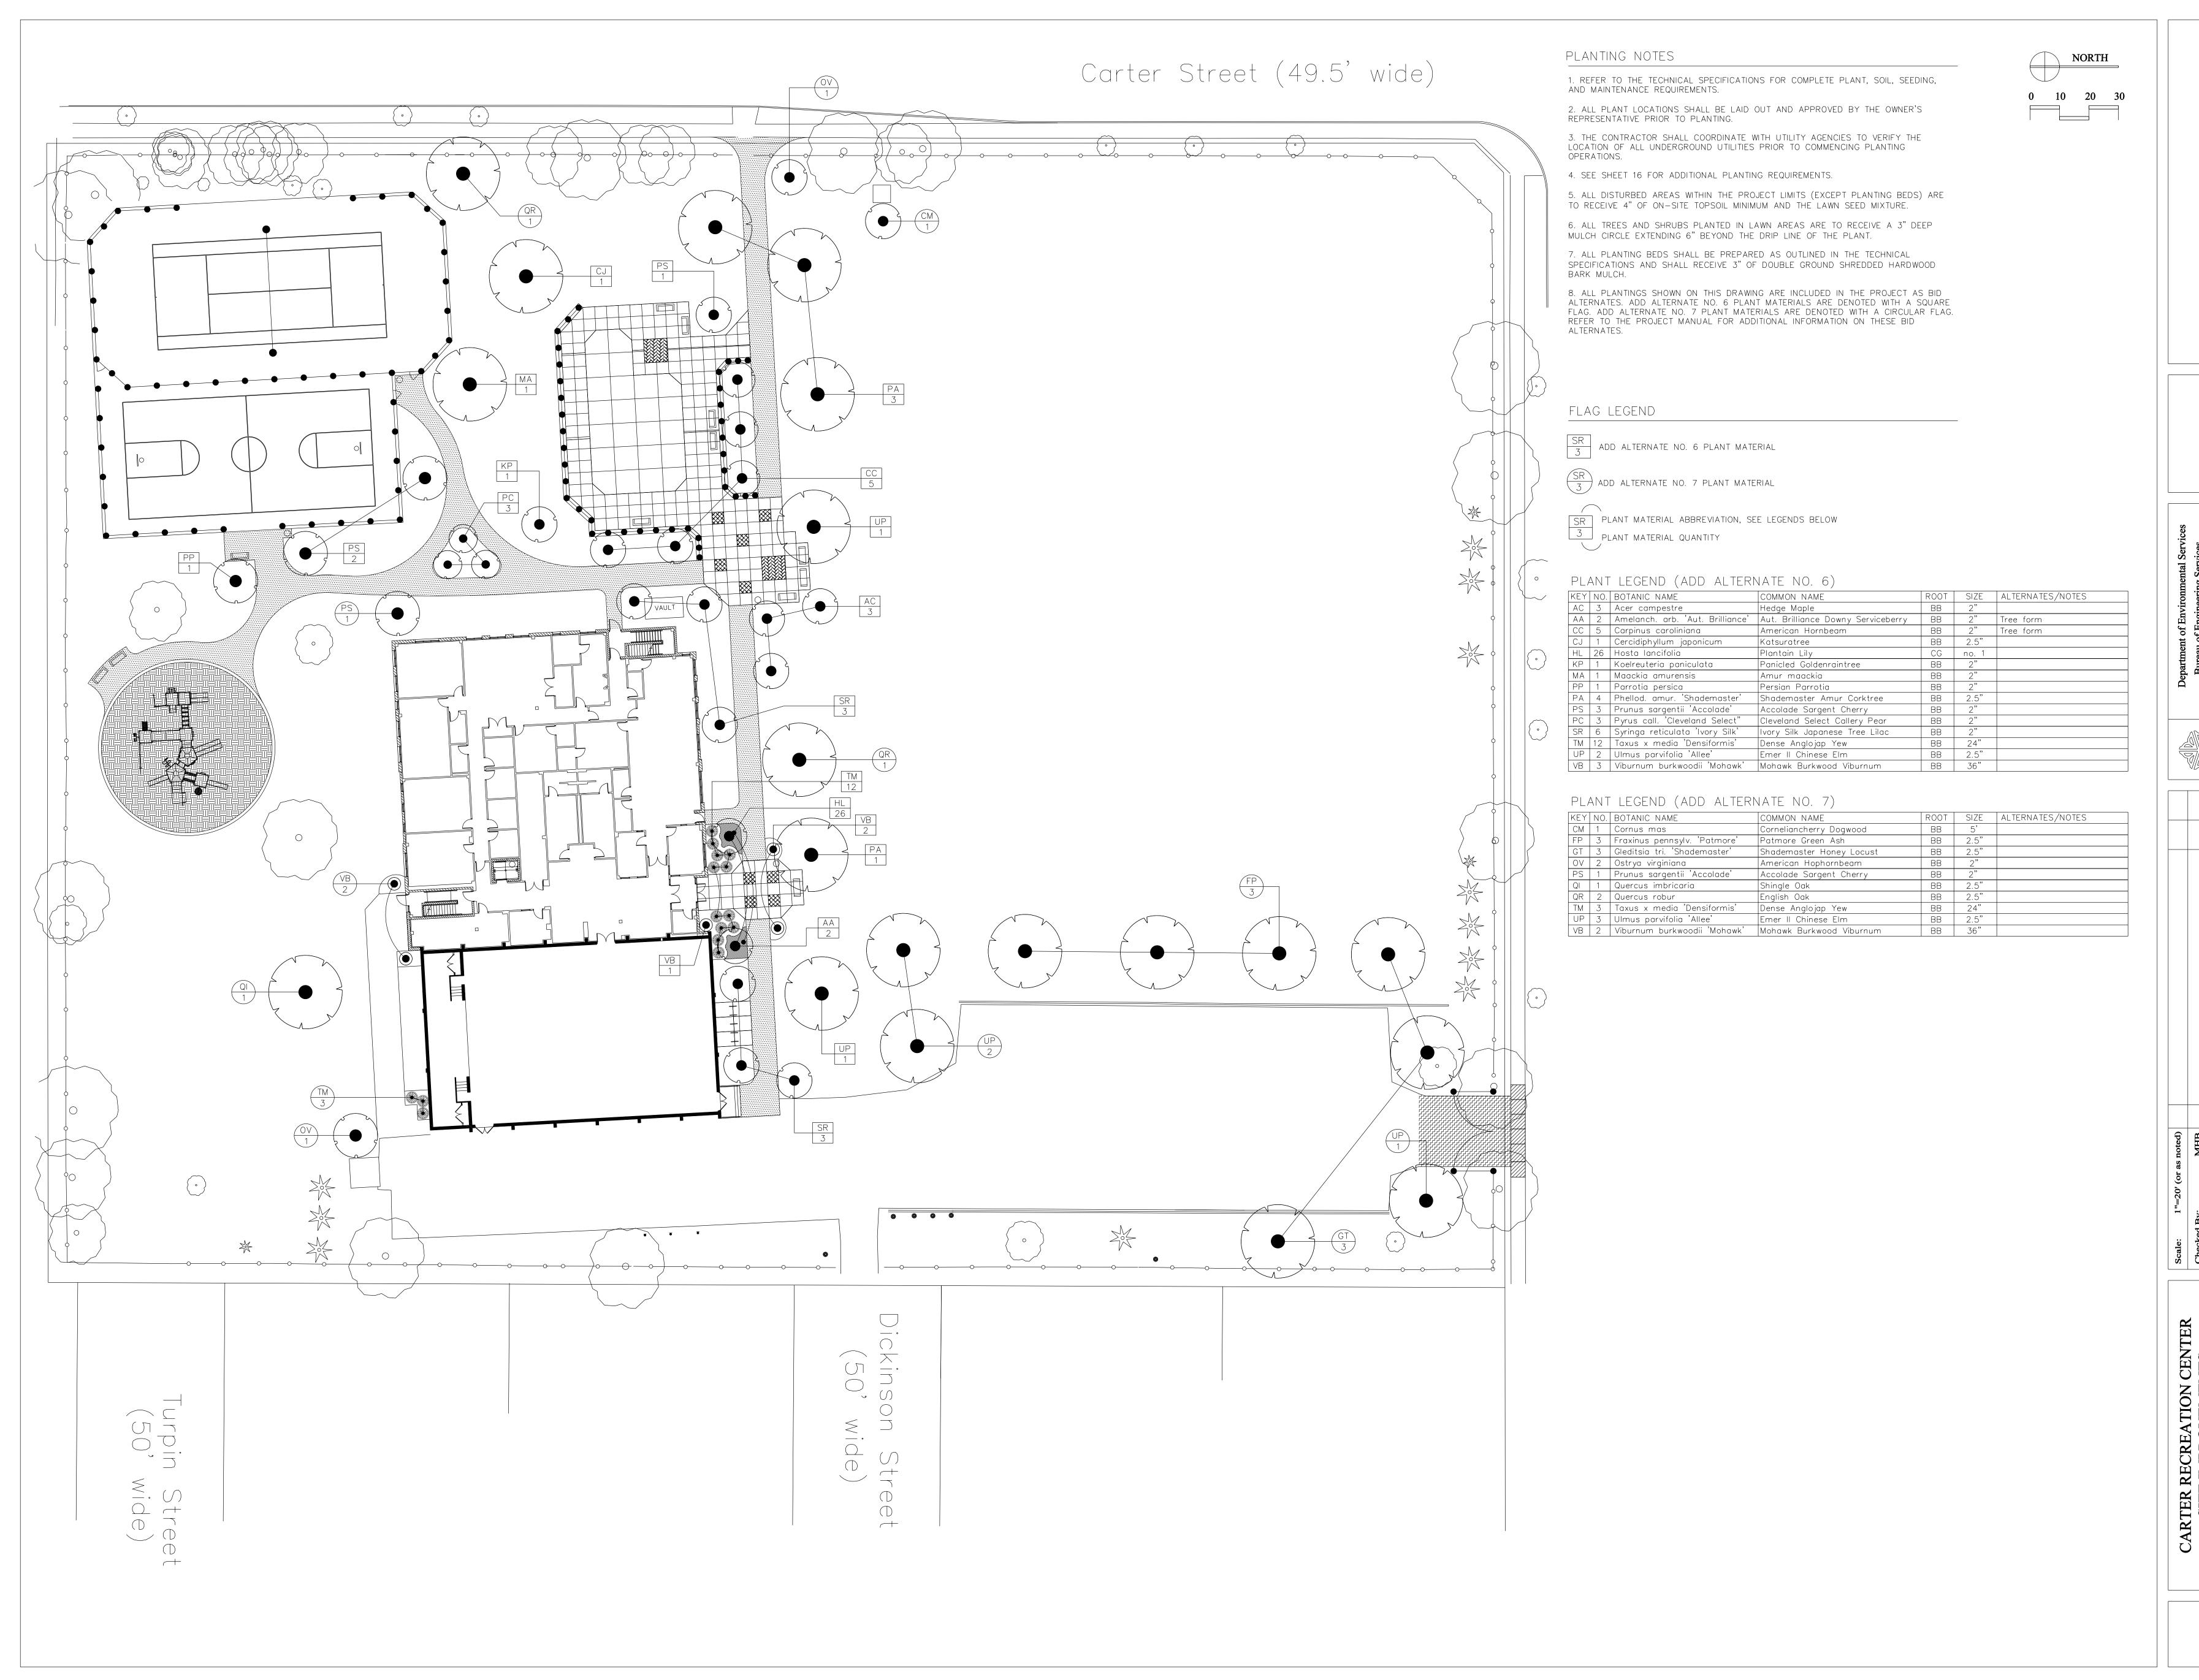

1 BITUMINOUS CONCRETE - COURTS
9 NOT TO SCALE

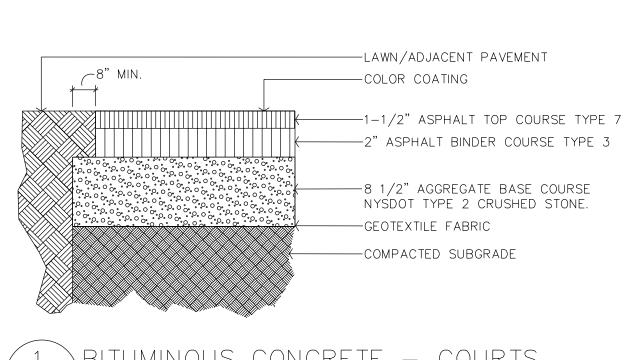

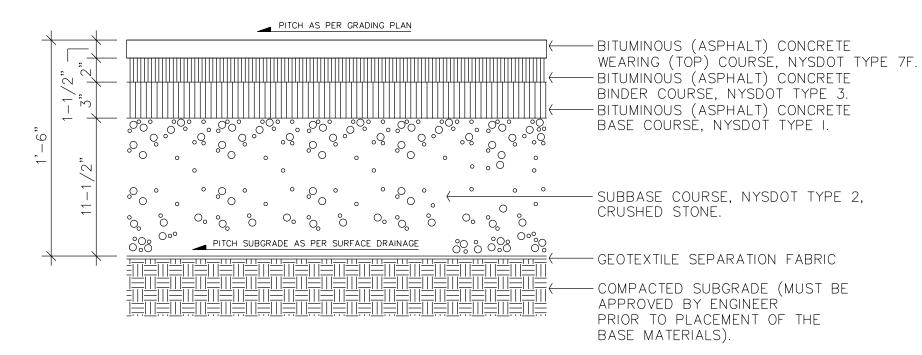2 BITUMINOUS CONCRETE — DRIVEWAY
9 SCALE: 1-1/2" = 1'-0"

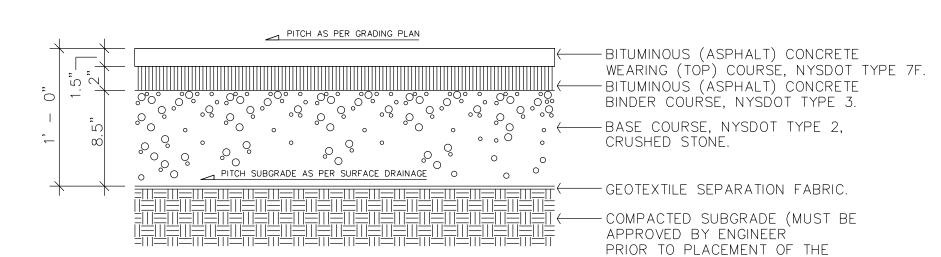

BASE MATERIALS).

3 BITUMINOUS CONCRETE — WALKWAYS
9 NOT TO SCALE

EXIST. PAVEMENT, 12" MIN. LAP JOINT , NEW PAVEMENT

NOTES:

1. UTILIZE THIS DETAIL WHEREVER NEW BITUMINOUS CONCRETE (ASPHALT) PAVEMENT ABUTS EXISTING BITUMINOUS CONCRETE PAVEMENT.


2. SAW CUT EXISTING PAVEMENT AT PROPOSED JOINT AND MILL DOWN TOP COURSE TO

RECEIVE NEW LAP JOINT PAVEMENT AS SHOWN.

3. SEE DETAILS 2-9 AND 3-9 FOR ADDITIONAL REQUIREMENTS FOR BITUMINOUS CONCRETE PAVEMENT.

4 BITUMINOUS CONCRETE (ASPHALT) LAP JOINT
9 NOT TO SCALE

SAFETY SURFACE—SPRAY PAD

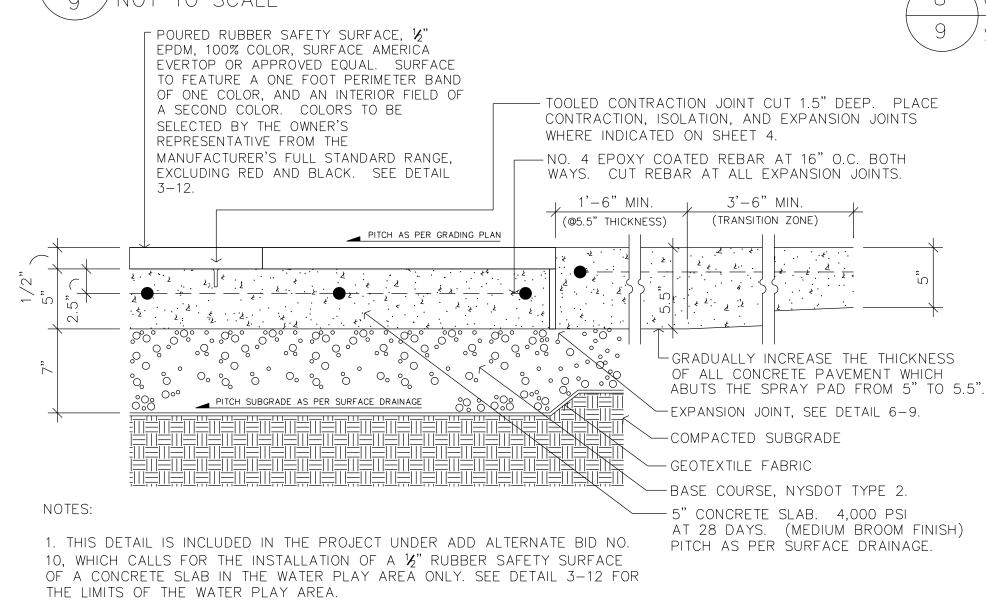

NO. 4 EPOXY COATED REBAR @ 16" O.C. BOTH WAYS. CUT REBAR AT EXPANSION JOINTS 2" CLEAR FROM 1'-0" MIN. 1'-0" MIN. THE EDGE OF THE CONCRETE SLAB -1/2" EXPANSION JOINT WITH A RESILIENT 1/4" RAD. — PREMOLDED NON-EXTRUDING FIBER EXPANSION JOINT FILLER, RECESSED AND SEALED. RECESS FORMED WITH EXTRUDED PVC CAP WITH REMOVABLE TOP TO RECEIVE JOINT SEALANT (COLOR TO MATCH CONCRETE PAVEMENT. ·1/2" DIA. X 24" MIN. (LENGTH) STAINLESS STEEL DOWEL AND SLEEVE ASSEMBLY. PLACE DOWEL AND SLEEVE ASSEMBLY AT 24" O.C. TYP ALONG THE CENTER LINE OF THE CONCRETE SLAB (SLAB DEPTH/2). - CONCRETE SLAB AS SPECIFIED

EXPANSION JOINTS SHALL BE PLACED AS INDICATED ON SHEET 4.
 ISOLATION JOINTS SHALL BE DETAILED AS PER THE EXPANSION JOINTS EXCEPT THAT THEY WILL NOT HAVE THE STAINLESS STEEL DOWEL AND SLEEVE ASSEMBLY. ISOLATION JOINTS WILL BE PLACED AS INDICATED ON THE CONCRETE SCORING PLAN. ISOLATION JOINTS WILL BE USED

WHEREVER CONCRETE PAVEMENT ABUTS BUILDING WALLS, STAIRS, RAMPS, UTILITY STRUCTURES, ETC.

REMOVABLE PVC CAP, FILL VOID
WITH JOINT SEALANT


EXTRUDED PVC EXPANSION JOINT
FILLER VOID CAP


EXPANSION JOINT FILLER

ENLARGED VIEW

6 CONCRETE EXPANSION JOINT DETAIL

9 NOT TO SCALE

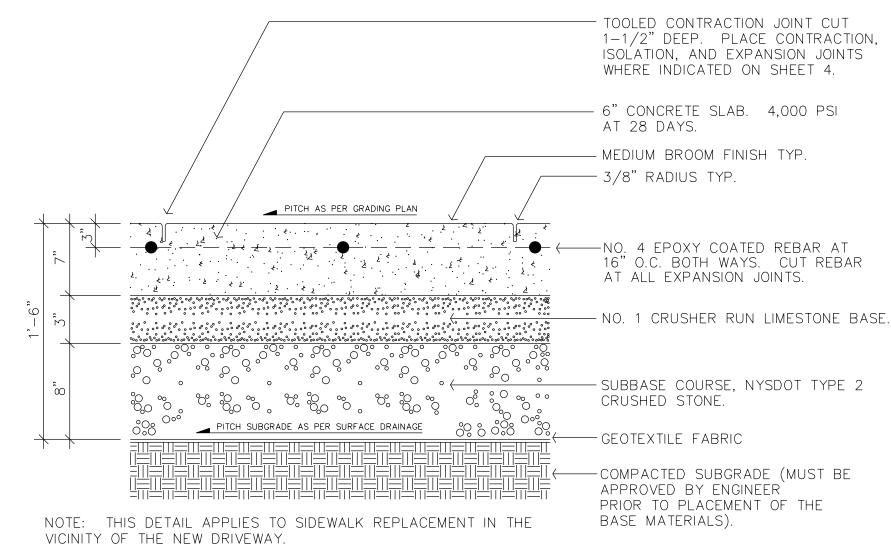


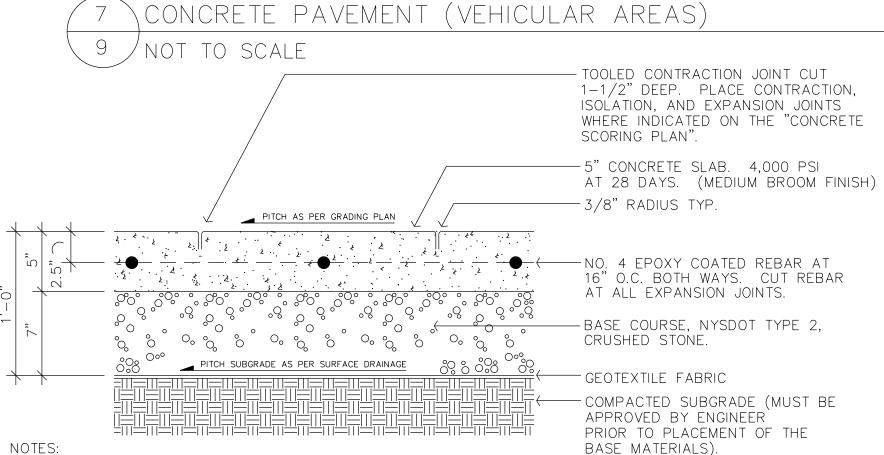

1. UNDER ADD ALTERNATE NO. 9, FOR CONCRETE PAVEMENT WITHIN THE WATER PLAY AREA ONLY (SEE DETAIL 3-12 FOR LIMITS OF THE WATER PLAY AREA), A COLORING AGENT SHALL BE ADDED TO THE CONCRETE MIX. PIGMENT TO BE SELECTED BY THE OWNER'S REPRESENTATIVE FROM THE MANUFACTURER'S SUBTLE AND STANDARD COLOR GROUPS WITH A NOT TO EXCEED DOSAGE OF 2 LBS. OF PIGMENT PER 94 LBS. OF CEMENT, AS MANUFACTURED BY DAVIS COLORS OR AN APPROVED EQUAL.

2. UNDER DEDUCT ALTERNATE NO. 2, THE STEEL RENFORCEMENT SHOWN IN THIS DETAIL SHALL BE ELIMINATED FROM ALL CONCRETE PAVEMENT EXCEPT FOR THE WATER PLAY AREA. SEE DETAIL 3—12 FOR THE LIMITS OF THE WATER PLAY AREA.

8 CONCRETE PAVEMENT (PEDESTRIAN AREAS)
9 SCALE: 1-1/2" = 1'-0"

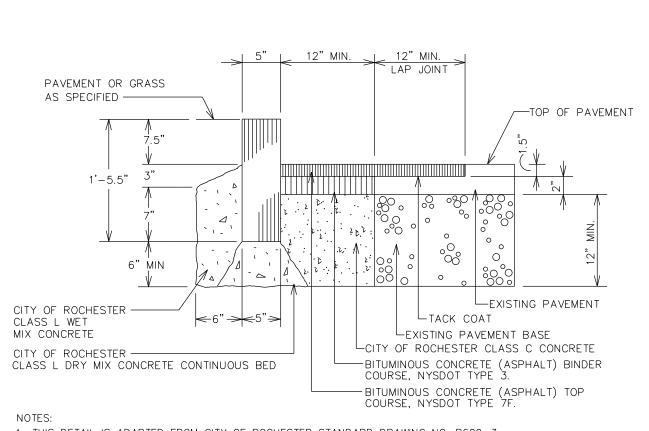


NOTES:

1. THIS DETAIL IS ADAPTED FROM CITY OF ROCHESTER STANDARD DRAWING NO. R609-3.

2. REFER TO DETAIL 4-9 FOR ADDITIONAL LAP JOINT INFORMATION.

3. THIS DETAIL APPLIES TO CURBING INSTALLED ADJACENT TO EXISTING PAVEMENTS.

9 GRANITE CURE 9 NOT TO SCALE

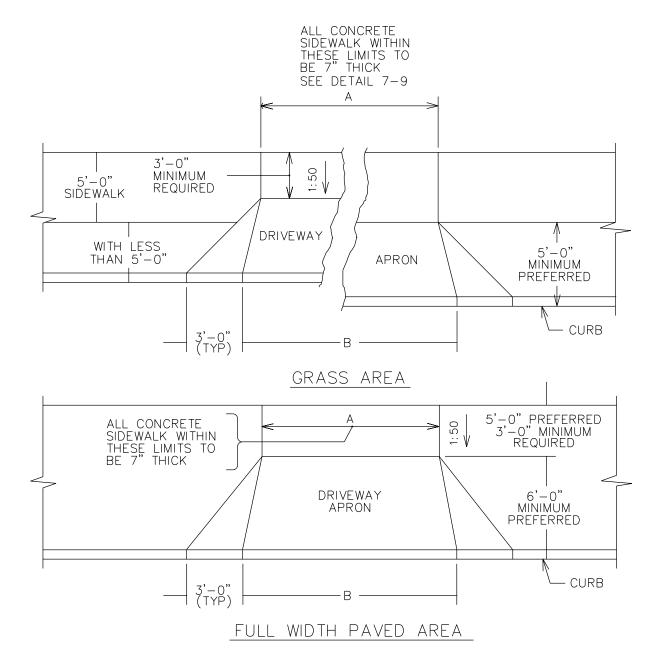

TOP OF CURB

TRANSITION CURB

HEADER CURB


1 1/2 " 7 1/4 "

CURB

TOP OF PAVEMENT

ELEVATION

10 DRIVEWAY APRON WITH OPTIONAL FLARE
9 NOT TO SCALE

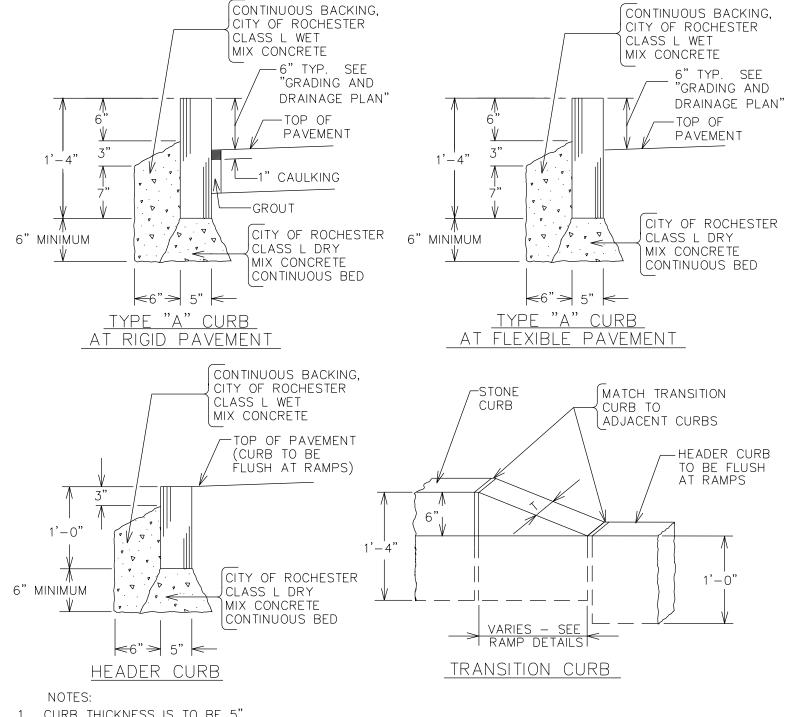


CURB THICKNESS IS TO BE 5"
 PROVIDE 0" CURB REVEAL FOR HEADER CURB AT RAMPS.
 REFER TO SHEET 5 FOR INFORMATION ON CURB ELEVATIONS.

4. WHERE NEW CURBS ARE PLACED ADJACENT TO EXISTING PAVEMENT, USE A LAP JOINT PER DETAILS 4—9 AND 9—9.

5. ADAPTED FROM CITY OF ROCHESTER STANDARD DETAIL DRAWING NO. R609—1.

11 STONE CURB DETAILS (GENERAL)
9 NOT TO SCALE

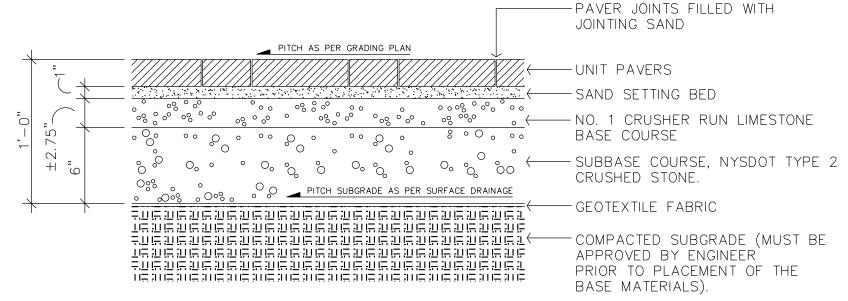


NOTES:

1. THIS DETAIL IS INCLUDED IN THE PROJECT UNDER ADD ALTERNATE NO. 8. SEE THE PAVING PLAN FOR LIMITS OF UNIT PAVERS UNDER ALTERNATE NO. 8.

2. UNIT PAVERS TO BE 3.97"x7.91"x2.36" AS MANUFACTURED BY LAFARGE CANADA OR APPROVED EQUAL. COLOR TO BE SELECTED FROM THE MANUFACTURER'S FULL RANGE OF STANDARD COLORS.

12 UNIT PAVERS
9 NOT TO SCALE

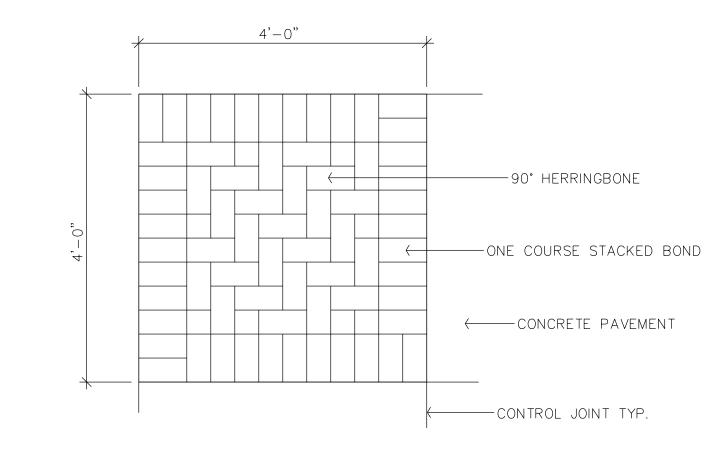


NOTES:

1. THIS DETAIL IS INCLUDED IN THE PROJECT UNDER ADD ALTERNATE NO. 8. SEE THE PAVING PLAN FOR LIMITS OF UNIT PAVERS UNDER ADD ALTERNATE NO. 8.

2. UNIT PAVERS TO BE 3.97"x7.91"x2.36" AS MANUFACTURED BY LAFARGE CANADA OR APPROVED EQUAL. COLOR TO BE SELECTED FROM THE MANUFACTURER'S FULL RANGE OF STANDARD COLORS.

3. MINIMIZE CUTS WHEREVER POSSIBLE.

13 4'X4' UNIT PAVER INLAY TYP. 9 SCALE: 3/4" = 1'-0"

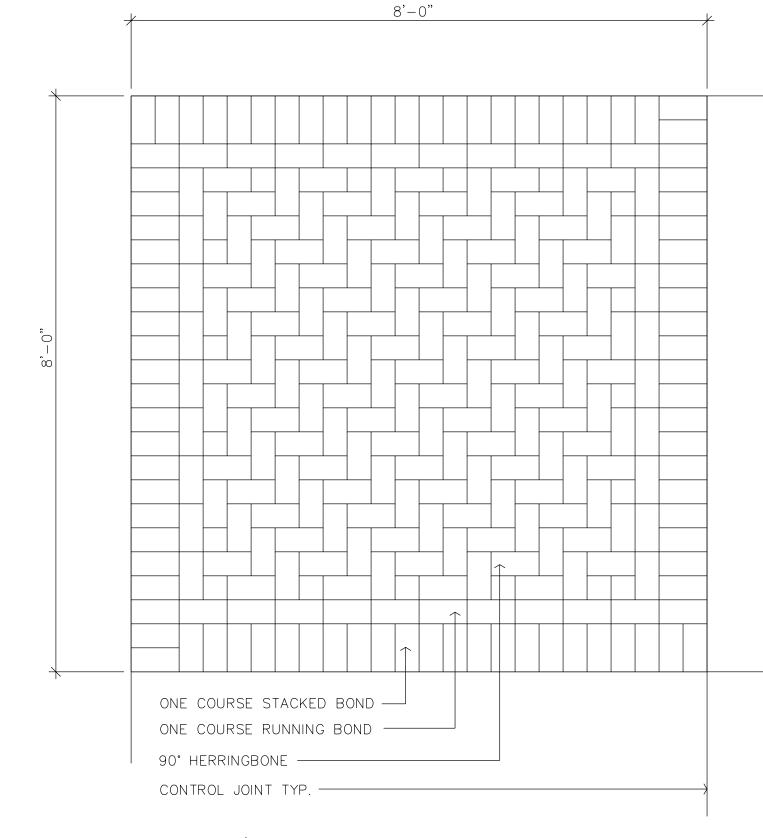

CONCRETE PAVEMENT

NOTES:

1. THIS DETAIL IS INCLUDED IN THE PROJECT UNDER ADD ALTERNATE NO. 8. SEE THE PAVING PLAN FOR LIMITS OF UNIT PAVERS UNDER ADD ALTERNATE NO. 8.


2. UNIT PAVERS TO BE 3.97"x7.91"x2.36" AS MANUFACTURED BY LAFARGE CANADA OR APPROVED EQUAL. COLOR TO BE SELECTED FROM THE MANUFACTURER'S FULL RANGE OF STANDARD COLORS.

3. MINIMIZE CUTS WHEREVER POSSIBLE.

9 SCALE: 3/4" = 1'-0"

Ħ,



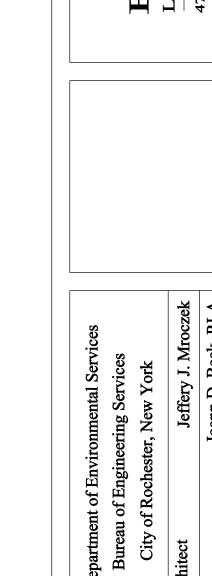


کر	Department of Environmental	nmental
	Bureau of Engineering Serv	ing Serv
	City of Rochester, New Y	New Y
t Lands	t Landscape Architect	Jeffery
) ui Je	er in Charge	Joann D.



					By	
					Revisions	
					No.	
(as noted)	: MHB	RHW	Bayer Assoc.	7/15/02	20042 No.	

SITE IMPROVEMENTS	PLAYGROUND DETAILS
,	

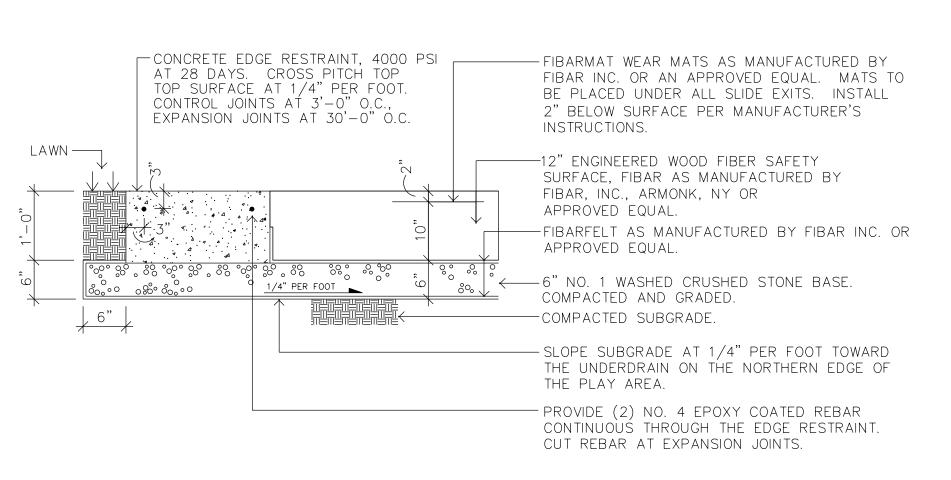

1. THE FINISHED GRADE OF THE FIBAR MATERIAL SHOULD BE SEVERAL INCHES ABOVE FINISH GRADE OF THE EDGE RESTRAINT AT THE TIME OF INSTALLATION, UNTIL IT COMPACTS. FEATHER THE EDGES TO MAKE A SMOOTH TRANSITION TO THE CONCRETE EDGE RESTRAINT.

2 WOOD FIBER SAFETY SURFACE AND CONCRETE EDGE RESTRAINT
10 NOT TO SCALE

PLAY STRUCTURE 'G' TYPE FOOTING, SEE DETAIL 1-10 1. SEE THE SPECIFICATIONS FOR PLAY STRUCTURE COMPONENT SCHEDULE.

³ 10051

10543

FUNNEL

ENCLOSURE

18112

1' TRANSITION

STEP LINK

17201 STAINLESS STEEL DOUBLE

CHUTER SLIDE

A RUNG LADDER

10087 CHINNING BAR SINGLE

CRUNCH

WAVY TREE CLIMBER

17141

DOUBLE STEERING /A WHEEL ENCLOSURE /

STAINLESS STEEL STRAIGHT

CHUTER SLIDE

18006 TRANSFER PLATFORM

w/BARRIER

15017

PENTAGONAL DECK

18013 FUNNEL BRIDGE w/BARRIER RAIL

17140 CLOVER LEAF CLIMBER

STAINLESS STEEL STRAIGHT CHUTER SLIDE

10947

BARRIER

ENCLOSURE

RUNG LADDER

18047 TRANSITION STEP

CARGO NET WALL

\A STRAIGHT FAT

ARCH BRIDGE

18062

10728 CHALLENGE CANYON BRIDGE

TREESCAPE DECK PERF METAL ROOF

ACCESSIBLE STEPS

w/BARRIER RAIL A/T

STAINLESS STEEL DOUBLE

CHUTER SLIDE

PIPE CLIMBER

PLAY STRUCTURE 'A' TYPE FOOTING TYP. SEE DETAIL 1-10

THESPIAN THEATER

PANEL

METAL
STOREFRONT 10485
PANEL MAZE TIME

BARRIER ENCLOSURE

PANEL

LEANING WALL

CLIMBER


10619

3 PLAY STRUCTURE COMPONENT DIAGRAM 10 NOT TO SCALE

1 \PLAY STRUCTURE FOOTER

10 NOT TO SCALE

FOOTINGS TABLE TYPE | DIAMETER | DEPTH A 1'-8" 4'-0" B 1'-2" 4'-0"
G 4'-0" 4'-0" NOTES: 1. THIS DETAIL IS ADAPTED FROM GAMETIME STANDARD DETAIL NO. 005. 2. FOOTER LAYOUT WILL BE PROVIDED BY GAMETIME AT TIME OF PURCHASE.

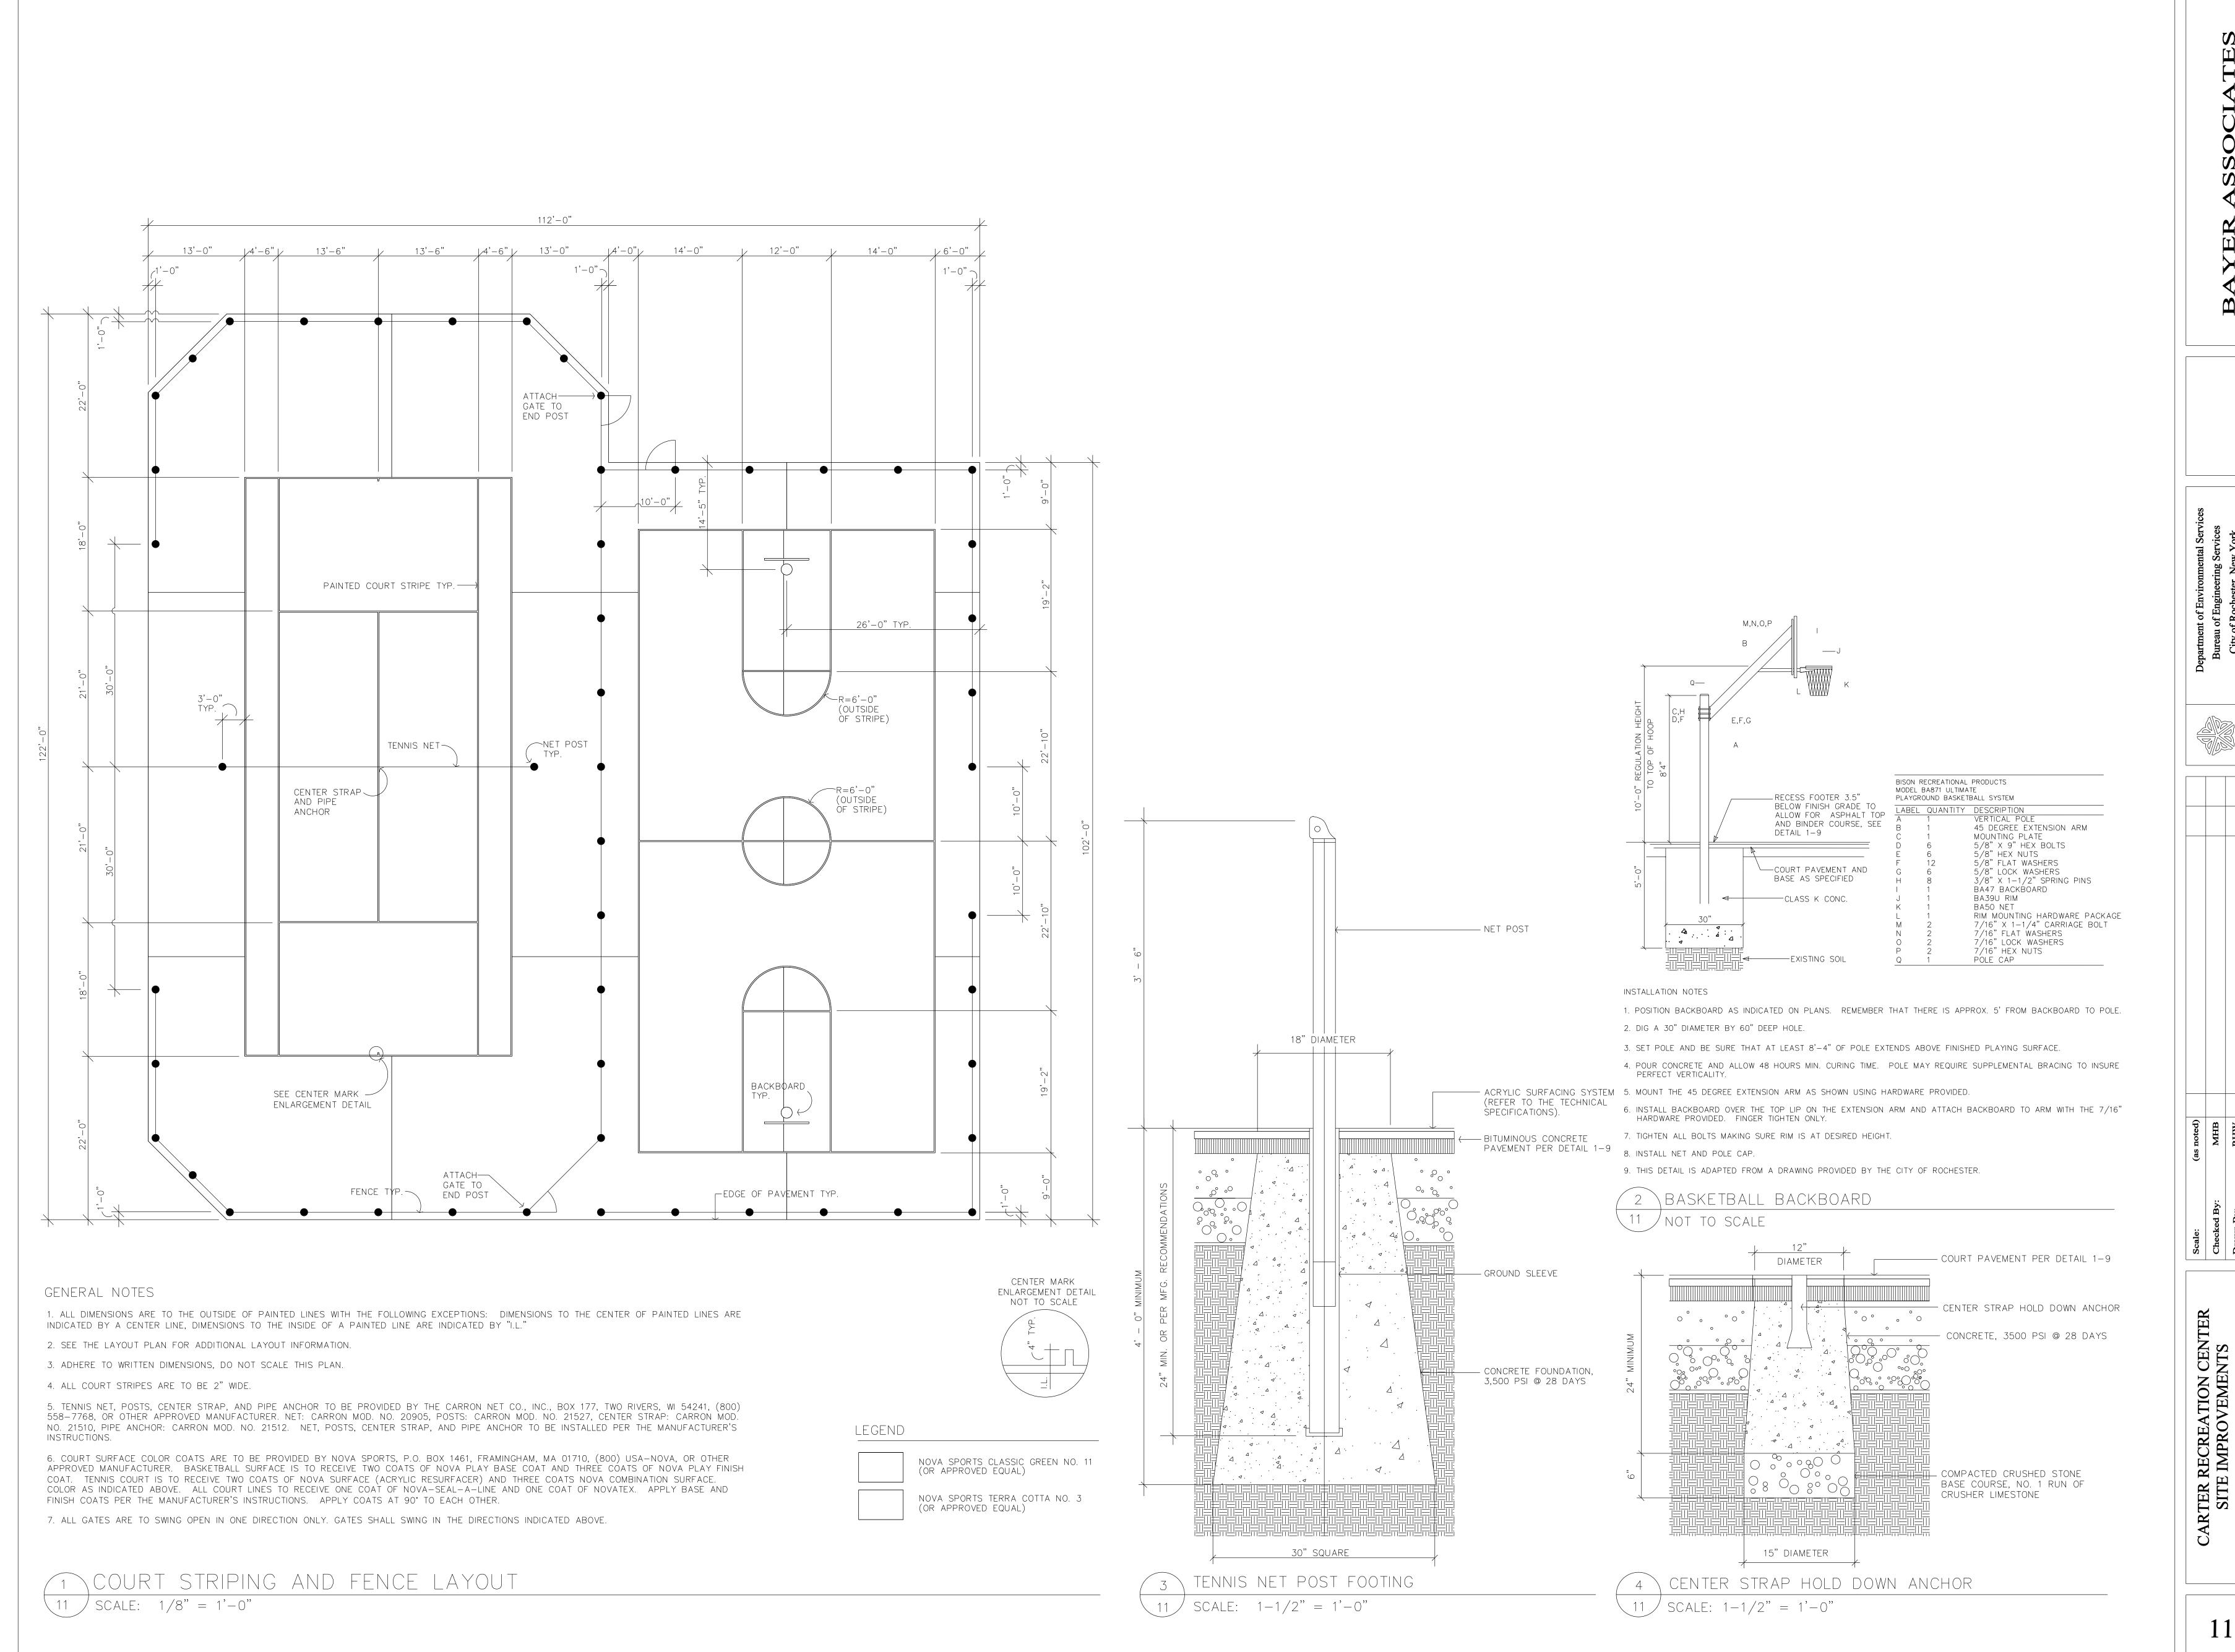

of 18

32'-0"

LEGEND


- A WATER JET (ARCHED) WATER ODYSSEY "AQUA ARCH" OR APPROVED EQUAL
- B GROUND SPRAY WATER ODYSSEY "DADDY LONG LEGS" OR APPROVED EQUAL
- C water jet (vertical) water odyssey "jet way" or approved equal
- D BOLLARD FOUNTAIN WATER ODYSSEY "MUSHROOM MAZE" OR APPROVED EQUAL
- E CANE FOUNTAIN WATER ODYSSEY "STEP N' WHOOSH" OR APPROVED EQUAL
- F COLUMNAR FOUNTAIN WATER ODYSSEY "WATER WHOOPEE" OR APPROVED EQUAL
- G ARCHWAY FOUNTAIN (VERTICAL SPRAY) WATER ODYSSEY "WATER WAY" OR APPROVED EQUAL

NOTES:

1. SEE SHEET 4 (PAVING PLAN) FOR INFORMATION DETAILING THE LAYOUT OF CONCRETE SCORING AND LOCATION OF CONTROL JOINTS.


2. ALL WATER PLAY FEATURES SHALL BE WATER CONSERVING MODELS WHEN THAT OPTION IS AVAILABLE IN THE PRODUCT LINE.


1 FOUNTAIN LAYOUT
12 SCALE: 1/8" - 1'-0"

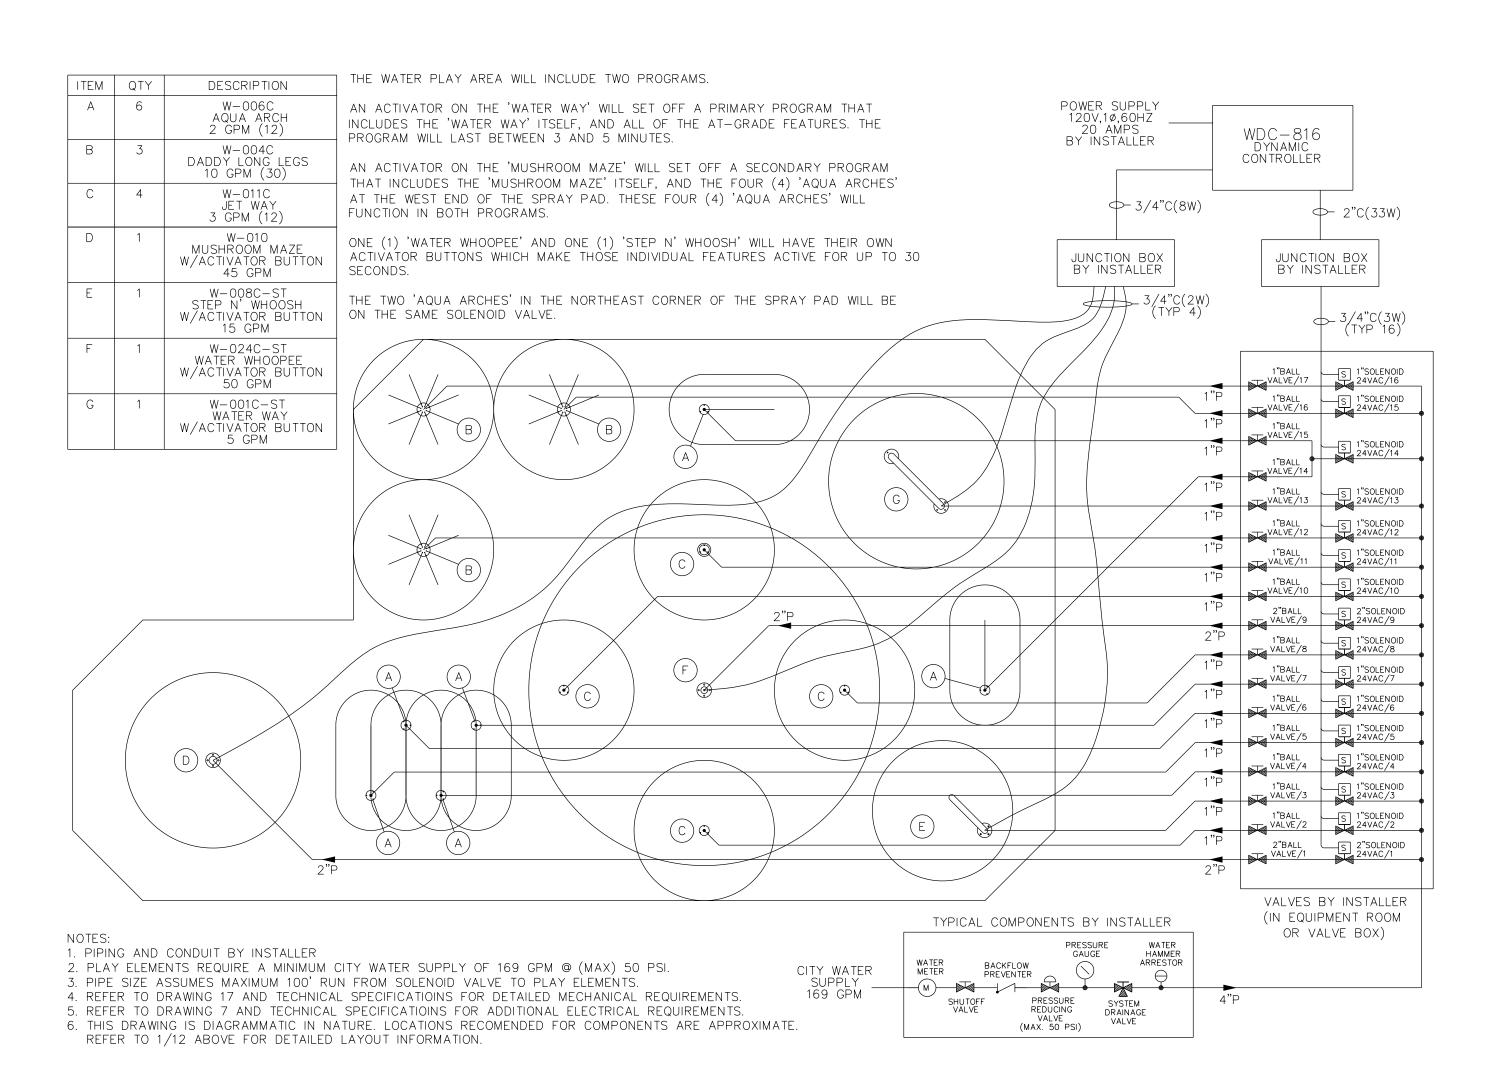

2 PIPING SCHEMATICS

 $\frac{12}{\text{SCALE } 3/16"} = 1$

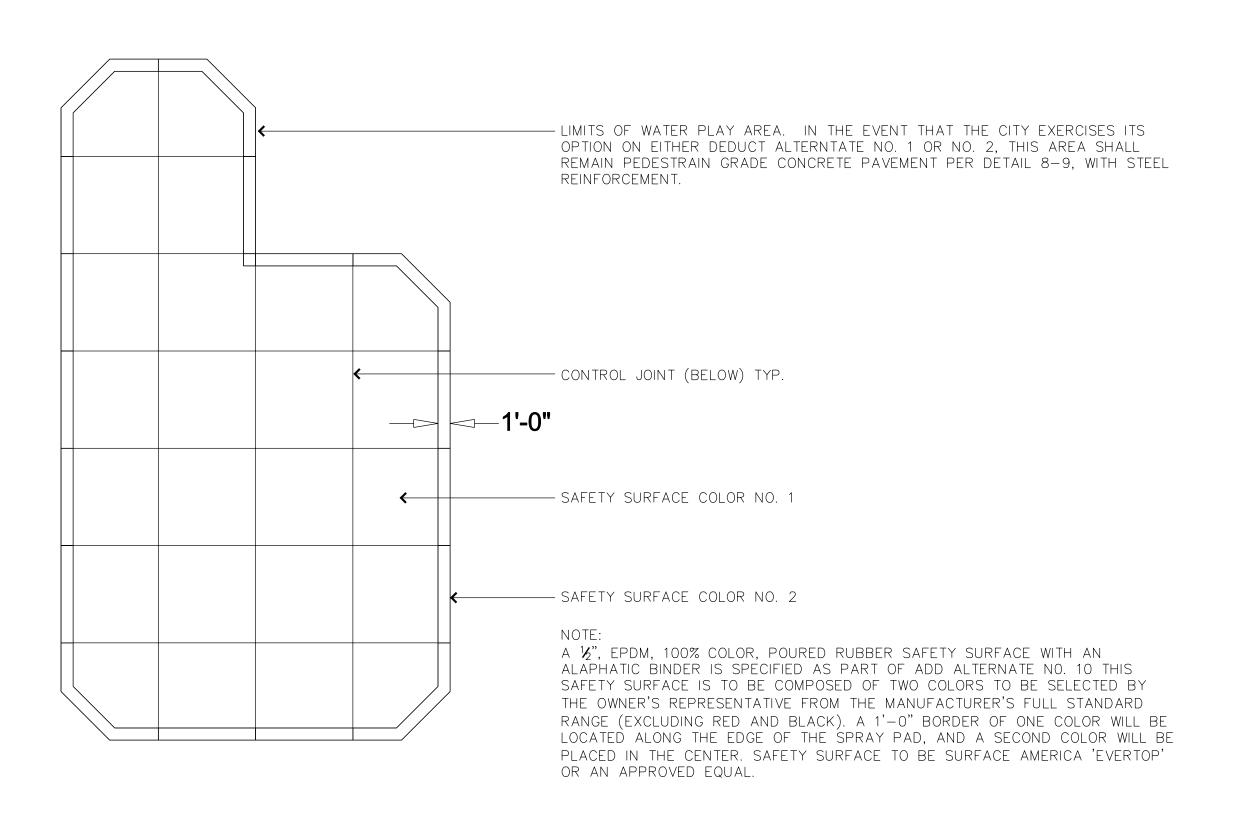

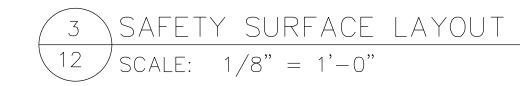

 Rand Drawn By:
 (as noted)
 (as noted)

 Drawn By:
 WRM
 (as noted)

 Drawn By:
 WRM
 (as noted)

 Design By:
 Bayer Assoc.
 (as noted)


 LS 1
 Date:
 7/15/02


 Project No:
 20042
 No.

 Revisions
 Revisions


CARTER RECREATION CENTER
SITE IMPROVEMENTS
AQUATIC PLAYGROUND DETAILS 1



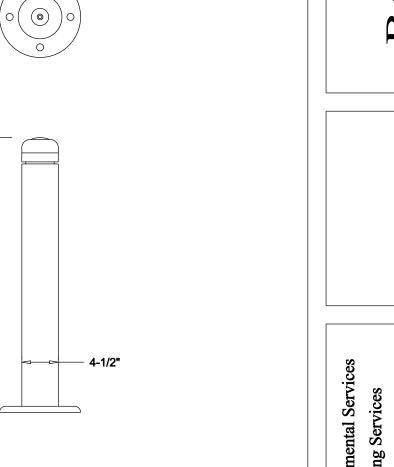

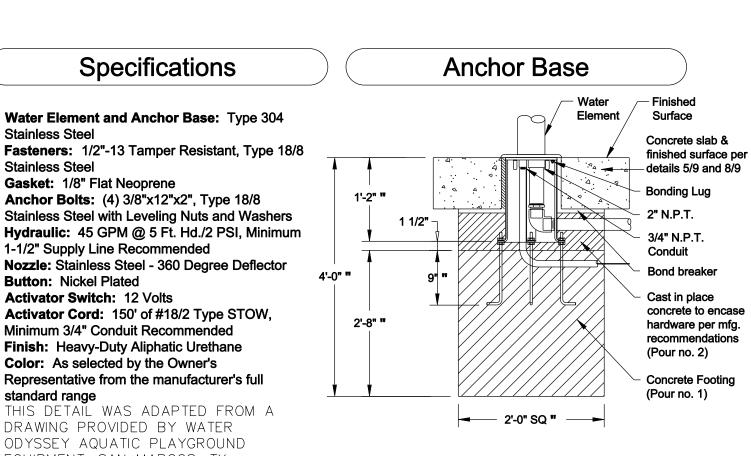

ODYSSEY AQUATIC PLAYGROUND EQUIPMENT, SAN MARCOS, TX. NOTE: BOLLARD FOUNTAIN SHALL BE WATER ODYSSEY "MUSHROOM MAZE" OR APPROVED EQUAL. (D) BOLLARD FOUNTAIN \13 / NOT TO SCALE

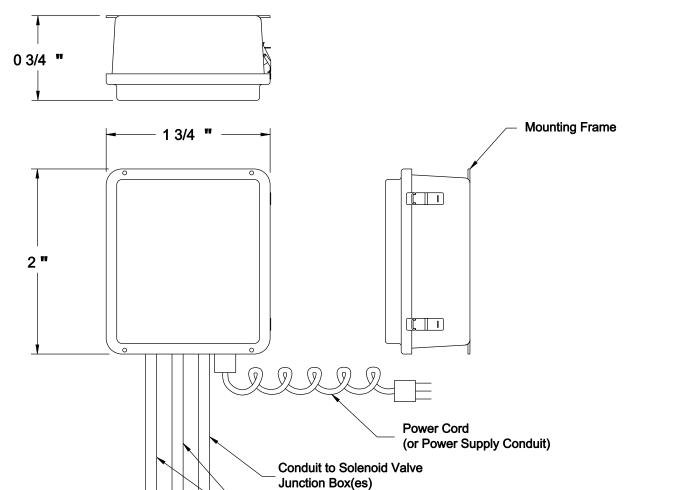

Conduit from Activator

Junction Box(es) Note: Conduit and Wire By Installer **Specifications**

Splash Zone

Specifications

Anchor Bolts: (4) 3/8"x12"x2", Type 18/8

Activator Cord: 150' of #18/2 Type STOW,

Minimum 3/4" Conduit Recommended

Finish: Heavy-Duty Aliphatic Urethane

Representative from the manufacturer's full

THIS DETAIL WAS ADAPTED FROM A

Color: As selected by the Owner's

DRAWING PROVIDED BY WATER

Stainless Steel

Stainless Steel

Gasket: 1/8" Flat Neoprene

Button: Nickel Plated

Activator Switch: 12 Volts


1-1/2" Supply Line Recommended


10' DIA

Functions: Timed Duration, Dynamic Sequencing and Programmed Sequencing, Field Adjustable **Housing:** NEMA 4X with Lockable Hasp Input Voltage: 120 VAC/60 Hertz, 20 AMPS Output Voltage: 24 VAC/60 Hertz, 150 Max VA Wired Activator Input: 12 VDC Power Cord: 6 Foot, 18-3 Type SJT with Grounded Plug Time Clock: Integral, Electronic, 7 Day, Single Channel, 6 Program Display: LCD Backlit, 4 x 20 Characters Max. # Wireless Activator Inputs: 32 Max. # Wired Activator Inputs: 8 Max. # Solenoid Outputs: 16 Safety: UL Listed

THIS DETAIL WAS ADAPTED FROM A DRAWING PROVIDED BY WATER ODYSSEY AQUATIC PLAYGROUND EQUIPMENT, SAN MARCOS, TX.

8 \FOUNTAIN CONTROL DEVICE \13 / NOT TO SCALE

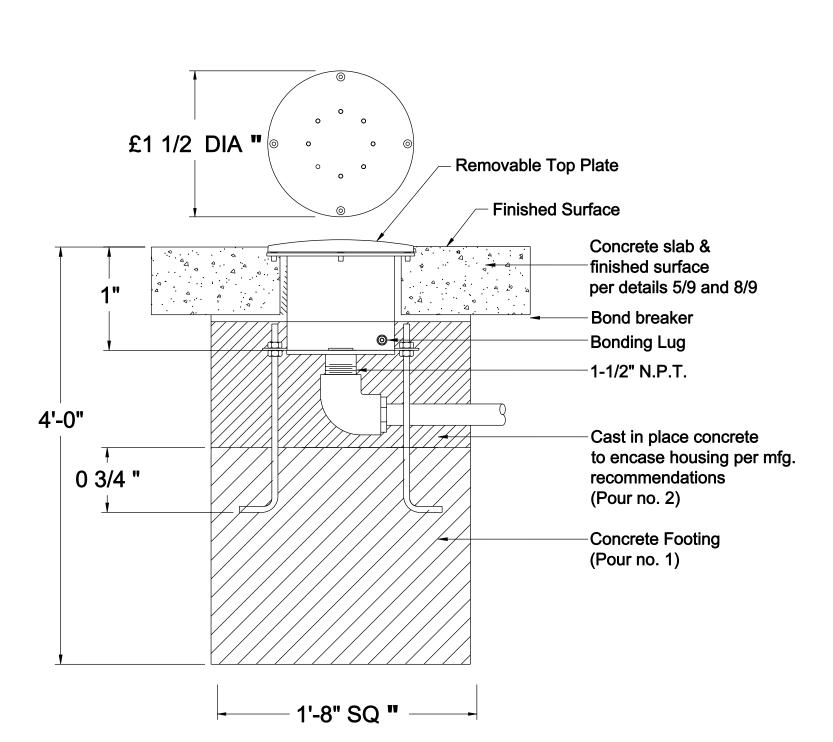

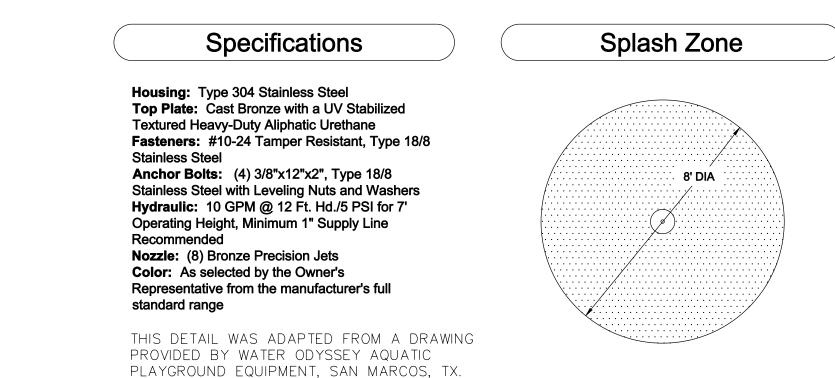

GROUND SPRAY

NOTE: GROUND SPRAYS SHALL BE WATER ODYSSEY "DADDY LONG LEGS" OR APPROVED EQUAL.

3 (C) WATER JET (VERTICAL)

Specifications

Housing: Type 304 Stainless Steel

Top Plate: Cast Bronze with a UV Stabilized

Anchor Bolts: (3) 3/8"x12"x2", Type 18/8

Hydraulic: 3 GPM @ 10 Ft. Hd./4 PSI for 4'

Operating Height, Minimum 1" Supply Line

from the manufacturer's full standard range

Recommended

Nozzle: Brass Aerating Jet

Fasteners: 1/4-20 Tamper Resistant, Type 18/8

Stainless Steel with Leveling Nuts and Washers

Color: As selected by the Owner's Representative


PROVIDED BY WATER ODYSSEY AQUATIC

THIS DETAIL WAS ADAPTED FROM A DRAWING

PLAYGROUND EQUIPMENT, SAN MARCOS, TX.

Textured Heavy-Duty Alphatic Urethane

0 3/4 "

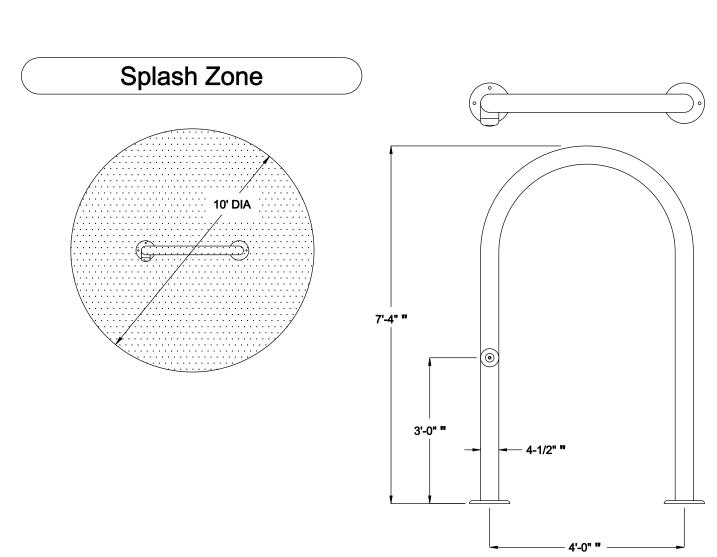

1'-6" SQ ---

NOTE: WATER JETS (VERTICAL) SHALL BE WATER ODYSSEY "JET WAY" OR APPROVED EQUAL.

Removable Top Plate

Finished Surface

Concrete slab &

finished surface

Bond breaker

Bonding Lug

−1" N.P.T.

per details 5/9 and 8/9

Cast in place concrete

recomendations

Concrete Footing


(Pour no. 2)


(Pour no. 1)

Splash Zone


8' DIA


to encase housing per mfg.

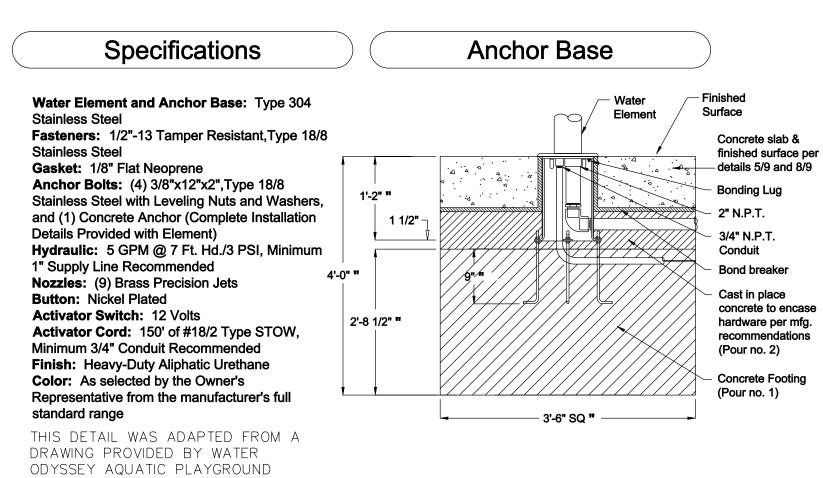

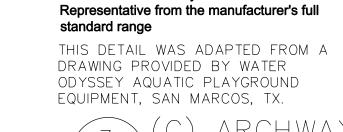

7 (G) ARCHWAY FOUNTAIN (13 / NOT TO SCALE

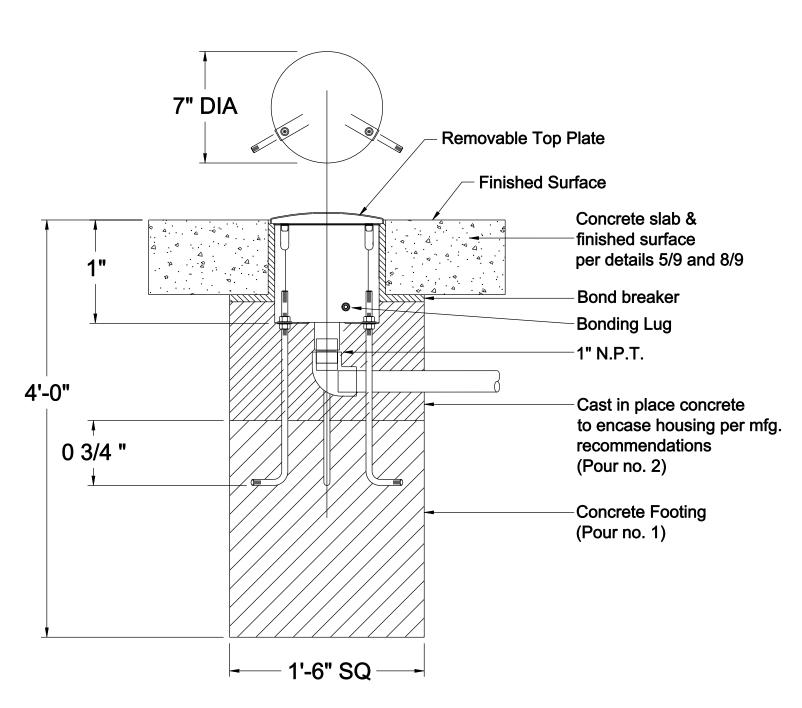


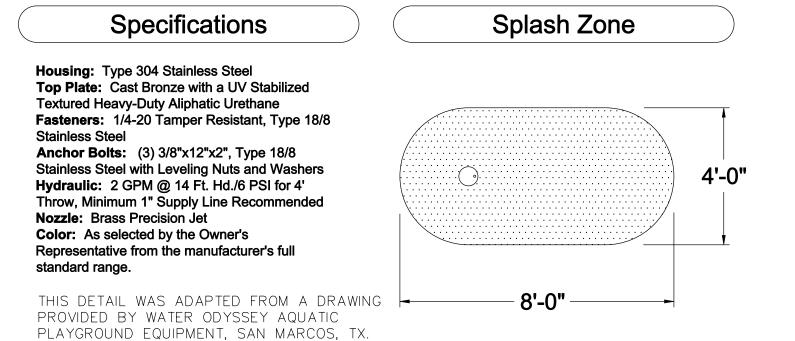


NOTE: WATER JETS (ARCHED) SHALL BE WATER ODYSSEY "AQUA ARCH" OR APPROVED EQUAL.

(A) WATER JET (ARCHED)


13 NOT TO SCALE

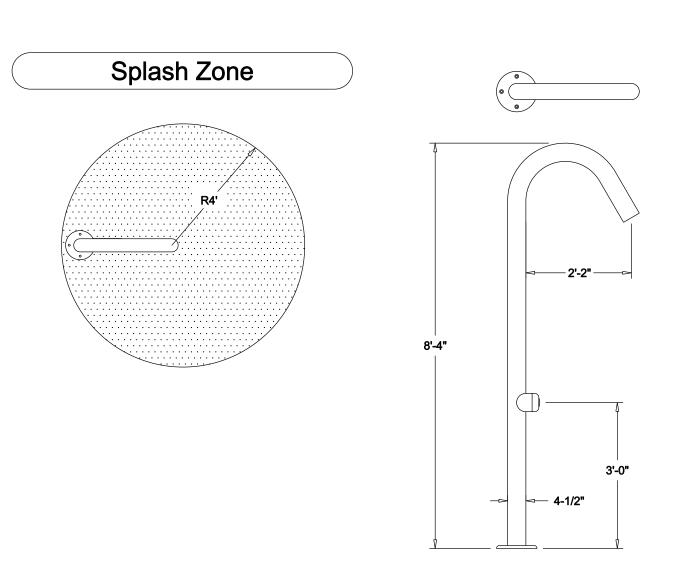

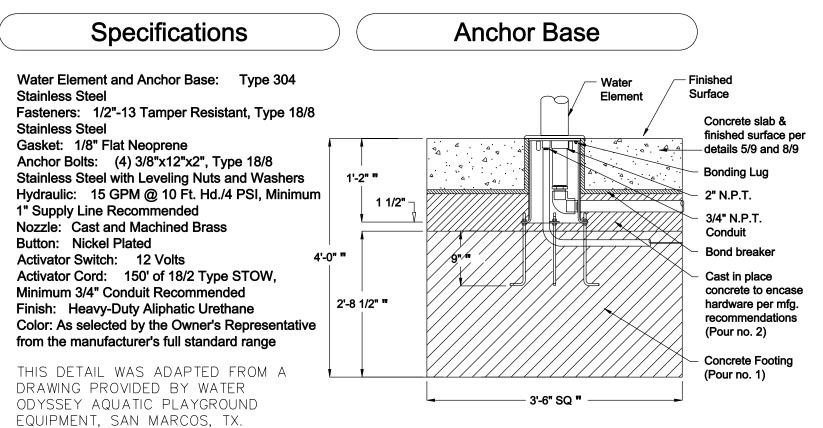

NOTE: CANE FOUNTAIN SHALL BE WATER ODYSSEY "STEP N WHOOSH" OR APPROVED EQUAL.

(E) CANE FOUNTAIN 13 / NOT TO SCALE

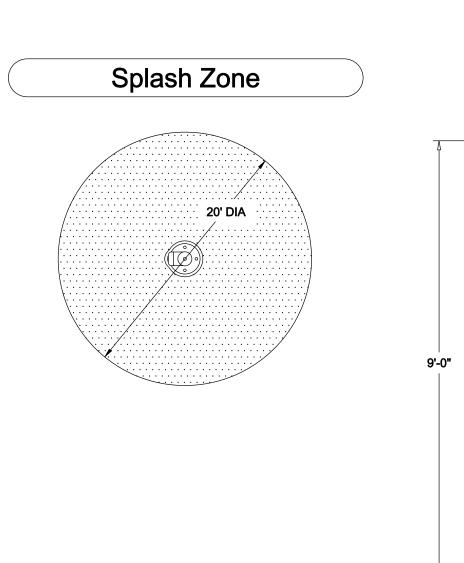

Specifications

Water Element and Anchor Base: Type 304

Anchor Bolts: (4) 3/8"x12"x2", Type 18/8

Activator Cord: 150' of #18/2 Type STOW,

Minimum 3/4" Conduit Recommended

Finish: Heavy-Duty Aliphatic Urethane

Representative from the manufacturer's full

THIS DETAIL WAS ADAPTED FROM A

Color: As selected by the Owner's

DRAWING PROVIDED BY WATER

ODYSSEY AQUATIC PLAYGROUND

Stainless Steel with Leveling Nuts and Washers

Stainless Steel

Stainless Steel

Flow Control


standard range


Button: Nickel Plated

Activator Switch: 12 Volts

Gasket: 1/8" Flat Neoprene


1-1/2" Supply Line Recommended

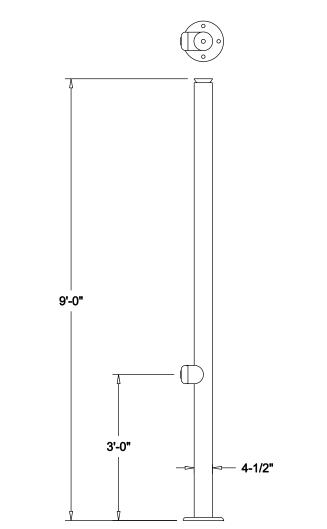

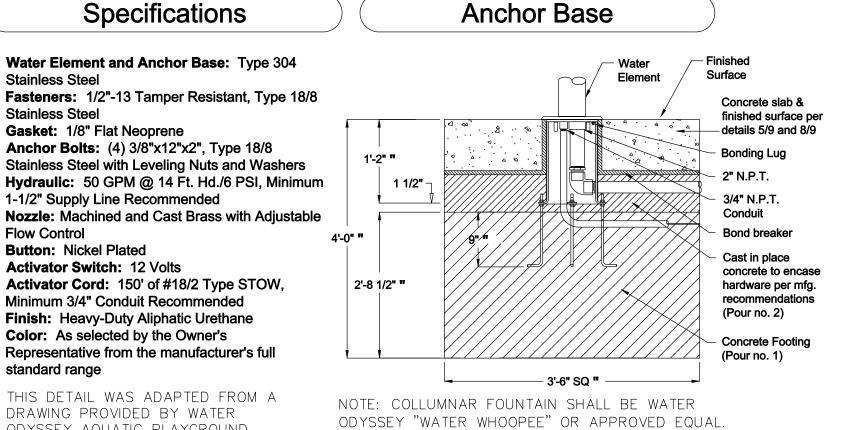


EQUIPMENT, SAN MARCOS, TX. (F) COLUMNAR FOUNTAIN

13 / NOT TO SCALE

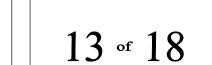

YGRO

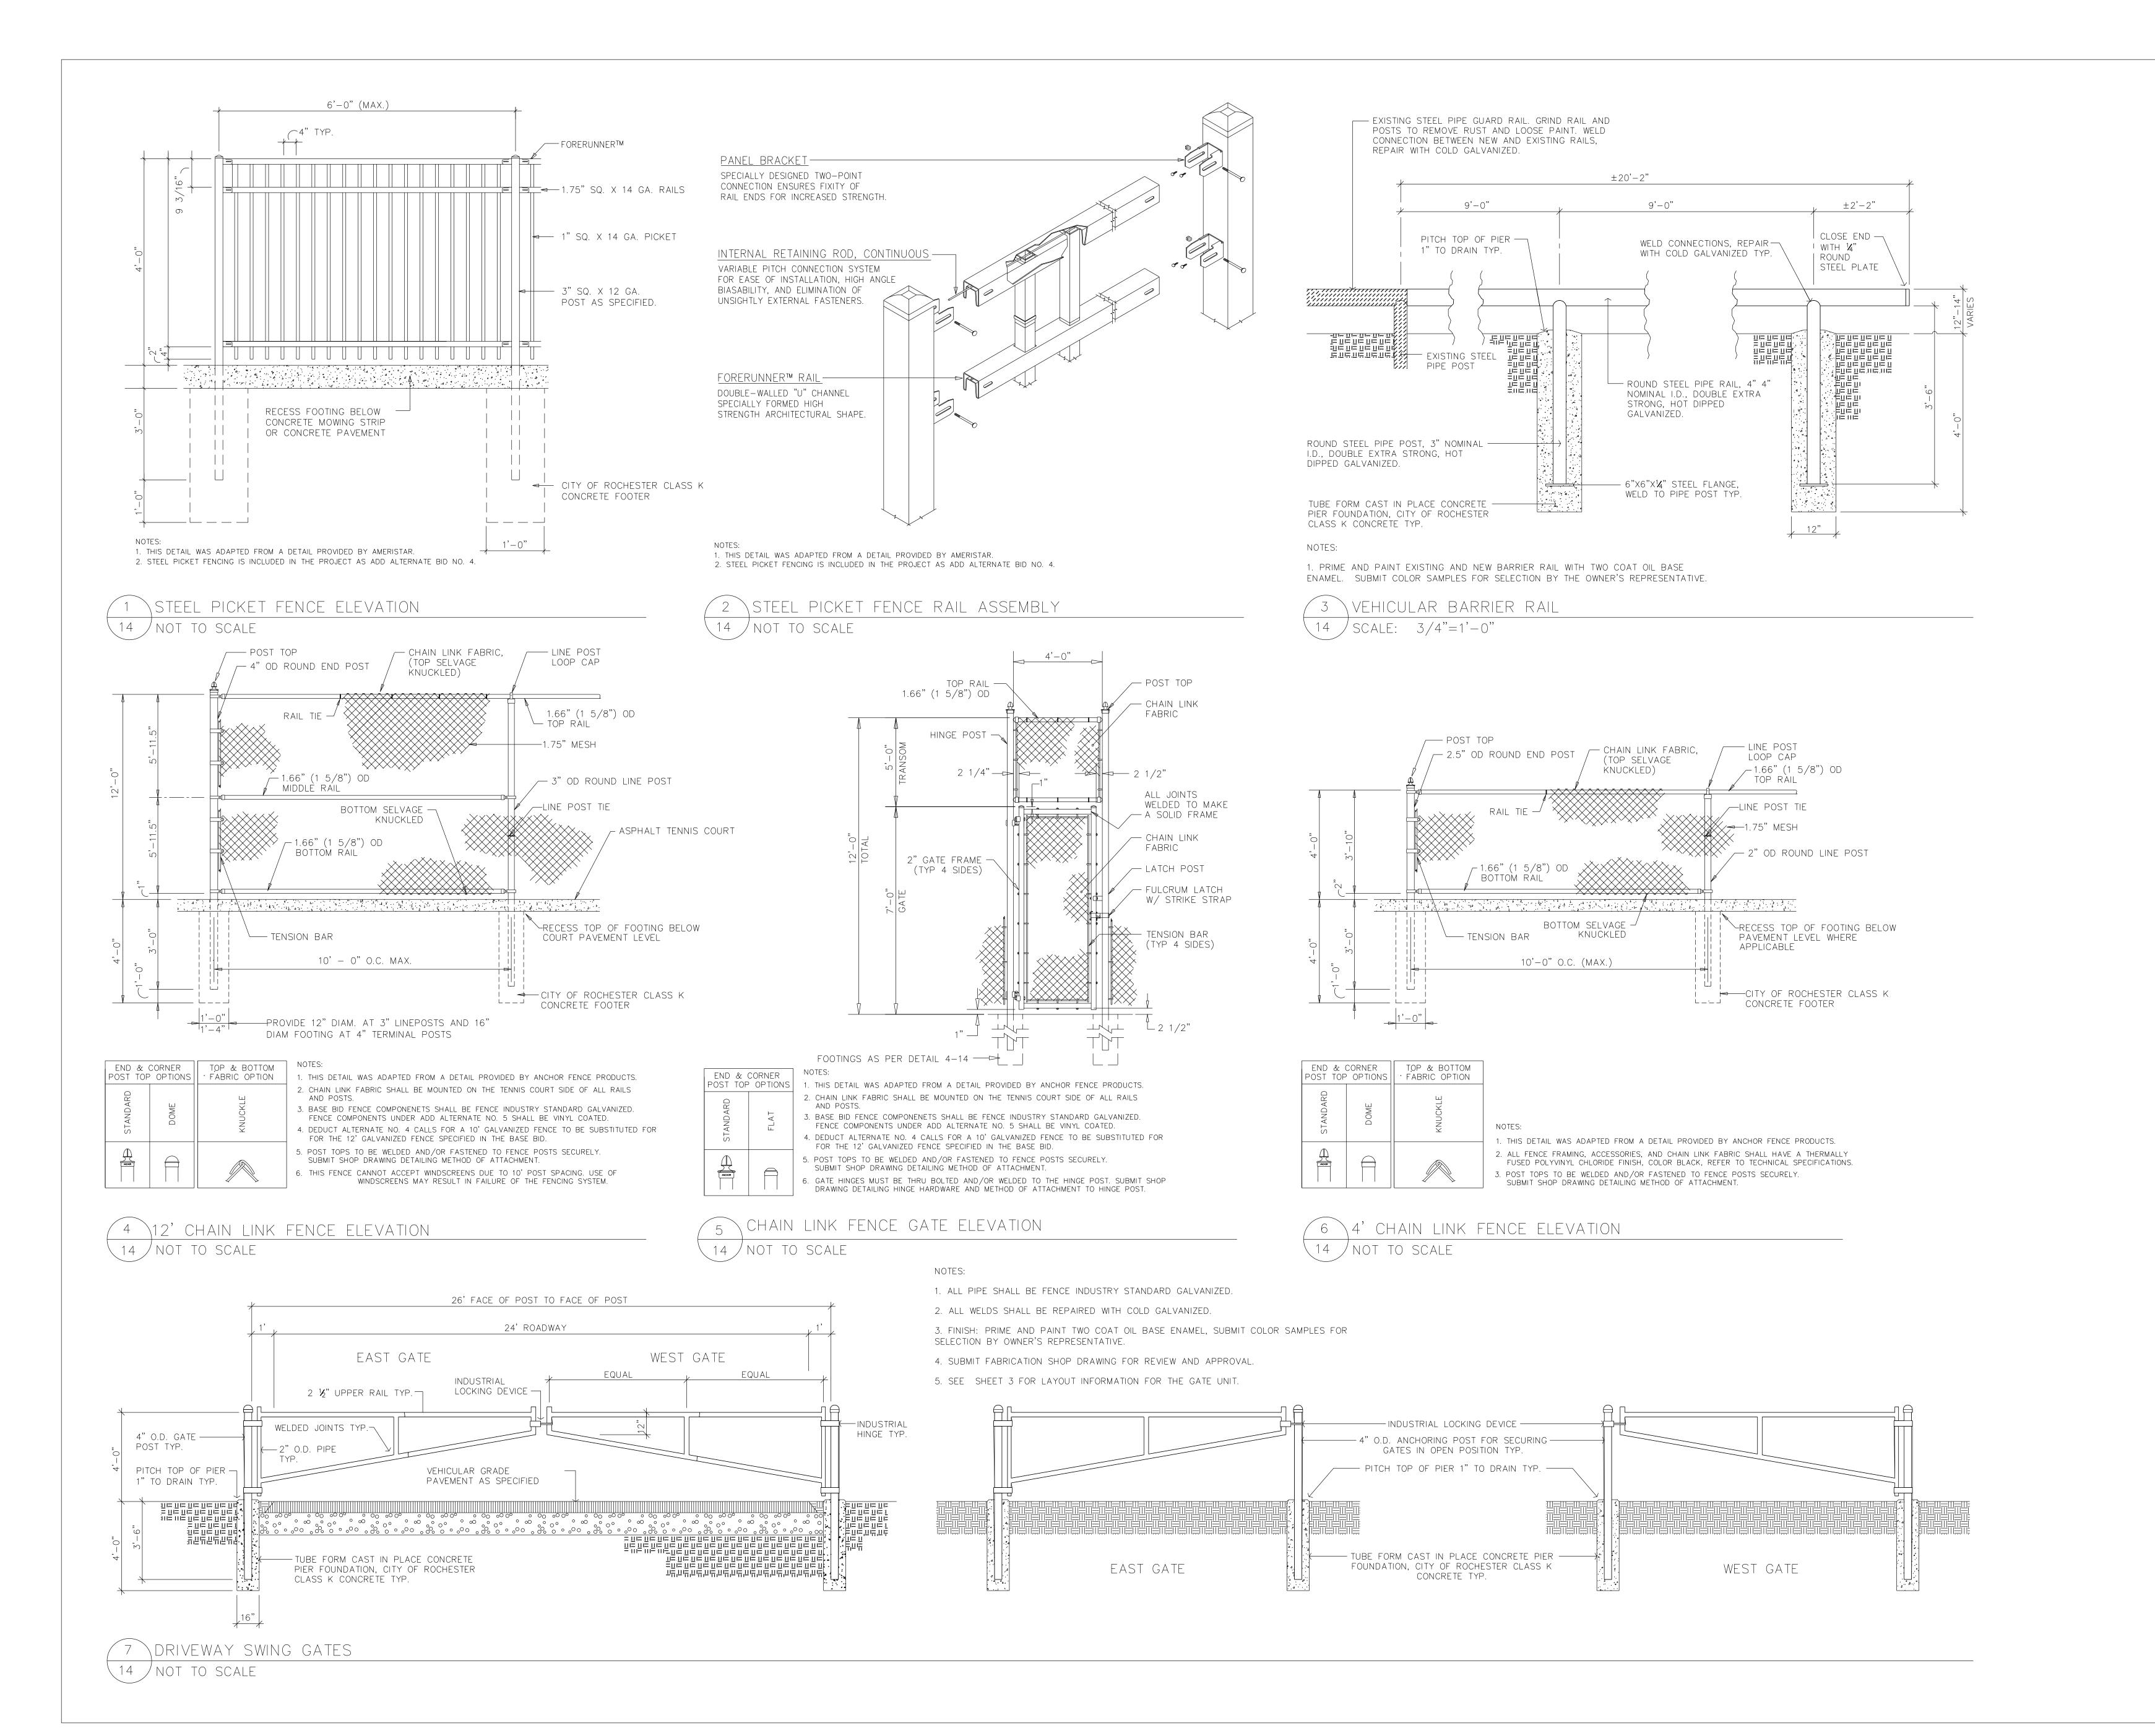

14 of 18

LANDSCAPE ARCHITECTURE and PI

Department of Environmental Services

Bureau of Engineering Services

City of Rochester, New York

cape Architect Jeffery J. Mroczek


harge Joann D. Beck, RLA


George H. Stam, PE

 sale:
 (as noted)
 (as noted)</

CARTER RECREATION CENTER
SITE IMPROVEMENTS
FENCE AND GATE DETAILS



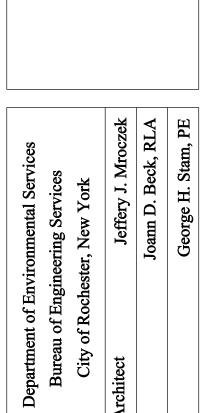

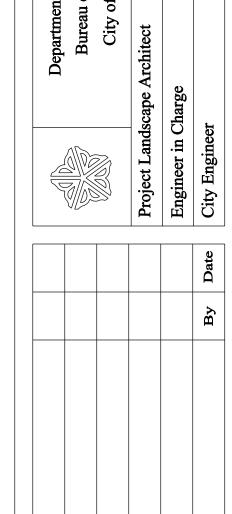

 CENTER
 Checked By:
 MHB


 Drawn By:
 RHW


 Design By:
 Bayer Assoc.

 Date:
 7/15/02

 Project No:
 20042 No.



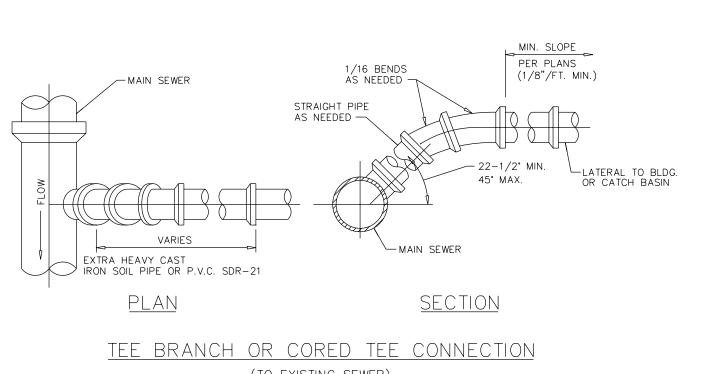

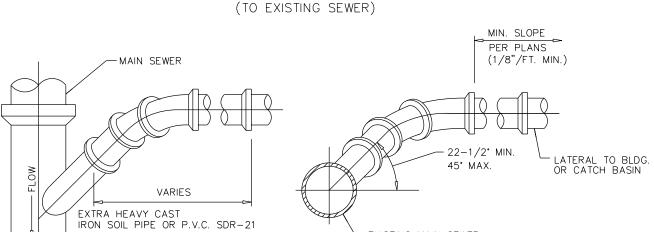

- EXISTING MAIN SEWER

<u>SECTION</u>

WYE BRANCH CONNECTION
(NEW MAIN OR ROLL-IN WYE)

PLAN

PLUMBER OR CONTRACTOR TO INSTALL:

MAIN SEWER

NOTES: (PERTAINING TO ANY WORK WITHIN THE R.O.W.)

1. PLUMBER/CONTRACTOR IS RESPONSIBLE FOR ALL EVACUATIONS OF TRENCH AND REMOVAL OF ANY CONCRETE CRADLE AND/OR ENCASEMENT PRIOR TO TAP.

2. EXPOSE FULL CIRCUMFERENCE OF MAIN, 12" WIDE ON THE HORIZONTAL (MIN. OF 6" AWAY FROM ANY HUBS)

3. PROVIDE SHORE HOLE PER O.S.H.A. SPECIFICATIONS.

4. PROVIDE TAP AND ONE (1) GENECO SADDLE W/STAINLESS STEEL STRAP FOR MAINS 8"-15". FOR MAINS > 18" A PLASTIC SADDLE WITH EPOXY MORTAR, SIKADUR 33 OR FLEXOLITH GEL WILL BE USED.

PLUMBER OR CONTRACTOR TO INSTALL:

MAIN SEWER

EXTRA HEAVY CAST IRON SOIL PIPE OR P.V.C. SDR-21

CORED HOLE

STAINLESS STEEL FULL CIRCUMFERENCE OF MAIN, 12" WIDE ON APPROVED PLASTIC SADDLE.

SPRING LINE


22-1/2* MIN.
45' MAX.


CORED CONNECTION DETAIL

(MAIN LINE SEWER ONLY)

1 GENERAL LAYOUT FOR LATERAL CONNECTIONS
15 NOT TO SCALE

1. THIS DETAIL IS ADAPTED FROM MONROE COUNTY PURE WATERS STANDARD FIGURE NO. 8.

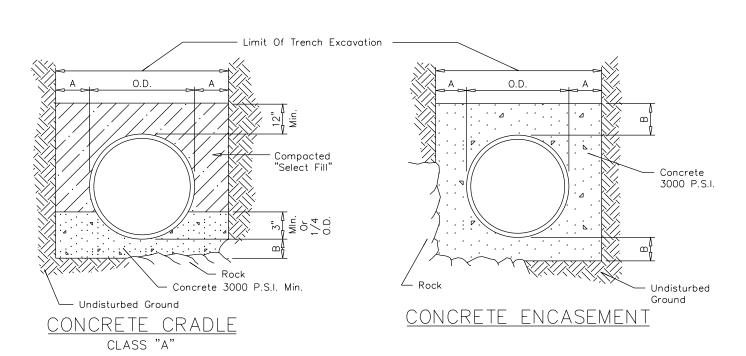

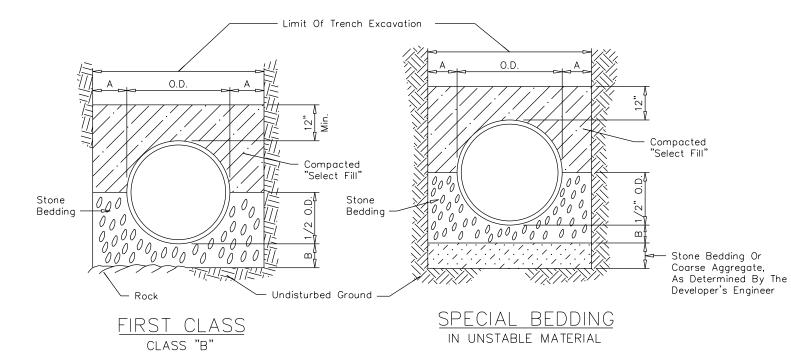

USED DURING PIPE INSTALLATION.

1. ALL STORM SEWER PIPE INSTALLATIONS SHALL COMPLY WITH THE "FIRST CLASS" DETAIL ABOVE UNLESS OTHERWISE REQUIRED BY THE OWNER'S REPRESENTATIVE.

2. TRENCH BACKFILL UNDER ALL PAVED AREAS SHALL BE NYSDOT TYPE 2 SUBBASE MATERIAL UP TO PAVEMENT SUBGRADE. TRENCH BACKFILL IN LAWN AREAS SHALL BE APPROVED SELECT FILL FROM ON SITE SOURCES.

3. SELECT FILL SHALL BE SAND, GRAVEL, AND SIMILAR MATERIAL WHICH SHALL BE FREE FROM CLAY, LOAM, ORGANIC MATERIAL, DEBRIS, AND FROZEN MATERIAL, AND SHALL CONTAIN ONLY SMALL AMOUNTS OF STONE PEBBLES, OR LUMPS OVER ONE INCH IN GREATEST DIMENSION BUT NONE OVER TWO INCHES IN GREATEST DIMENSION.

4. STONE BEDDING SHALL MEAN APPROVED IMPORTED AGGREGATE MEETING THE REQUIREMENTS OF NYSDOT STANDARD SPECIFICATION JAN. 2, 1990 EDITION, AS REVISED. SUBSECTION 703-0201 "CRUSHED STONE", PRIMARY SIZE 1.


5. COARSE AGGREGATE SHALL MEAN APPROVED IMPORTED AGGREGATE MEETING THE REQUIREMENTS OF NYSDOT STANDARD SPECIFICATION JAN. 2, 1990 EDITION, AS REVISED, SUBSECTION 703-0201 "CRUSHED STONE", PRIMARY SIZE 3.

6. THIS FIGURE APPLIES TO SANITARY, STORM, AND AND COMBINED MAINLINE AND LATERAL PIPE INSTALLATIONS AS WELL AS FORCEMAINS.

7. TEMPORARY OR PERMANENT BLOCK OR ANY OTHER TYPE OF PIPE SUPPORT IS NOT TO BE


8. THIS DETAIL IS ADAPTED FROM MONROE COUNTY PURE WATERS STANDARD FIG. NO. 1.

2 BEDDING DETAILS

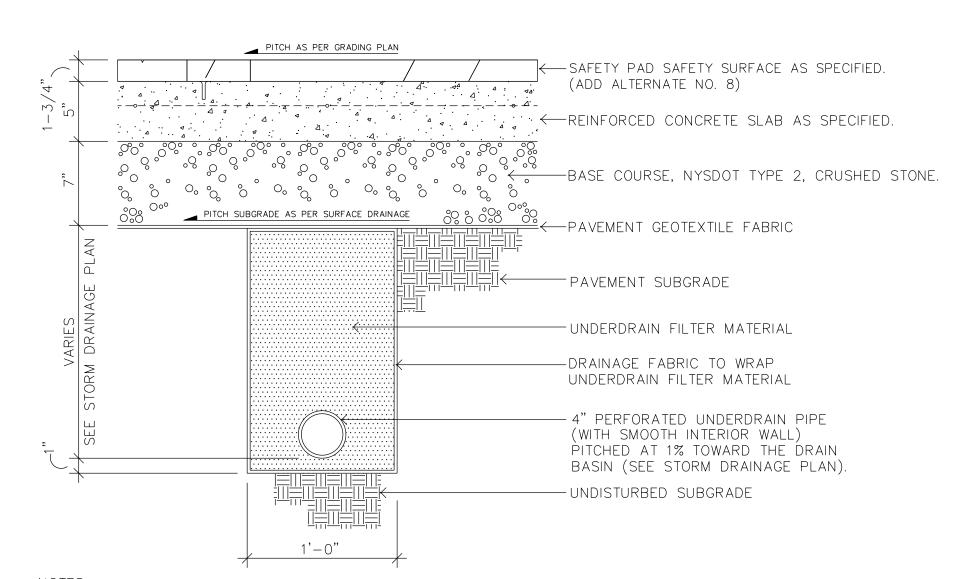

CONTRACTOR SHALL PROVIDE ALL WYES, TEES, COUPLINGS, ELBOWS, CAPS, PLUGS, AND ANY OTHER FITTINGS NECESSARY TO PROPERLY INSTALL THE UNDERDRAINAGE SYSTEM.
 CAUTION SHALL BE EXERCISED IN THE LAYOUT AND INSTALLATION OF THE UNDERDRAINAGE SYSTEM TO AVOID CONFLICTS WITH FOOTINGS, PLUMBING, AND ELECTRICAL SERVICES FOR THE SPRAY FEATURES.
 SEE STORM DRAINAGE PLAN FOR ADDITIONAL INFORMATION.

3 SPRAY PAD UNDERDRAINAGE 15 NOT TO SCALE

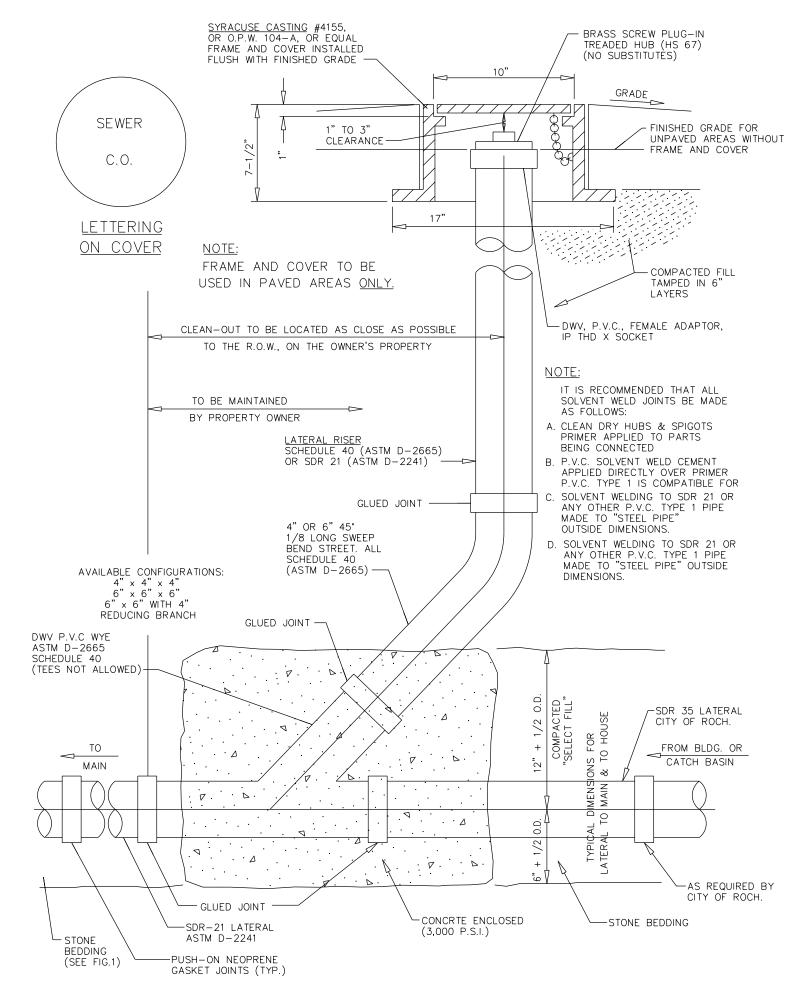


NOTES:

1. THIS DETAIL IS ADAPTED FROM MONROE COUNTY PURE WATERS STANDARD FIGURE NO. 9D.

2. CLEAN-OUT SHALL BE INSTALLED EVERY 75' MAXIMUM AND AT RIGHT-OF-WAY LINE.


7 4" OR 6" PVC CLEANOUT FOR LATERAL CONNECT.

15 NOT TO SCALE

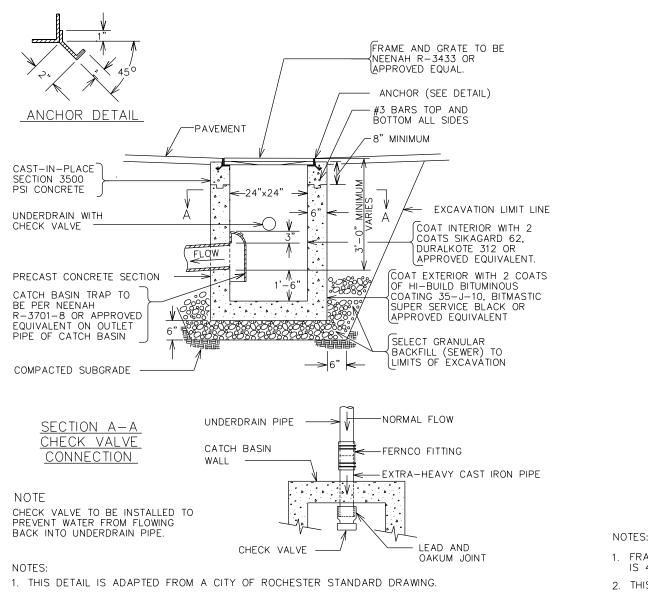


4 CATCH BASIN WITH TRAP

15 NOT TO SCALE

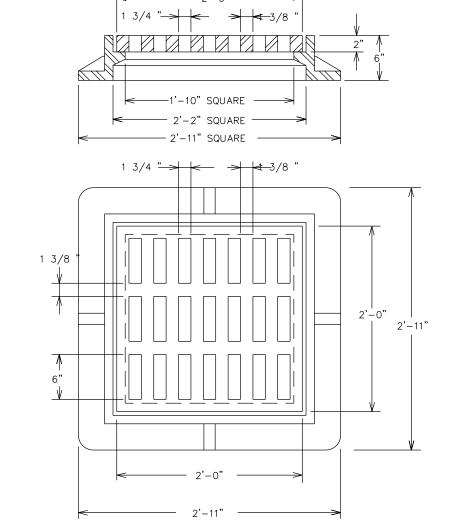



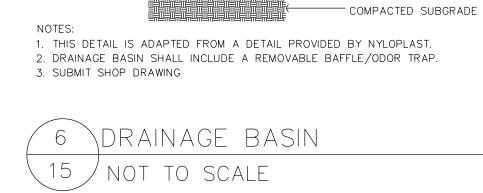

2'-0"

-DUCTILE IRON H-10 PEDESTRIAN RATED GRATE

SAFETY SURFACE AND/OR CONCRETE AS SPECIFIED

WITH SLATS AND LOCKING MECHANISM

- 24" NYLOPLAST DRAIN BASIN


--- (4) WATER TIGHT ADAPTORS FOR


-(1) WATER TIGHT ADAPTOR FOR 8" SDR-35 OUTLET


OR APPROVED EQUAL.

4" UNDERDRAIN PIPE

— 6" NO. 1 CRUSHER RUN

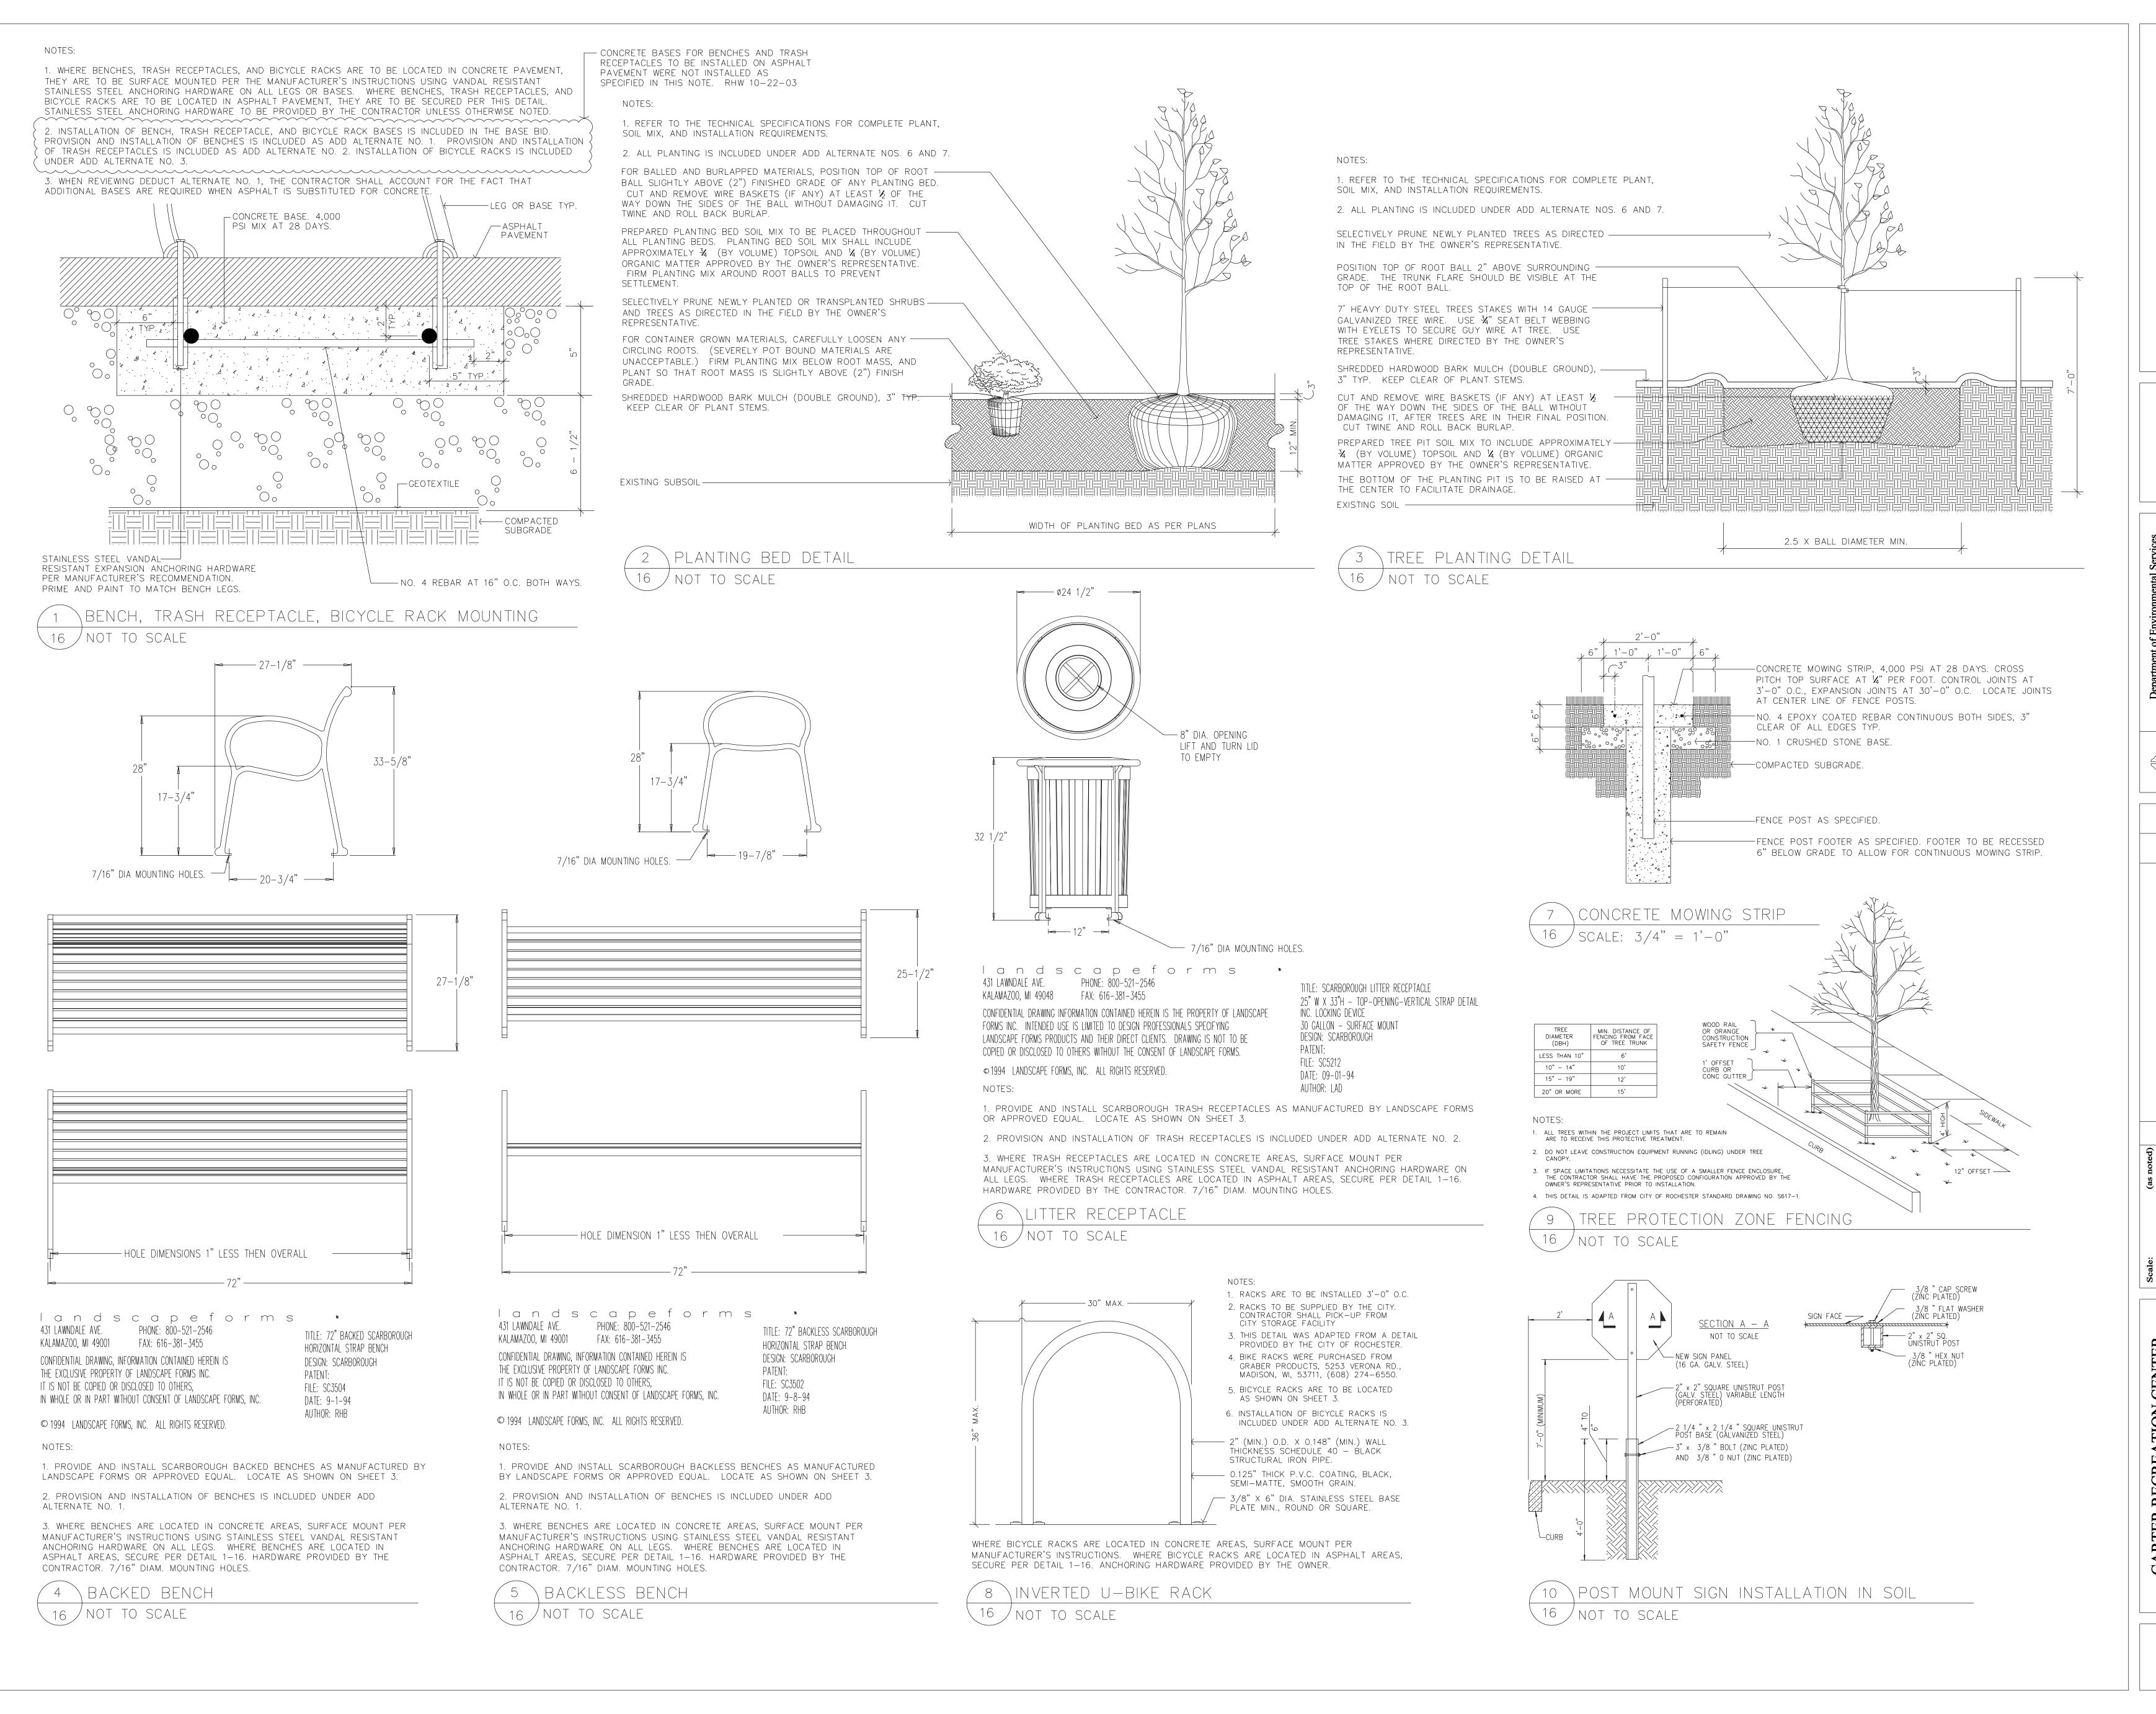

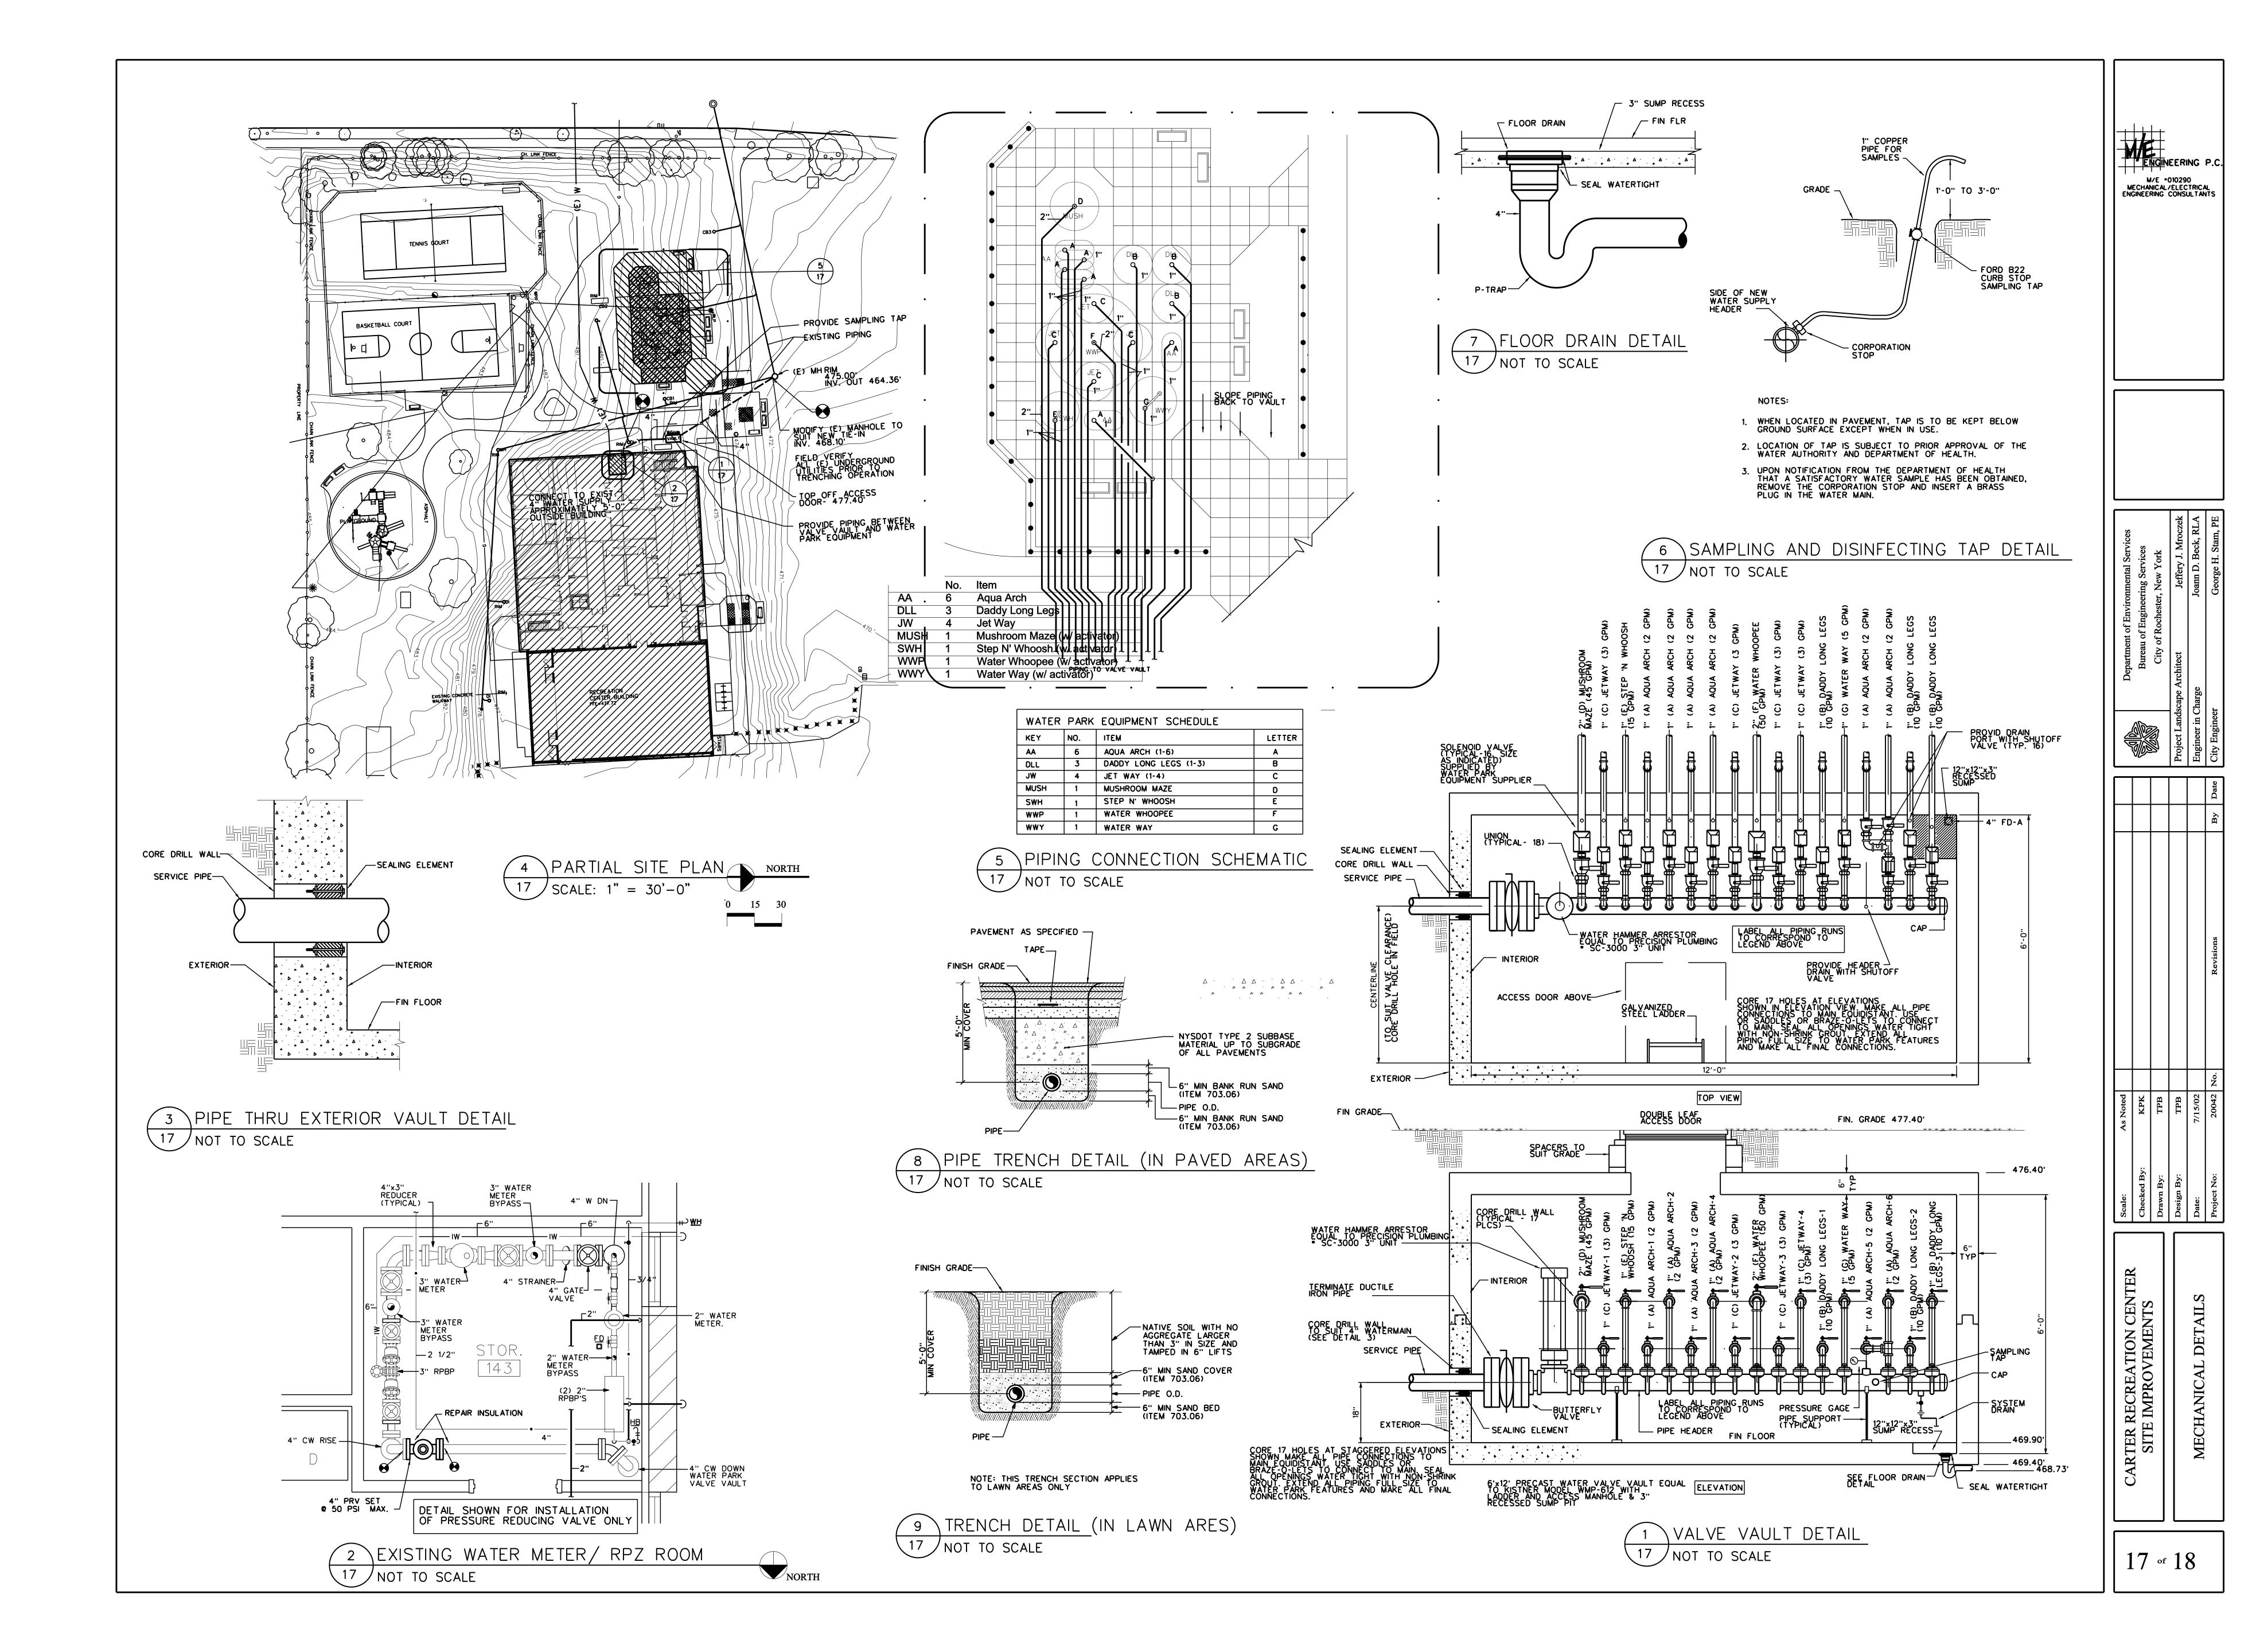

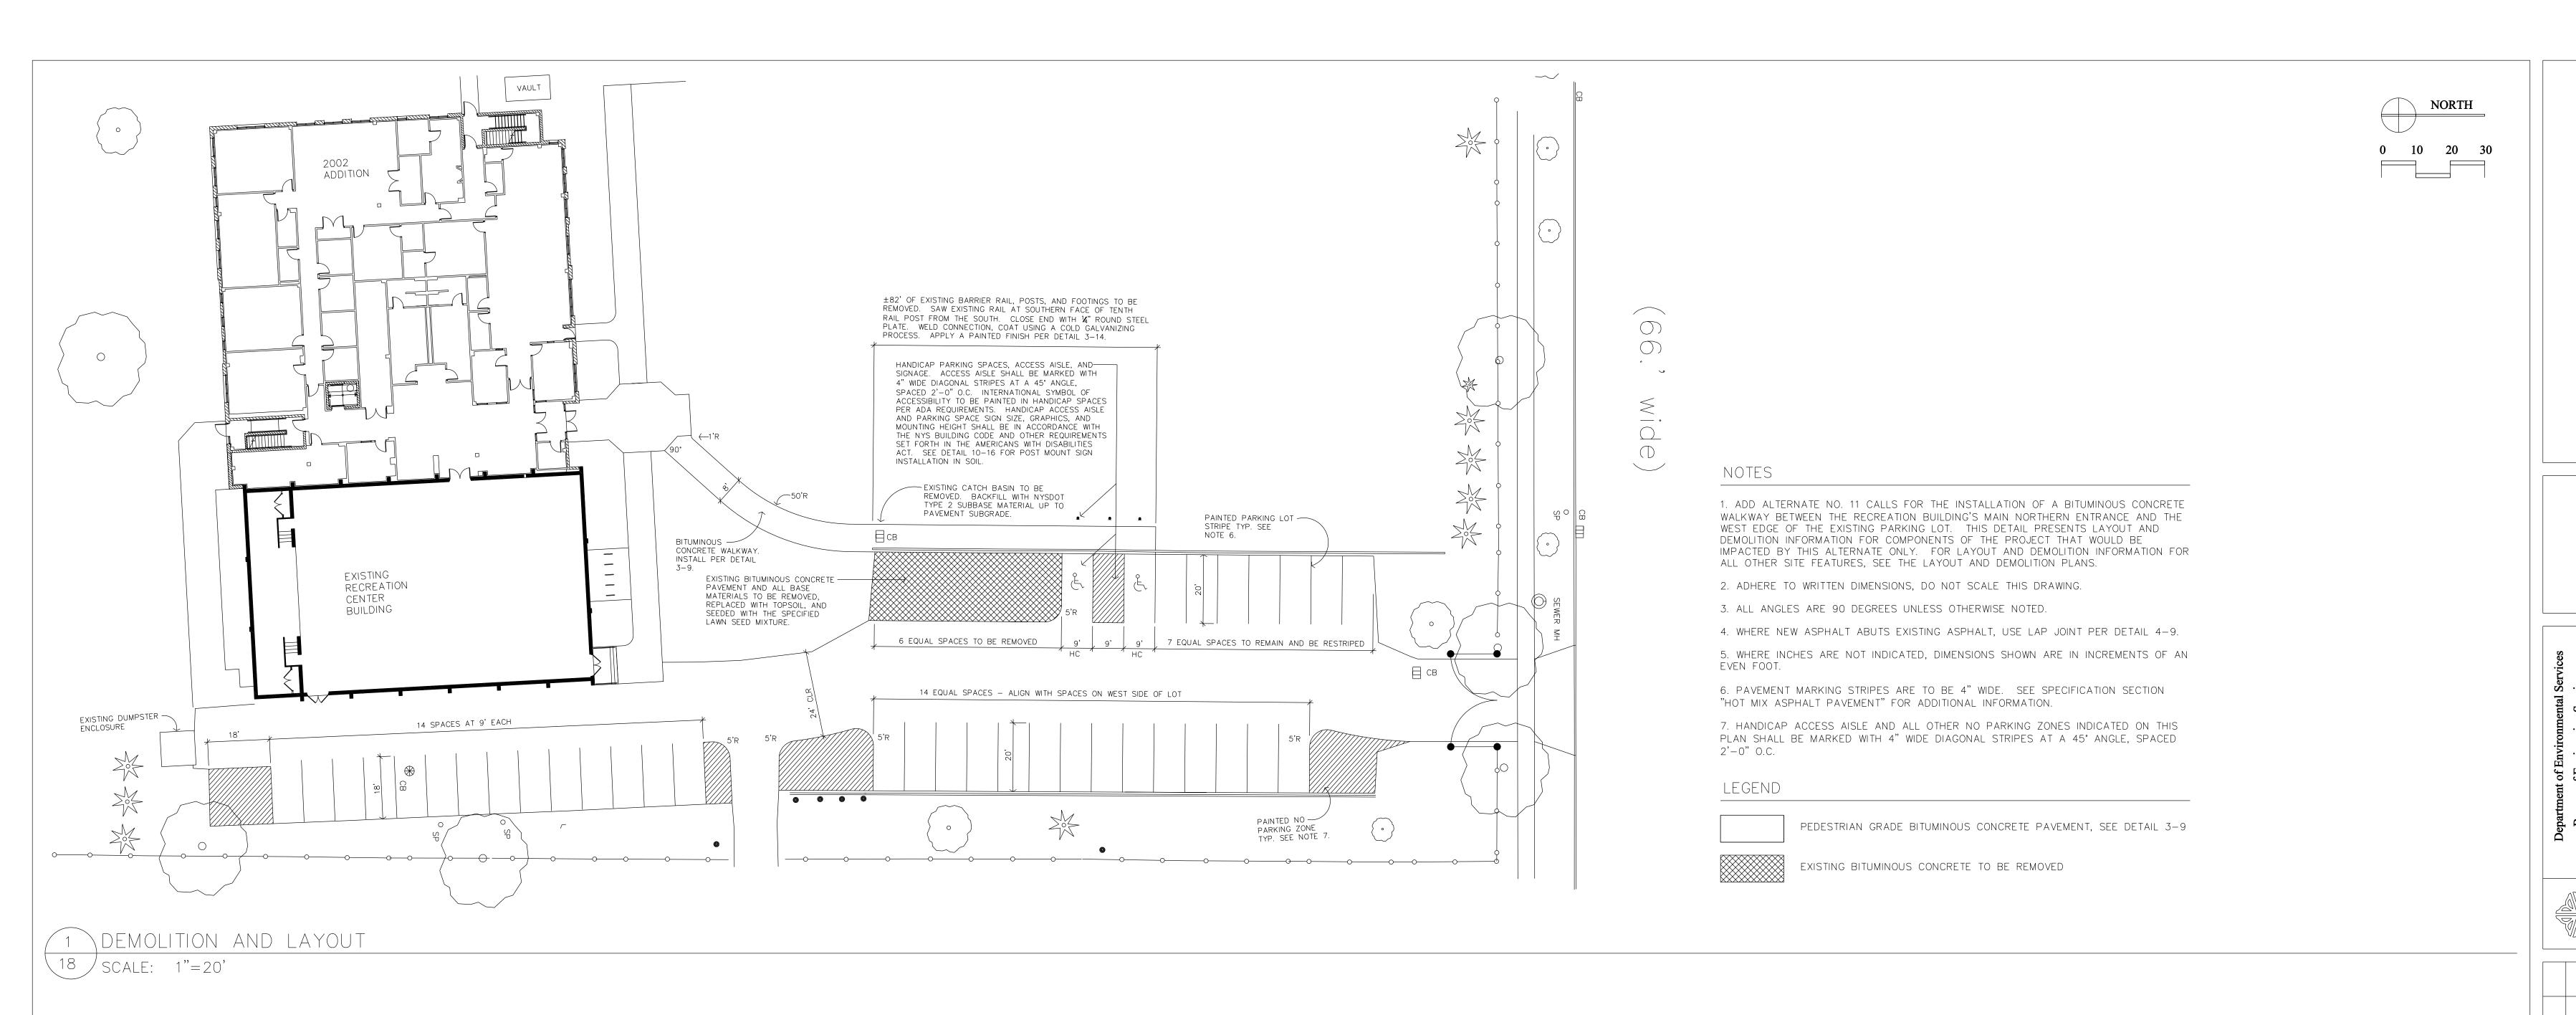

RIM = 475.00INV IN=469.29 INV OUT=464.36 SW INV IN 471.05 E INV IN 465.00 √ 79'-6"

TO FACE OF

BUILDING \leftarrow 465.75 INV - BITUMINOUS CONCRETE WALKWAY PER DETAIL 3-9. PITCH MIDDLE SEGMENT OF WALK AT 5%. PROVIDE ±10' SLOPE TRANSITION ZONES WHERE WALKWAY MERGES WITH OTHER PAVEMENTS. TIE NORTHERN END OF WALK INTO EXISTING PARKING LOT FLEVATIONS. WALKWAY TO HAVE A 1% CROSS PITCH • • TO THE WEST. RECREATION CENTER BUILDING FFE = 477.72472 EXISTING PARKING LOT EXISTING A CB

2 GRADING AND STORM DRAINAGE

 $\sqrt{18}$ \int SCALE: 1"=20'

NOTES

MARCH 12, 1997.

1. ADD ALTERNATE NO. 11 CALLS FOR THE INSTALLATION OF A BITUMINOUS CONCRETE WALKWAY BETWEEN THE RECREATION BUILDING'S MAIN NORTHERN ENTRANCE AND THE WEST EDGE OF THE EXISTING PARKING LOT. THIS DETAIL PRESENTS GRADING AND STORM DRAINAGE INFORMATION FOR COMPONENTS OF THE PROJECT THAT WOULD BE IMPACTED BY THIS ALTERNATE ONLY. FOR GRADING AND STORM DRAINAGE INFORMATION FOR ALL OTHER SITE FEATURES, SEE THE GRADING AND STORM DRAINAGE PLANS.

1. SURVEY INFORMATION SHOWN ON THIS PLAN WAS OBTAINED FROM A SURVEY TITLED "CARTER STREET RECREATION CENTER — PLAYGROUND AND SITE TOPOGRAPHY" PREPARED BY THE CITY OF ROCHESTER DEPARTMENT OF ENVIRONMENTAL SERVICES, BUREAU OF ENGINEERING SERVICES, OFFICE OF MAPS AND SURVEYS, AND DATED

2. ALL PROPOSED ELEVATIONS SHOWN ARE FINISHED GRADE ELEVATIONS.

3. THE CONTRACTOR SHALL ESTABLISH FINISH GRADE STAKES IN ACCORDANCE WITH THIS PLAN (AND IN CONJUNCTION WITH THE LAYOUT PLAN) PRIOR TO THE START OF CONSTRUCTION. FINISH GRADES SHALL BE REVIEWED WITH THE OWNER'S REPRESENTATIVE PRIOR TO THE START OF CONSTRUCTION. MAINTAIN GRADE STAKES, WHERE FEASIBLE, THROUGHOUT THE CONSTRUCTION PROCESS.

4. ANY DISCREPANCIES IN PROPOSED ELEVATIONS NOTED BY THE CONTRACTOR DURING THE CONSTRUCTION PROCESS SHALL BE REPORTED IMMEDIATELY TO THE OWNER'S REPRESENTATIVE FOR DECISION.

5. ALL FILL AND BACKFILL MATERIALS MUST BE THOROUGHLY COMPACTED AS THEY ARE PLACED. REFER TO THE TECHNICAL SPECIFICATIONS FOR DETAILED COMPACTION INFORMATION INCLUDING THE MAXIMUM LOOSE DEPTH LAYER THICKNESS ALLOWABLE AND THE PERCENTAGE OF MAXIMUM DRY DENSITY REQUIREMENTS FOR THE FILLING AND BACKFILLING OPERATIONS.

6. THE CONTRACTOR SHALL BE RESPONSIBLE FOR THE COST OF ALL CUT AND FILL OPERATIONS AND MATERIALS NECESSARY TO ACHIEVE THE ELEVATIONS SPECIFIED ON THIS PLAN, INCLUDING THE OFF SITE DISPOSAL OF ANY EXCESS MATERIALS IN A LEGAL MANNER.

7. REFER TO THE TECHNICAL SPECIFICATIONS FOR ADDITIONAL REQUIREMENTS RELEVANT TO GRADING AND OTHER EARTHWORK OPERATIONS.

8. REFER TO THE UTILITY AND STORM DRAINAGE PLANS FOR THE INVERT ELEVATIONS OF THE UNDERGROUND PIPING NETWORK, AND FOR UTILITY STRUCTURES LAYOUT INFORMATION.

9. EXISTING CONTOURS SHOWN ON THIS PLAN DO NOT REFLECT EARTHWORK THAT HAS BEEN PERFORMED AS PART OF THE 2002 BUILDING ADDITION PROJECT.

10. THIS PLAN REQUIRES APPROVAL AND ISSUANCE OF A PLUMBING PERMIT FROM THE CITY OF ROCHESTER.

11. FLOOR DRAINS, IF CONSTRUCTED, SHALL BE CONNECTED TO THE SANITARY SEWER. FLOOR DRAINS DO NOT INCLUDE FOUNDATION/FOOTER DRAINS.

LEGEND

PEDESTRIAN GRADE BITUMINOUS CONCRETE PAVEMENT, SEE DETAIL 3-9.

—— 476' —— EXISTING CONTOUR LINE

+ 476.22 EXISTING SPOT ELEVATION
+ 476.22 PROPOSED SPOT ELEVATION

+HP HIGH POINT ELEVATION

CB EXISTING CATCH BASIN

RIM DRAINAGE STRUCTURE TOP OF RIM ELEVATION

INV DRAINAGE STRUCTURE INVERT ELEVATION

MH EXISTING MANHOLE

OCB1 PROPOSED CATCH BASIN NO. 1, SEE DETAIL 4-15

oco CLEANOUT

					Revisions
					No.
1"=20' (or as noted)	MHB	RHW	Bayer Assoc.	7/15/02	20042 No.
Scale: 1"	Checked By:	Drawn By:	Design By:	Date:	Project No: